

CITY OF HERMOSA BEACH DEPT. **OF PUBLIC WORKS PUBLIC RIGHT OF WAY REQUIREMENTS**

THE FOLLOWING STANDARD CONDITIONS APPLY TO ALL PROJECTS REQUIRING A BUILDING PERMIT UNLESS IT IS DETERMINED UNNECESSARY BY THE PUBLEC WORKS DIRECTOR. A GRADING PLAN IS REQUIRED FOR ANY PROJECT REQUIRING A BUILDING PERMIT UNLESS WAIVED BY THE DIRECTOR OF PUBLIC WORKS. ALL CONSTRUCTION MUST COMPLY WITH THE CITY OF HERMOSA BEACH AND LOS ANGELES COUNTY STANDARDS.

PLAN REQUIREMENTS

1. ALL PLANS FOR NEW AND/ OR ADDITIONS OVER FOUR HUNDRED (400) SQUARE FEET MUST BE SUBMITTED TO THE PUBLIC WORKS DEPARTMENT, PRIOR TO CONSTRUCTION, FOR PUBLIC RIGHT OF WAY REQUIRED IMPROVEMENTS. 2. AN ENGINEERING PLAN SHOWING PROPOSED STORMWATER CONTROL FOR THE PROJECT SHALL BE MADE A PART OF THE PLAN. THIS PLAN SHALL SHOW THE EXISTING STREET CROSS SECTIONS, ELEVATIONS AND EXISTING CURB AND GUTTER ELEVATIONS FOR A DISTANCE OF ONE HUNDRED FEET (100') ON EACH SIDE OF THE PROPOSED PROJECT, AND THE PROPOSED ELEVATIONS FOR THE PLANNED PROJECT.

3. A SURVEY OF THE PROJECT WILL BE REQUIRED WITH SURVEY POINTS SET AT THE CENTER LINE OF THE STREET AND OFFSET POINTS EITHER ON THE TOP OF THE CURB OR IN THE SIDEWALK. ALL SURVEY POINTS SHALL BE RE-ESTABLISHED IF THEY ARE REMOVED OR DESTROYED DURING CONSTRUCTIONS.

PERMIT REQUIREMENTS

1. A SEWER CAP PERMIT MUST BE ACQUIRED BEFORE A DEMOLITION PERMIT WILL BE ISSUED. 2. ALL WORK DONE WITHIN THE PUBLIC RIGHT-OF-WAY SHALL BE DONE BY A CURRENTLY LICENSED CONTRACTOR WITH A CLASS ``A", ``C-12" OR ``C-34" LICENCE FOR ALL TRENCHING AND PAVING OR A CLASS "C-08" LICENSE FOR ALL CONCRETE WORK. A CLASS ``B" LICENSE MAY BE ACCEPTABLE FOR MINOR CURB, GUTTER AND SIDEWALK WORK CONSTRUCTED IN CONJUNCTION WITH SINGLE FAMILY RESIDENTIAL STRUCTURE. 3. ALL CONTRACTORS WORKING ON PUBLIC WORKS PROJECTS MUST HAVE A CURRENT CITY OF HERMOSA BEACH

BUSINESS LICENSE. PUBLIC WORKS PERMITS SHALL BE REQUIRED FOR ANY SCAFFOLDING, UTILITY TRENCHING, LUMBER DROPS CRANES, DUMPSTERS, ETC. ON PUBLIC PROPERTY. THE PUBLIC WORKS PERMIT MUST BE ON THE JOB SITE AND AVAILABLE FOR REVIEW BY CITY OFFICIALS AT ALL TIMES. ANY OF THE WORK REQUIRING PERMIT(S) AND STARTED WITHOUT NECESSARY PERMIT(S) SHALL RESULT IN THE JOB BEING STOPPED UNTIL THE PERMIT(S) ARE OBTAINED AND A

DOUBLE FEE FOR PERMIT(S) WILL BE CHARGED. 5. A CASH DEPOSIT WILL BE REQUIRED FOR ALL WORK WITHIN THE CITY RIGHT-OF-WAY. THE AMOUNT OF THE SAID DEPOSIT WILL BE DETERMINED BY THE ENGINEERING DEPARTMENT (THE MINIMUM DEPOSIT IS SET AT \$1,600). THE CASH DEPOSIT WILL BE REQUIRED FOR EACH PROJECT AND WILL NOT BE TRANSFERRED FROM ON PROJECT TO ANOTHER. AFTER ALL IMPROVEMENTS ARE IN PLACE AND APPROVED THE CASH DEPOSIT WILL BE REFUNDED. 6. ANYTHING EXISTING OR TO BE CONTRUCTED ON CITY RIGHT-OF-WAY OTHER THAN REQUIRED CITY IMPROVEMENTS WILL REQUIRE AN ENCROACHMENT PERMIT.

7. A CONSTRUCTION PERMIT WILL NOT BE ISSUED UNTIL PROPER PERMITS HAVE BEEN ISSUED FROM OTHER AGENCIES SUCH AS CALTRANS, LOS ANGELES COUNTY, SANITATION DISTRICT, WATER QUALITY CONTROL BOARD, ETC. IF SAID PERMITS ARE REQUIRED. 8. APPLICANT SHALL MAINTAIN AND KEEP IN FORCE AT ALL TIMES DURING CONSTRUCTION A POLICY OF LIABILITY

INSURANCE, NAMING THE CITY AS ADDITIONALLY INSURED IN THE AMOUNT OF ONE MILLION DOLLARS (\$1,000,000) MINIMUM

9. SECTION 4216/4217 OF THE GOVERNMENT CODE REQUIRES A DIG ALERT IDENTIFICATION NUMBER BE ISSUED BEFORE A "PERMIT TO EXCAVATE" WILL BE VALID. FOR YOUR DIG ALERT I.D. NUMBER CALL UNDERGROUND SERVICE ALERT AT (800) 227-2600 TWO WORKING DAYS BEFORE YOU DIG.

CONSTRUCTION REQUIREMENTS

1. ALL EXISTING CURB, GUTTER, CONCRETE DRAINAGE SWALE, SIDWALK AND DRIVEWAY WITHIN THE PROPERTY LIMITS SHALL BE REMOVED AND REPLACED, UNLESS IT IS DETERMINED BY THE CITY PUBLIC WORKS INSPECTOR THAT THEY MEET THE CURRENT CITY STANDARDS. 2. IF THE CURB, GUTTER, CONCRETE DRAINAGE SWALE, SIDEWALK OR DRIVEWAY DO NOT EXIST THEY SHALL BE CONSTRUCTED.

- CURB AND GUTTER SHALL BE POURED MONOLITHICALLY, BUT SEPARATE FROM SIDEWALK.
- ALL DRIVEWAY SLOPES TO BE 2% FROM TOP OF CURB OR LIP OF SWALE TO RIGHT-OF-WAY.

WHEELCHAIR RAMPS ARE REQUIRED ON CORNER LOTS AND MAY BE REQUIRED AT OTHER LOCATIONS. 6. GRAFFITI IN FRESHLY POURED CONCRETE SHALL BE REMOVED BY WHATEVER MEANS NECESSARY UP TO AND INCLUDING REMOVE AND REPLACEMENT.

7. ALL LANDSCAPING WITHIN THE PUBLIC RIGHT-OF-WAY MIST HAVE AN AUTOMATIC IRRIGATION SYSTEM. 8. ALL LANDSCAPE IRRIGATION MUST MEET CURRENT CITY REQUIREMENTS FOR PROPER INSTALLATION. ALL SITE DRAINAGE SHALL BE TERMINATED AT PUBLIC WAY VIA NON-EROSIVE DEVICE PER HBMC SUMP PUMPS REQUIRE 2" ABS. DISCHARGE LINE PER PUMP TO TERMINATE AT CURB.

10. SEWER LATERALS MUST BE A MINIMUM 4" V.C.P. PIPE FOR SINGLE FAMILY HOMES ONE LATERAL PER UNIT. 11. SEWER LATERALS FOR CONDOMINIUMS SHALL BE A MINIMUM 6" V.C.P. PIPE WITH A MINIMUM OF 4 UNITS PER LATERAL.

12. EXISTING SEWER LATERALS MAY BE USED IF THE CRITERIA OUTLINED IN NOTES (10) AND (11) ARE MET AND A VIDEO TAPE HAS BEEN PROVIDED TO THE PUBLIC WORKS DEPARTMENT AND IF THE VIDEO SHOW THE LATERAL TO BE IN GOOD CONDITION.

DAMAGE TO PUBLIC PROPERTY

1. ANY ASPHALT OR CONCRETE STREET WITHIN THE PROPERTY LIMITS THAT IS DAMAGED PRIOR TO CONSTRUCTION SHALL BE REMOVED AND REPLACED TO MEET CURRENT CITY STANDARDS. 2. ANY PUBLIC PROPERTY DAMAGED DURING CONSTRUCTION SHALL BE REPLACED IN KIND TO THE SATISFACTION OF THE CITY PUBLIC WORKS INSPECTOR. THE CITY SHALL AT ITS DISCRETION AND IN THE INTEREST OF PUBLIC SAFETY, MAKE ANY REPAIRS DEEMED NECESSARY, THE COST OF WHICH WILL BE DEDUCTED FROM THE DEPOSIT HELD BY THE CITY.

UTILITY REQUIREMENTS

1. ANY UTILITY CUT WITHIN CITY STREETS SHALL BE EITHER PERPENDICULAR OR PARALLEL TO THE CENTER OF THE STREET. DIAGONAL CUTS WILL NOT BE ALLOWED. 2. BACKFILL OF TRENCHES SHALL BE DONE IN LIFTS OF NO MORE THAN TWO FEET (2) WITH WATER JET AND

APPROPRIATE COMPACTION TOOL USED BETWEEN EACH LIFT. ONE SACK SLURRY MIX CAN BE USED IN PLACE OF NATIVE SOIL.

3. AFTER BACKFILLING THE TRENCH A TEMPORARY ASPHALT PATCH SHALL BE PLACED OVER THE TRENCH AND REMAIN FOR A MINIMUM OF TWO (2) WEEKS. 4. THE PERMANENT PATCH WILL REQUIRE A ONE FOOT (1) MINIMUM OVERCUT ON EACH SIDE OF THE TRENCHLINE

PRIOR TO THE FINAL PATCH, THE FINAL PATCH SHALL BE A MINIMUM OF FIVE INCHES (5) THICK OR ONE INCH (1) THICKER THAN THE EXISTING PAVEMENT 5. THE FINAL PATCH IN ASPHALT STREETS TO BE DONE IN TWO LIFTS, A BASE OF 3" MINIMUM 3/4 AGGREGATE AND A

TOP LIFE OF 2" OF 3/8" AGGREGATE. ALL EDGES OF THE CUT ASPHALT TO BE PACKED THOUOUGHLY AND THE PATCH COMPACTED BY MECANICAL MEANS TO A HEIGHT SLIGHTLY HIGHER THAN THE EXISTING ASPHALT AND ALL EDGES TO BE TACKLED. 6. THE FINAL PATCH ON CONCRETE STREETS TO BE CLASS 3500 P.S.I. (7 SACK), EXISTING CONCRETE TO BE DRILLED

TWO AND HALF INCHES (2 1/2") BELOW THE SURFACE TO A DEPTH OF 6" MINIMUM AND DOWELLED WITH #5 REBAR ON 18" SPACING. FINISH TO MATCH EXISTING OR MEDIUM BROOM. 7. ALL UTILITY BOXES ARE TO BE NEW AND ADJUSTED TO THE NEW GRADE. KEEP ALL UTILITY BOXES OUT OF DRAINAGE FLOW LINES, CURB RETURNS, DRIVEWAY APPROACH AND WHEEL CHAIR RAMPS IF AT ALL POSSIBLE.

8. ALL UTILITIES SHALL BE UNDER GROUND. CONTRACTOR TO CONTACT THE SOUTHERN CALIFORNIA EDISON COMPANY FOR THEIR REVIEW.

STORM RUNOFF REQUIREMENTS

1. PRECAUTIONS SHALL BE TAKEN TO PREVENT ANY CONSTRUCTION MATERIAL DEBRIS OR RUNOFF FROM ENTERING ANY CITY RIGHT- OF-WAY OR COUNTY STORM DRAIN. A SAW CUT RESIDUE MUST BE RETAINED WITH BERMS OR SAND BAGS AND VACUMMED TO PREVENT IT FROM ENTERING INTO ANY STORM DRAIN SYSTEM. 2. SANDBAGS ARE REQUIRED FOR EROSION CONTROL DURING THE RAINY SEASON. OCTOBER 15th THROUGH APRIL 15th AND MAY BE REQUIRED AT OTHER TIMES.

3. A POLLUTION PREVENTION PLAN IS REQUIRED FOR CONSTRUCTION SITES TWO ACRES OR MORE.

SUCH PROJECTS MUST CAPTURE AND TREAT THE FIRST 3/4" INCH OF RAIN RUNOFF FROM THEIR SITE.

- 4. STORM WATER MITIGATION PLANS ARE REQUIRED FOR THE FOLLOWING PROJECTS: A. SINGLE FAMILY HILLSIDE DEVELOPMENTS WITH A SLOPE GREATER THAN 25%.
- B. 10+ HOME DEVELOPMENTS
- PARKING LOTS, 25 SPACES OR MORE.
- D. RESTAURANTS E. SERVICE STATIONS.
- F. AUTO REPAIR FACILITIES.

G. 100,000 SQUARE FEET COMMERCIAL DEVELOPMENTS.

JOB SAFETY REQUIREMENTS

1. PROPER BARRICADES SHALL BE PLACED AROUND ANY CONSTRUCTION SITE WITHIN THE PUBLIC RIGHT-OF-WAY. THESE BARRICADES SHALL COMPLY WITH THE REQUREMENTS OF THE WORK AREA TRAFFIC CONTROL HANDBOOK (W.A.T.C.H.) MANUAL. ANYTIME A STREET OR ALLEY IS GOING TO BE CLOSED THE APPROVAL OF THE PUBLIC WORKS DEPARTMENT IS REQUIRED. ALSO THE POLICE AND FIRE DEPARTMENT DISPATCHER, SHALL BE NOTIFIED (310) 318-0313.

3. STREET, ALLEY AND SIDEWALK CLOSURES REQUIRE PROPER SIGNAGE AND BARRICADES AS REQUIRED BY THE (W.A.T.C.H.) MANUAL 4 ALL CONSTRUCTION FENCES ARE TO BE BEHIND THE SIDEWALK AND ALL CONSTRUCTION MATERIAL WITHOUT PERMITS ARE TO BE BEHIND THE FENCE. SIDEWALKS ARE TO BE ACCESSIBLE

TO PEDESTREANS AT ALL TIMES. 5. IF SCAFFOLDING IS NEEDED ON THE PUBLIC RIGHT OF WAY, A PERMIT WILL BE REQUIRED AND ALL PROVISIONS OF THE 1997 UNIFORM BUILDING CODE SECTION 3303 OR THE LATEST EDITION MUST BE

MET NO CONSTRUCTIOON EQUIPMENT, CONSTRUCTION MATERIAL, PORTABLE TOILETS, DUMPSTERS. ETC. SHALL BE LEFT ON PUBLIC PROPERTY OVERNIGHT WITHOUT PROPER PERMITS. THESE OBSTRUCTIONS MUST HAVE PROPER BARRICADES WITH FLASHING YELLOW LIGHTS OPERATING AFTER DARK.

7. NO OVERNIGHT CLOSURES WILL BE ALLOWED WITHOUT THE APPROVAL OF THE DIRECTOR OF PUBLIC WORKS

8. ANY PUBLIC SIDEWALK DAMAGE TO THE POINT OF CAUSING A TRIP HAZARD DURING CONSTRUCTION, THAT PANEL OF CONCRETE SHALL BE REMOVED IMMEDIATELY AND PATCHED WITH <u>A TEMPORARY ASPHALT PATCH</u> WHICH MUST BE KEPT IN GOOD REPAIR UNTIL THE PERMANENT SIDEWALK IS CONSTRUCTED 9. ALL VEHICLES THAT INTRUDE INTO A NORMAL TRAFFIC LANE MUST HAVE PROPER SIGNAGE

AND BARRICADES AS REQUIRED BY THE (WATCH) MANUAL 10. ALL WORK VEHICLES ARE SUBJECT TO ALL APPLICABLE PARKING RESTRICTIONS.

11. MATERIAL DROPOFF IS NOT ALLOWED ON THE PUBLIC RIGHT OF WAY WITHOUT FIRST OBTAINING A PERMIT FORM THE PUBLIC WORKS DEPARTMENT. 12. FLAGMEN ARE REQUIRED FOR ANY VEHICLES THAT BLOCK THE TRAVEL LANE AND REQUIRE TRAFFIC TO USE THE OPPOSING LANES TO PASS. 13. PEDESTRIAN PROTECTION SHALL COMPLY WITH UBC. SECTION 3303 DURING CONSTRUCTION. 14. ALL ACTIVITIES PERFORMED IN PUBLIC RIGHT OF WAY DURING THE COURSE OF CONSTRUCTION

REQUIRE PUBLIC WORKS PERMIT

INSPECTION REQUIREMENTS

CALL FOR INSPECTION 24 HOURS IN ADVANCE (310) 318-0214. 2. INSPECTIONS WILL ONLY BE DONE MONDAY THROUGH THURSDAY 8:30 AM TO 12:30 PM AND 1:30 PM TO 4:30 PM OFFICE COUNTER HELP WILL BE AVAILABLE FROM 7:00 AM TO 8:30 AM AND 4:30 PM TO 6.00 PM

ALL FORMS AND COMPACTION SHALL BE INSPECTED PRIOR TO ANY CONCRETE BEING POURED OR ASPHALT BEING PLACED. 4. SEWER LATERAL PERMITS WILL NOT BE FINAL UNLESS A SEWER LATERAL DIAGRAM HAS BEEN

COMPLETED AND APPROVED.

GENERAL NOTES

1. BUILDING COMPLIES WITH 2013 CBC, 2013 CMC, 2013 CPC, 2013 CEC, AND CITY OF HERMOSA BFACH AQMD NOTIFICATION IS REQUIRED 10 DAYS BEFORE BEGINNING ANY DEMOLITION WORK

REQUIRED FORM IS AVAILABLE AT THE COMMUNITY DEVELOPMENT DEPARTMENT. PROVIDE PROOF OF NOTIFICATION (MAIL WITH RETURN RECEIPT) 10 DAYS BEFORE BUILDING PERMIT IS ISSUED, OR COMPLETE ASBESTOS NOTIFICATION WAIVER. 3. ALL BUILDING FEATURES PROJECTING INTO REQUIRED SETBACKS ARE INDICATED ON SITE/PLOT

4. SOILS REPORT SHALL BE PROVIDED TO THE BUILDING DEPARTMENT FOR ALL CUTS, FILLS, AND EARTHWORK AS REQUIRED BY CBC SECTION 1804.

5. STUMPS AND ROOTS SHALL BE REMOVED TO A DEPTH OF 12" IN THE AREA OCCUPIED BY THE **BUII DING** INSTALLATION OF INTERIOR AND EXTERIOR WALL AND CEILING COVERINGS SHALL CONFORM TO CHAPTER 25 UBC. 7. ALL WATER CLOSETS TO FLUSH WITH 1.6 GALLON MAX. AND ALL NEW PLUMBING FIXTURES

SHALL BE CERTIFIED LOW FLOW FIXTURES. 8. ALL HOSE BIBS MUST BE PROTECTED BY BACK FLOW PREVENTION AND HAVE AN ANTI-SIPHON DEVICE.

9. PROVIDE APPROVED BACKWATER VALVE FOR ALL PLUMBING FIXTURES LOCATED BELOW THE ELEVATION OF THE NEXT UPSTREAM MANHOLE COVER. FIXTURES ABOVE SUCH ELEVATION SHALL NOT DISCHARGE THROUGH THE BACKWATER VALVE, PROVIDE CAST IRON WASTE PIPE RISERS. 10. ALL WINDOW COVERINGS REQUIRED BY CFIR. FORM SHALL BE POSTED PRIOR TO FINAL

INSPECTION. 11. WRITTEN APPROVAL FROM THE SOUTH COAST AIR QUALITY MANAGEMENT DISTRICT (SCAQMD). (714)396:2000 PER RULE 1403 FOR THE PROPER DISPOSAL OF ASBESTOS. 12. ONLY LOS ANGELES COUNTY HEALTH DEPARTMENT APPROVED DEVICES MAY BE UTILIZED FOR LANDSCAPE IRRIGATION BACK FLOW PREVENTION DEVICES. 13. ALL SITE DRAINAGE SHALL BE TERMINATED AT PUBLIC WAY VIA NON-EROSIVE DEVICE PER

HBMC 14. PROVIDE DRIP PAN OR SIMILAR DEVICE FOR LAUNDRY ROOM, WATER HEATER, AND

DISHWASHER 15. PROVIDE SURVEY STAKES PRIOR TO FOUNDATION INSPECTION TO VERIFY LOT LINES. 16. THE ARCHITECT IS NOT RESPONSIBLE FOR SITE GRADING OR DRAINAGE. 17. IAPMO APPROVAL REQUIRED FOR ONE PIECE LAVATORY. 18. POST INSULATION COMPLIANCE CARD IN CONSPICUOUS LOCATION IN DWELLING PRIOR TO

FINAL INSPECTION. 19. IT IS THE GENERAL CONTRACTORS RESPONSIBILITY TO VERIFY THAT THE BUILDING IS WITHIN THE HEIGHT LIMIT PRIOR TO FRAMING THE ROOF RAFTERS. CONTACT THE CIVIL SURVEY

CONSULTANTS. 20. CONTROL VALVE FOR SHOWERS AND TUB/SHOWERS SHALL BE OF THE PRESSURE BALANCE OR THERMOSTATIC MIXING VALVE TYPE. UPC. SECT. 410.7. 21. VERIFY CLEARANCES WITH OVERHEAD UTILITY LINES FROM ALL PERMANENT AND TEMPORARY STRUCTURE INCLUDING SCAFFOLDING AND OTHER WORKING AREAS DURING CONSTRUCTION.

CLEARANCE TO BE 8 FT. HORIZONTAL AND 12 FT. VERTICAL. VERIFY WITH SOUTHERN CALIFORNIA EDISON CO. BEFORE COMMENCING CONSTRUCTION. 22. PROVIDE PROTECTION TO PEDESTRIANS PER UBC SECTION 3303 DURING CONSTRUCTION.

23. BUILDING ADDRESS SHALL BE PROVIDED ON THE BUILDING IN SUCH A POSITION AS TO BE PLAINLY VISIBLE AND LEGIBLE FROM THE STREET PER CBC SEC. 501. 24. THE STRUCTURE SHALL COMPLY WITH THE SECURITY REQUIREMENTS OF "APPENDIX CHAPTER 10 SECURITY" OF HBMC.

25. COOKING EQUIPMENT MUST BE LISTED FOR RESIDENTIAL USE 26. ALL DOORS PROVIDING DIRECT ACCESS TO THE POOL SHALL BE EQUIPPED WITH A SELF CLOSING, SELF LATCHING DEVICE WITH A RELEASE MECHANISM PLACED NO LOWER THAN 54" AFF. ALL THESE DOORS SHALL BE EQUIPPED WITH EXIT ALARMS. CBC SECTION 3109.4.1.8. 27. UNDERGROUND ELECTRICAL SERVICE REQUIRED FOR ALL REPAIRS, REMODELS OR EXPANSION EXCEPT WHERE THE BUILDING VALUATION OF SUCH REPAIRS OR REMODELS IN A FIVE-YEAR PERIOD DOES NOT EXCEED FIFTY PERCENT OF THE EXISTING VALUATION PRIOR TO CONSTRUCTION. 28. ALL WATER FIXTURES SHALL BE WATER CONSERVING CPC 402.0 29. DRAINAGE FIXTURE LOCATED BELOW THE NEXT UPSTREAM MANHOLE OR BELOW THE MAIN SEWER LEVEL REQUIRES INVESTIGATION TO ASCERTAIN THE NECESSITY FOR SEWER BACKWATER DEVICE CPC 710.0

EXCAVATION NOTES

1. PROVIDE CONTINUOUS INSPECTION DURING EXCAVATION OF SHORING AND INSTALLATION OF SHORING MEMBERS 2. AN EXCAVATION/CONSTRUCTION PERMIT SHALL BE OBTAINED PRIOR TO CONSTRUCTION OF ANY

IMPROVEMENTS WITHIN PUBLIC RIGHT-OF-WAY. THIS INCLUDES, BUT IS NOT LIMITED TO, STANDARD SIDEWALKS, CURBS, GUTTERS, DRIVEWAY APPROACHES, OR UNDERGROUNDING OF UTILITIES. 3. CONTRACTOR TO PROVIDE EVIDENCE OF PERMIT FROM CALIFORNIA STATE DEPARTMENT OF INDUSTRIAL SAFETY FOR EXCAVATION 5'-0" OR DEEPER. CALL 213.736.3041. 4. IT IS THE CONTRACTOR'S RESPONSIBILITY TO CONTACT "DIG ALERT" PRIOR TO ANY EXCAVATION IN THE PUBLIC RIGHT-OF-WAY. (800) 227-2600

5. PROVIDE TEMPORARY SHORING OF ADJACENT PROPERTY. QUALIFIED PERSONS REGISTERED WITH THE STATE SHALL DESIGN SHORING. 6. A PERMIT IS REQUIRED FROM THE STATE DIVISION OF INDUSTRIAL SAFETY FOR TRENCHES OR

EXCAVATION 5' (1.52 METERS) OR DEEPER OR BUILDING/STRUCTURE OVER 3 STORIES HIGH, OR BUILDING OVER 36' (11 METERS) HIGH.

A NEW 3 STORY DUPLEX WITH JADU **SMITH RESIDENCE** 24 3RD ST. **HERMOSA BEACH, CA 90254**

A.H.

A.W.

B.O.W

C.H.

CLG.

CLR.

COL.

CONC

C.W.

DN.

ELEV.

F.A.

FLR.

FX

HORZ.

LAND.

LT.WT

MAX.

MIN.

REQ.

SECT

S.F.E

SHT

OP

ABBREVIATION ACTUAL HEIGHT AWNING WINDOW BOTTOM OF WALL CRITICAL HEIGHT CEILING CLEAR COLUMN CONCRETE CASEMENT WINDOW DIMENSION DOWN ELEVATION FROM ABOVE FLOOR FIXED HORIZONTAL HEIGHT LANDING LIGHT WEIGHT CONCRETE MAXIMUM MINIMUM OPERABLE PROPERTY LINE REQUIRED SECTION SUB FLOOR ELEVATION SHFFT SKEWED SLOPED TOP OF WALL T.O.W.

SYMBOL LEGEND

Room Name

Room Elevation

1 Ref

1 Ref

A.01

[A]-

(1)

NORTH

ROOM TAG

ELEVATION TAG SHEET NUMBER ELEVATION DESIGNATION

WINDOW LETTER DESIGNATION DOOR NUMBER DESIGNATION SKYLIGHT LETTER DESIGNATION

NORTH ARROW DESIGNATION

REVISION DESIGNATION

EXTENT OF REVISION

SECTION NUMBER SHEET NUMBER

TOP/BOTTOM RISER NUMBER OF RISERS UP/DOWN

PROJECT SUMMARY

PROJECT LOCATION: LEGAL DESCRIPTION: **ASSESSOR PARCEL NO:** ZONING: SCOPE OF WORK:

HERMOSA BEACH LOT 9 BLOCK 3
APN: 4188-007-009
_R3
_NEW 3 STORY DUPLEX WITH A JADU

24 3RD ST.

SIM

1_

A.01 -

ΠP

20R @ 7 1/2" -

GENERAL BUILDING INFORMATION (NOTE: FOR ADDITION	AND REMODEL PROJECTS PLEAS	E PROVIDE INFORMATION FOR EXIST	
	UNIT A	UNIT B	JADU
GARAGE (INTERIOR DIMENSIONS)	17' 5 1/4" X 40' 0"		
1ST LEVEL LIVING AREA	711 SF		313 SF
DECKS/ BALCONIES			
2ND LEVEL LIVING AREA	961 SF	580 SF	
DECKS/ BALCONIES	132 SF	172 SF	
3RD FLOOR LIVING AREA	264 SF	412 SF	
DECKS/ BALCONIES	437 SF	175 SF	
TOTAL LIVING AREA	1,936 SF	992 SF	313 SF
TOTAL DECKS/ BALCONIES	569 SF	589 SF	
NO. OF BEDROOMS	2	2	1
NO. OF BATHROOMS	4	3	1
ZONING INFORMATION		REQUIRED	PROVIDED
AREA			
LOT AREA			2,843 SF
LOT COVERAGE		65%	65%
YARDS			
FRONT		5'	5'
SIDE		3'	3'
REAR		3'	3'
PARKING AND DRIVEWAYS			
NUMBER OF SPACES		4	4
GUEST SPACES		1	1
PARKING SETBACK		3'	3'
PARKING STALL DIMENSION		B'6" X 20'-0"	8'-8 1/2" X 20' 0"
TURNING AREA		23'	23'
DRIVEWAY WIDTH		17'	18'
DRIVEWAY MAXIMUM SLOPE		12.5%	12.4%
OPEN SPACE			
ON GRADE		0	0
DECKS/ BALCONIES		600 SF	653 SF
TOTAL		600 SF	653 SF
BASEMENT QUALIFICATION CALCULATION (REQUIRED FOR ALL PROJECTS PROPOSING TWO STORIES AND BASEMENT	N/A		

ENCROACHMENT NOTES

1. ALL PLANT MATERIALS IN THE PLANNED LANDSCAPE SHALL NOT BE HAZARDOUS TO HEALTH AND SAFETY, SUCH AS PLANTS THAT CONTAIN THORNS, SPINES, TOXIC FRUITS OR LEAVES, AND THOSE THAT DROP EXCESSIVE SLIPPERY FRUITS AND FLOWERS, AND SURFACE ROOTING.

2. ALL LANDSCAPE AREAS SHALL BE ON A FULLY AUTOMATED IRRIGATION SYSTEM SUPPLIED BY HOME OWNER. 3. ALL WORKMANSHIP AND MATERIALS SHALL CONFORM WITH LOCAL BUILDING, PLUMBING AND ALL OTHER APPLICABLE CODES HAVING JURISDICTION. 4. HEIGHTS OF WALLS, FENCES AND ALL OTHER ELEMENTS SHALL COMPLY WITH CITY ENCROACHMENT REGULATIONS.

5. UTILITIES AND VISUAL OBSTRUCTIONS MAX. 42" HIGH SHALL GENERALLY BE AVOIDED SO AS TO MAINTAIN ACCESS TO UNDERGROUND UTILITIES AND TO PROTECT VISTAS FROM NEIGHBORING PROPERTIES. 6. PLANT MATERIALS SHALL NOT EXCEED 42" IN HEIGHT. TREES AND SHRUBS MAY BE PERMITTED WITH A SEPARATE LANDSCAPE PLAN.

PROJECT DATA

BARRY AND JILL SMITH 24 3RD ST. HERMOSA BEACH, CA 90254

LEGAL DESCRIPTION

LOT 9 BLOCK 3 HERMOSA BEACH M.B. 1-25-26 APN 4188-007-009 OCCUPANCY AND ZONING

OCCUPANCY: R3/U ZONING: R3 CONSTRUCTION TYPE: TYPE V-B, SPRINKLER NUMBER OF UNITS: 3 NUMBER OF STORIES: 3

CODES

CITY OF HERMOSA BEACH

AREA CALCULATIONS

UNIT A

LOT SIZE:

LOT COVERAGE:

MAX ALLOWABLE LOT COVERAGE: 1,848 SF (65%) PROPOSED LOT COVERAGE:

LIVING AREA: FIRST FLOOR: SECOND FLOOR: THIRD FLOOR: TOTAL LIVING:

TOTAL LIVING AREA GARAGE BALCONIES/DECKS

HEIGHT CALCULATIONS

MAXIMUM ALLOWABLE HEIGHT = 30' - 0" ACTUAL HEIGHT = SEE SHEET A.05.1 FOR HEIGHT INFO

OPEN SPACE CALCS.


OPEN SPACE CALCULATION:

OPEN SPACE REQUIRED	U =
FIRST FLOOR	=
SECOND FLOOR	=
THIRD FLOOR	=
ROOF DECK	=
TOTAL OPEN SPACE	=


CONSULTANTS

SURVEYOR DENN ENGINEERS (310) 542-9433 3914 DEL AMO BLVD. STE. 921 TORRANCE, CA 90503

CIVIL ENGINEER PERU & ASSOCIATES (310) 270-0811 1976 W 234TH ST. TORRANCE, CA 90501

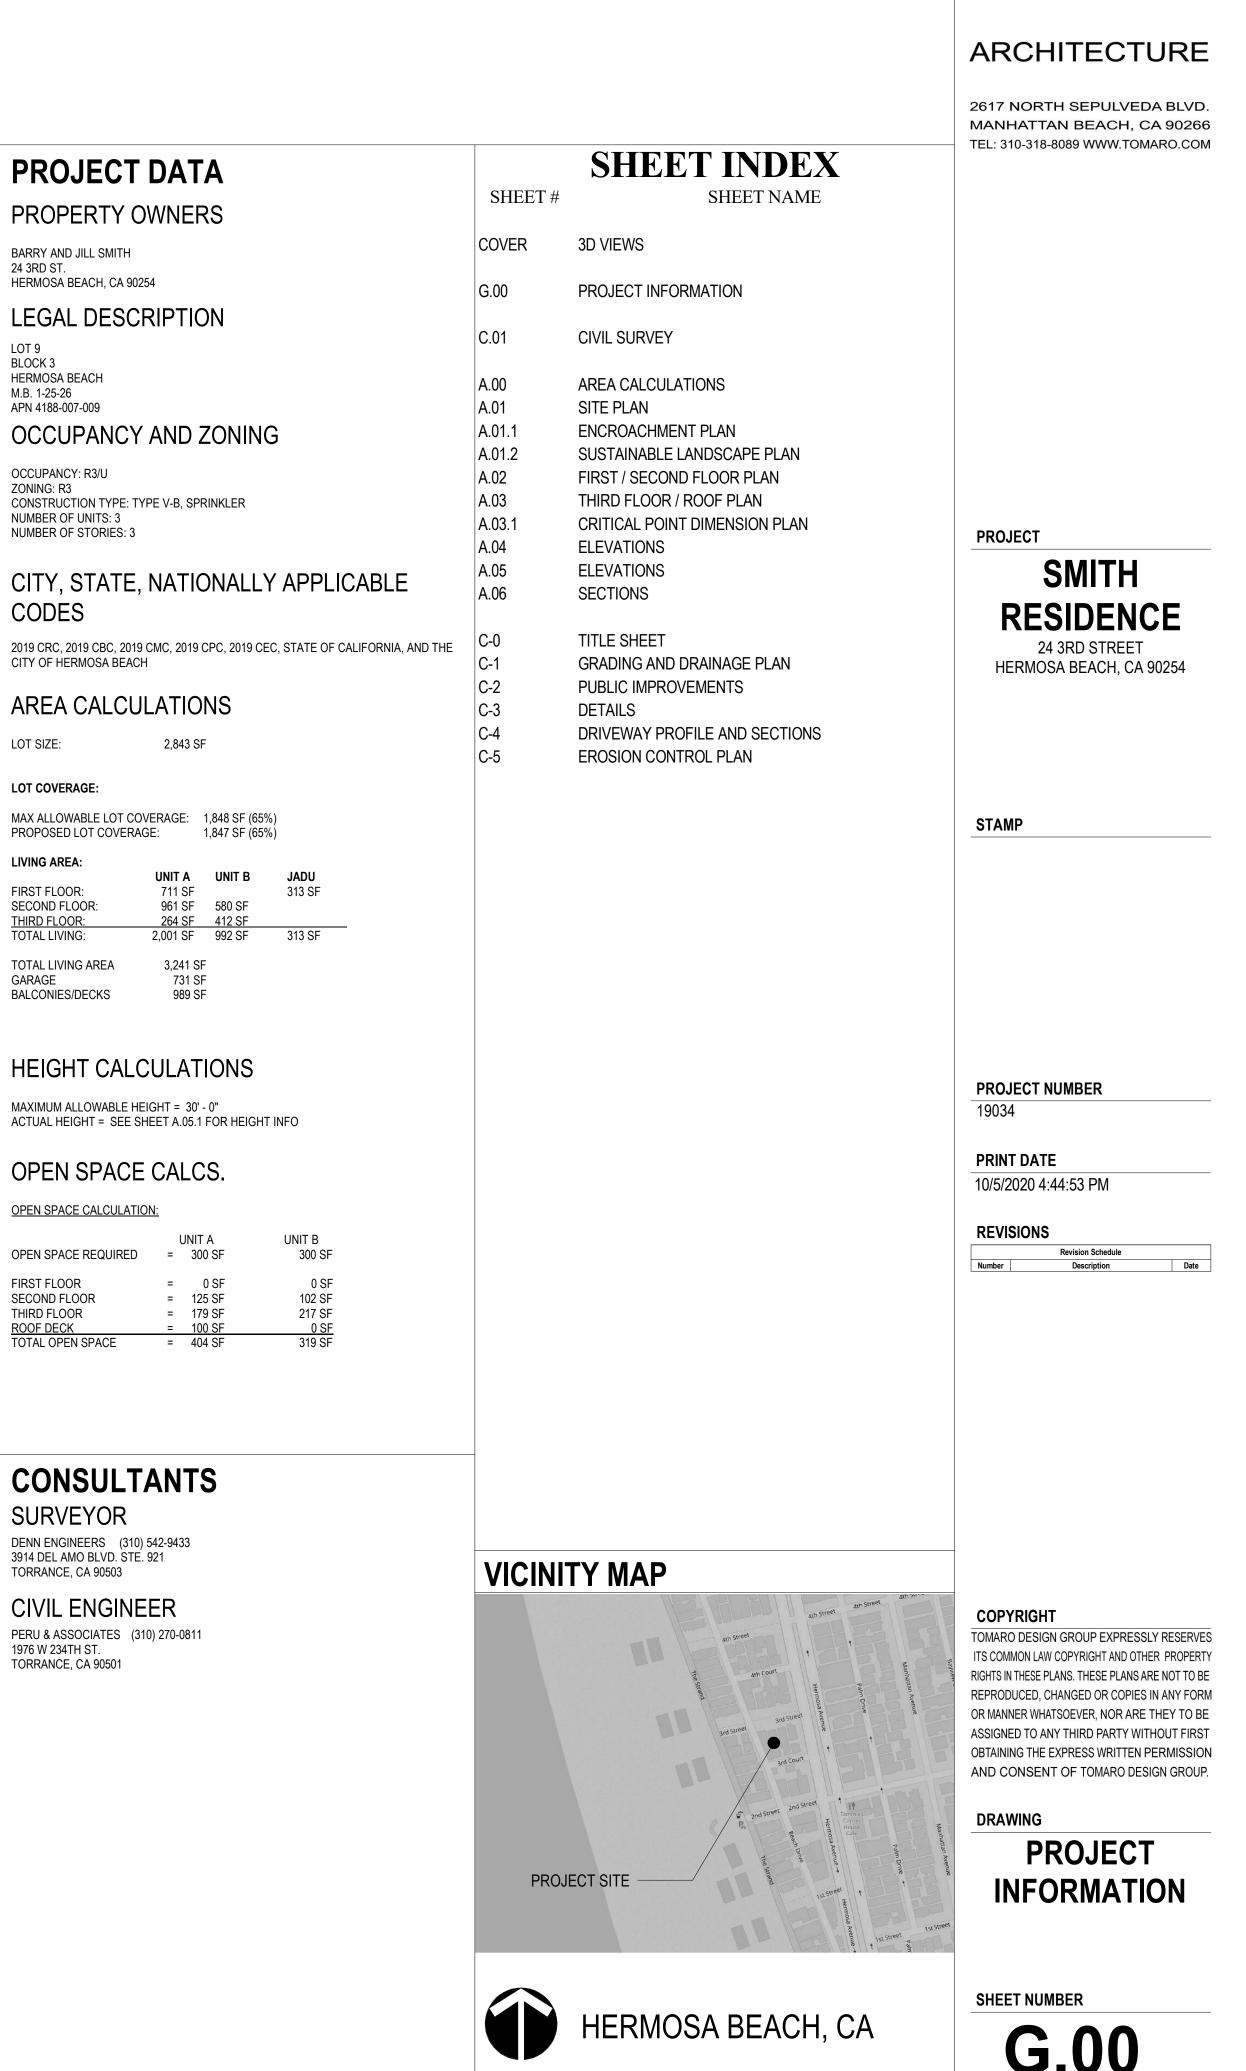

3RD STREET

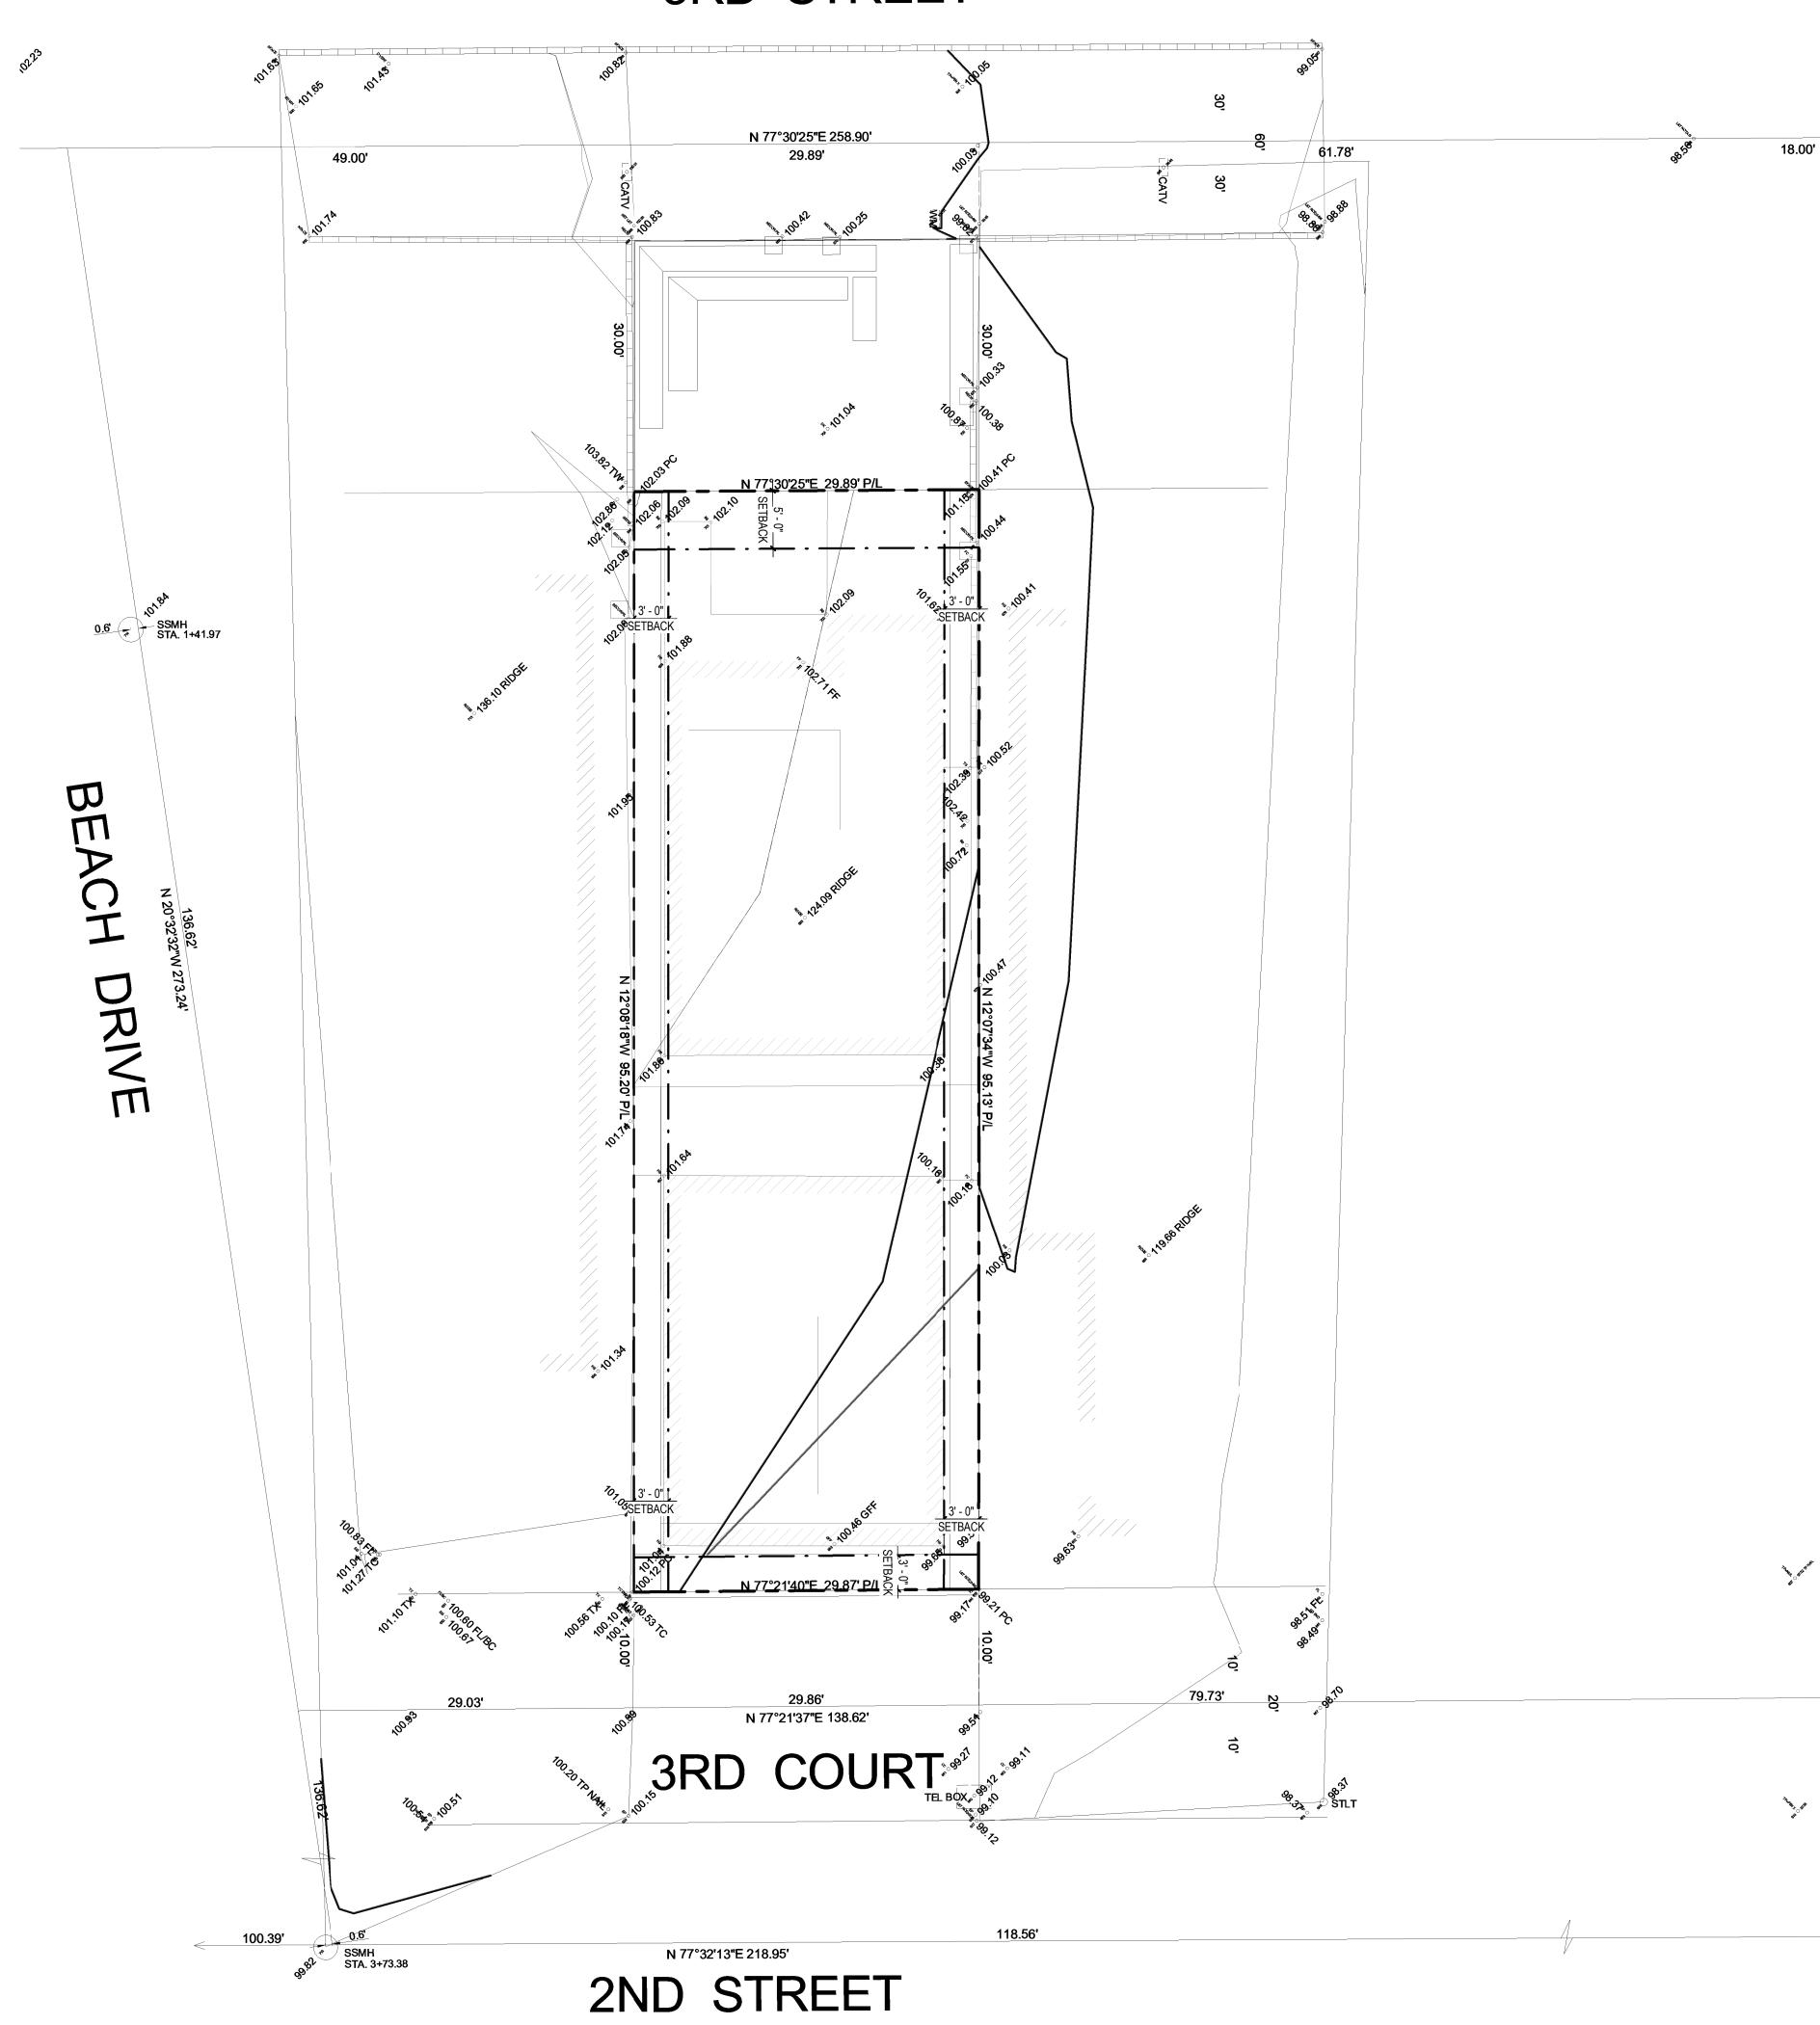

HERMOS \triangleright \triangleright ENUE

Z



THAT ST





SURVEY AND TOPOGRAPHY

FOR BARRY SMITH 24 3RD STREET HERMOSA BEACH, CA 90254 PHONE 310-994-8956

JOB ADDRESS 24 3RD STREET HERMOSA BEACH, CA 90254

LEGAL DESCRIPTION LOT 9, BLOCK 3 HERMOSA BEACH M.B. 1-25-26 APN 4188-007-009

THIS MAP CORRECTLY REPRESENTS A SURVEY MADE BY ME OR UNDER MY DIRECTION IN CONFORMANCE WITH THE REQUIREMENTS OF PROFESSIONAL LAND SURVEYORS' ACT



ARCHITECTURE

2617 NORTH SEPULVEDA BLVD. MANHATTAN BEACH, CA 90266 TEL: 310-318-8089 WWW.TOMARO.COM

PROJECT



STAMP

GARY J. ROEHL

DRAWN BY KW

CHECK BY TS

R.C.E. 30826

DRAWN ON REVISIONS

REVISIONS

NOVEMBER 5, 2019

LEGEND

BUILDING

CONCRETE

Z EXISTING

° 106.76 EXISTING ELEVATION

100 CEXISTING CONTOUR

CENTERLINE CHAIN-LINK

ELECTRIC METER FOUND FENCE

FINISH FLOOR

FIRE HYDRANT

GARAGE FINISH FLOOR

PROPERTY CORNER / PROP. CORNER

PROPERTY LINE / PROP. LINE

SANITARY SEWER CLEAN OUT

SANITARY SEWER MANHOLE

STAKE / STAKE & TAG

TOP OF WALL / T.O.W.

NOTE: ALL SETBACK DIMENSIONS SHOWN ARE MEASURED TO EXTERIOR SURFACE OF

TOP OF DRIVEWAY APRON

BOUNDARY MONUMENTS ARE NOT NECESSARILY

SET ON PROPERTY CORNERS. PLEASE REFER TO

THE NOTATION ON THE PLANS FOR OFFSET

DISTANCES. IF THERE ARE ANY QUESTIONS, PLEASE DO NOT HESITATE TO CONTACT DENN

STREET LIGHT

TOP OF CURB

WATER METER

WESTERLY

FLOW LINE

GAS METER GUY WIRE

MANHOLE

NORTHERLY

POWER POLE

SOUTHERLY

SPIKE AND WASHER

PARAPET

SPIKE

LEAD AND TAG

EASTERLY

BEGINNING OF CURB RETURN

BLOCK WALL

BCR

C/L C.L.F. E'LY

EM FD

FE

FF

FH

FL

GFF GM

GW

L&T

MH N'LY

PC

PP PPT

PL, P/L

S&W

S'LY

SPK

SSCO

SSMH

STK

STLT

тс

TW

ΤХ WLY

WM

BRICK

WOOD

DECK

PROJECT NUMBER 19034

PRINT DATE 10/5/2020 4:40:52 PM

Number

REVISIONS Revision Schedule

Description

BUILDINGS UNLESS OTHERWISE NOTED. ENGINEERS FOR CLARIFICATION AT : (310) 542-9433, M-F 8:00 AM TO 5:00 PM. COPYRIGHT

SCALE 1" = 8'

SSMH STA. 3+70.61

44.6'

ANY CHANGES OR MODIFICATIONS MADE TO THIS PLAN WITHOUT WRITTEN CONSENT OF DENN ENGINEERS SHALL RELIEVE DENN ENGINEERS FROM ANY LIABILITY OR DAMAGE RESULTING FROM SUCH CHANGES OR MODIFICATIONS, INCLUDING ANY ATTORNEYS FEES OR COSTS INCURRED IN ANY PROCEEDING THAT DENNI ENCINEERS MAY BE JOINED PROCEEDING THAT DENN ENGINEERS MAY BE JOINED.

SHEET 1 OF 1 JOB NO. 19-455




SHEET NUMBER


C.0²


ITS COMMON LAW COPYRIGHT AND OTHER PROPERTY RIGHTS IN THESE PLANS. THESE PLANS ARE NOT TO BE REPRODUCED, CHANGED OR COPIES IN ANY FORM OR MANNER WHATSOEVER, NOR ARE THEY TO BE ASSIGNED TO ANY THIRD PARTY WITHOUT FIRST OBTAINING THE EXPRESS WRITTEN PERMISSION AND CONSENT OF TOMARO DESIGN GROUP

COPYRIGHT TOMARO DESIGN GROUP EXPRESSLY RESERVES

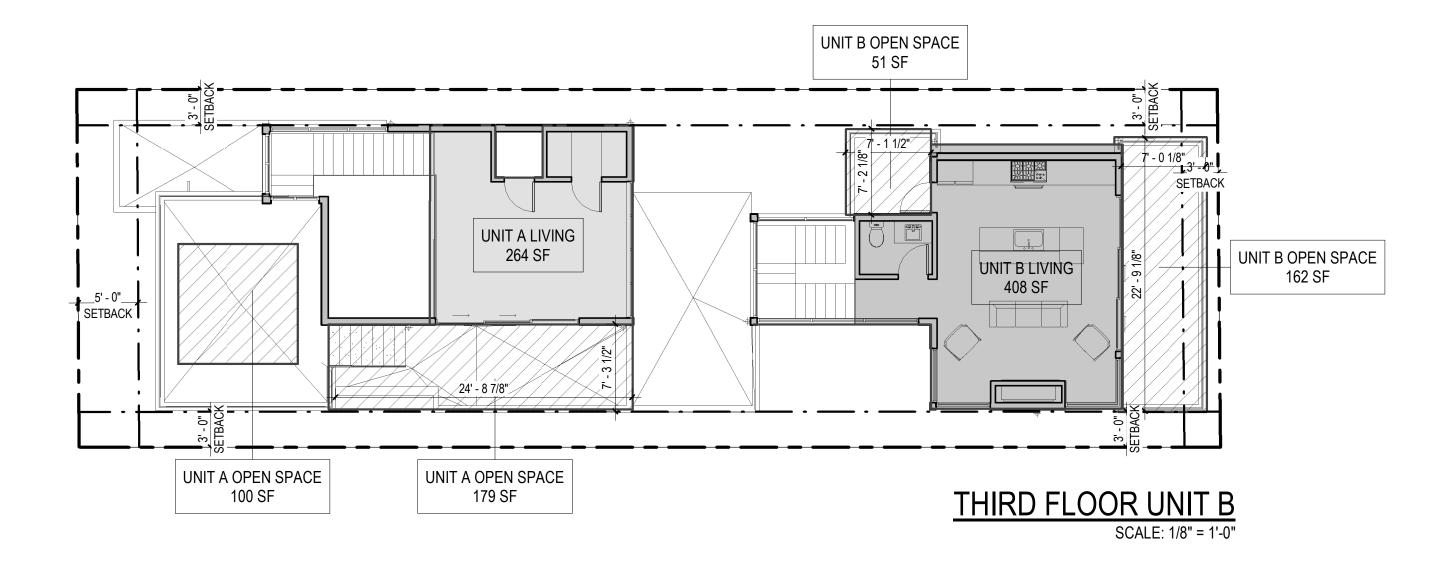




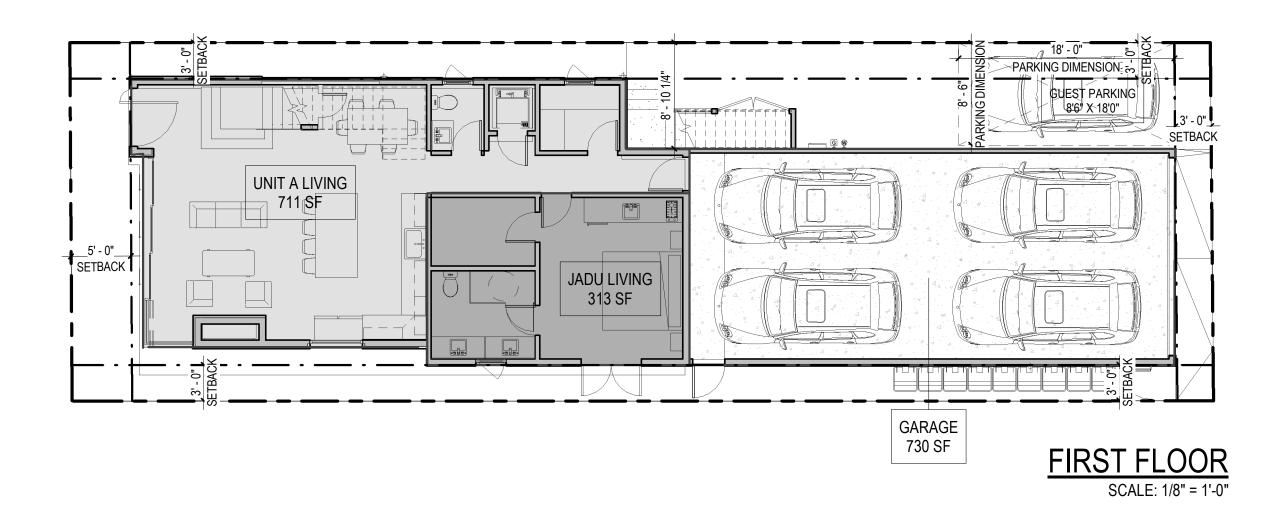

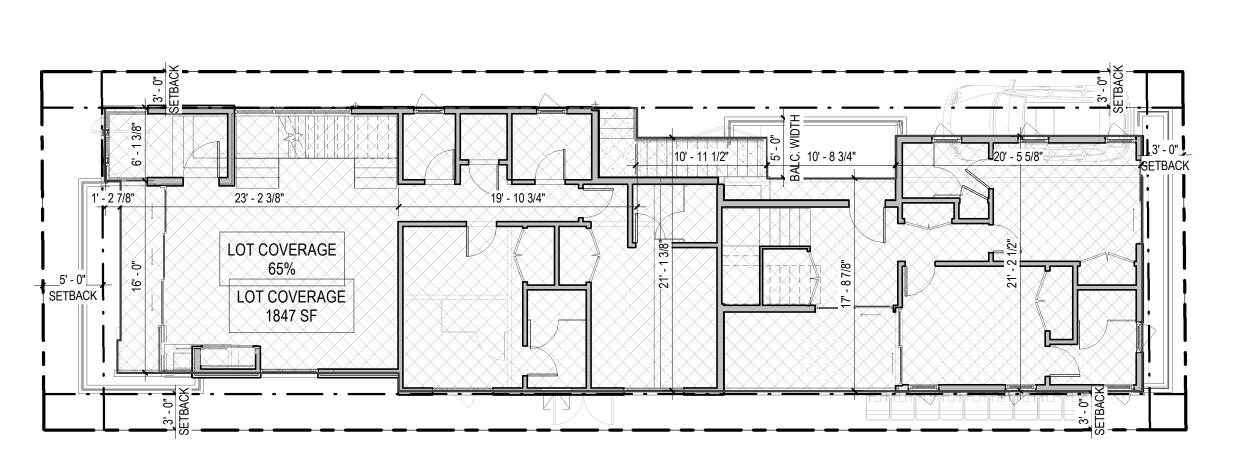



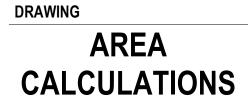

TOMARO DESIGN GROUP EXPRESSLY RESERVES

ITS COMMON LAW COPYRIGHT AND OTHER PROPERTY

RIGHTS IN THESE PLANS. THESE PLANS ARE NOT TO BE REPRODUCED, CHANGED OR COPIES IN ANY FORM OR MANNER WHATSOEVER, NOR ARE THEY TO BE

ASSIGNED TO ANY THIRD PARTY WITHOUT FIRST

OBTAINING THE EXPRESS WRITTEN PERMISSION

AND CONSENT OF TOMARO DESIGN GROUP

LOT COVERAGE SCALE: 1/8" = 1'-0"

COPYRIGHT

Revision Schedule Number Date Description

10/5/2020 4:40:23 PM

REVISIONS

PRINT DATE

PROJECT NUMBER

19034

FIRST FLOO SECOND FLO THIRD FLOO <u>ROOF DECK</u> TOTAL OPEN	DOR R	= = = =	0 SF 125 SF 179 SF 100 SF 404 SF		0 SF 102 SF 217 SF <u>0 SF</u> 319 SF
	=	2,843 SF			

LOT SIZE	=	2,843 SF
MAX ALLOWABLE LOT COVERAGE PROPOSED LOT COVERAGE		1,848 SF (65%) 1,847 SF (65%)

LEGEND

- UNIT A LIVING
- UNIT B LIVING
- UNIT A OPEN SPACE
- UNIT B OPEN SPACE

STAMP

24 3RD STREET HERMOSA BEACH, CA 90254



SMITH





ARCHITECTURE

2617 NORTH SEPULVEDA BLVD.

MANHATTAN BEACH, CA 90266

TEL: 310-318-8089 WWW.TOMARO.COM

TOTAL LIVING AREA GARAGE = 3,241 SF = 731 SF = 989 SF OPEN SPACE CALCULATION: UNIT B 300 SF UNIT A

= 300 SF

UNIT A

= 711 SF

= 961 SF = 264 SF = 1,936 SF

UNIT B 0 SF 580 SF 412 SF 992 SF

JADU 313 SF

0 SF <u>0 SF</u> 313 SF

AREA CALCULATIONS:


FIRST FLOOR

SECOND FLOOR

THIRD FLOOR TOTAL LIVING

BALCONIES

OPEN SPACE REQUIRED

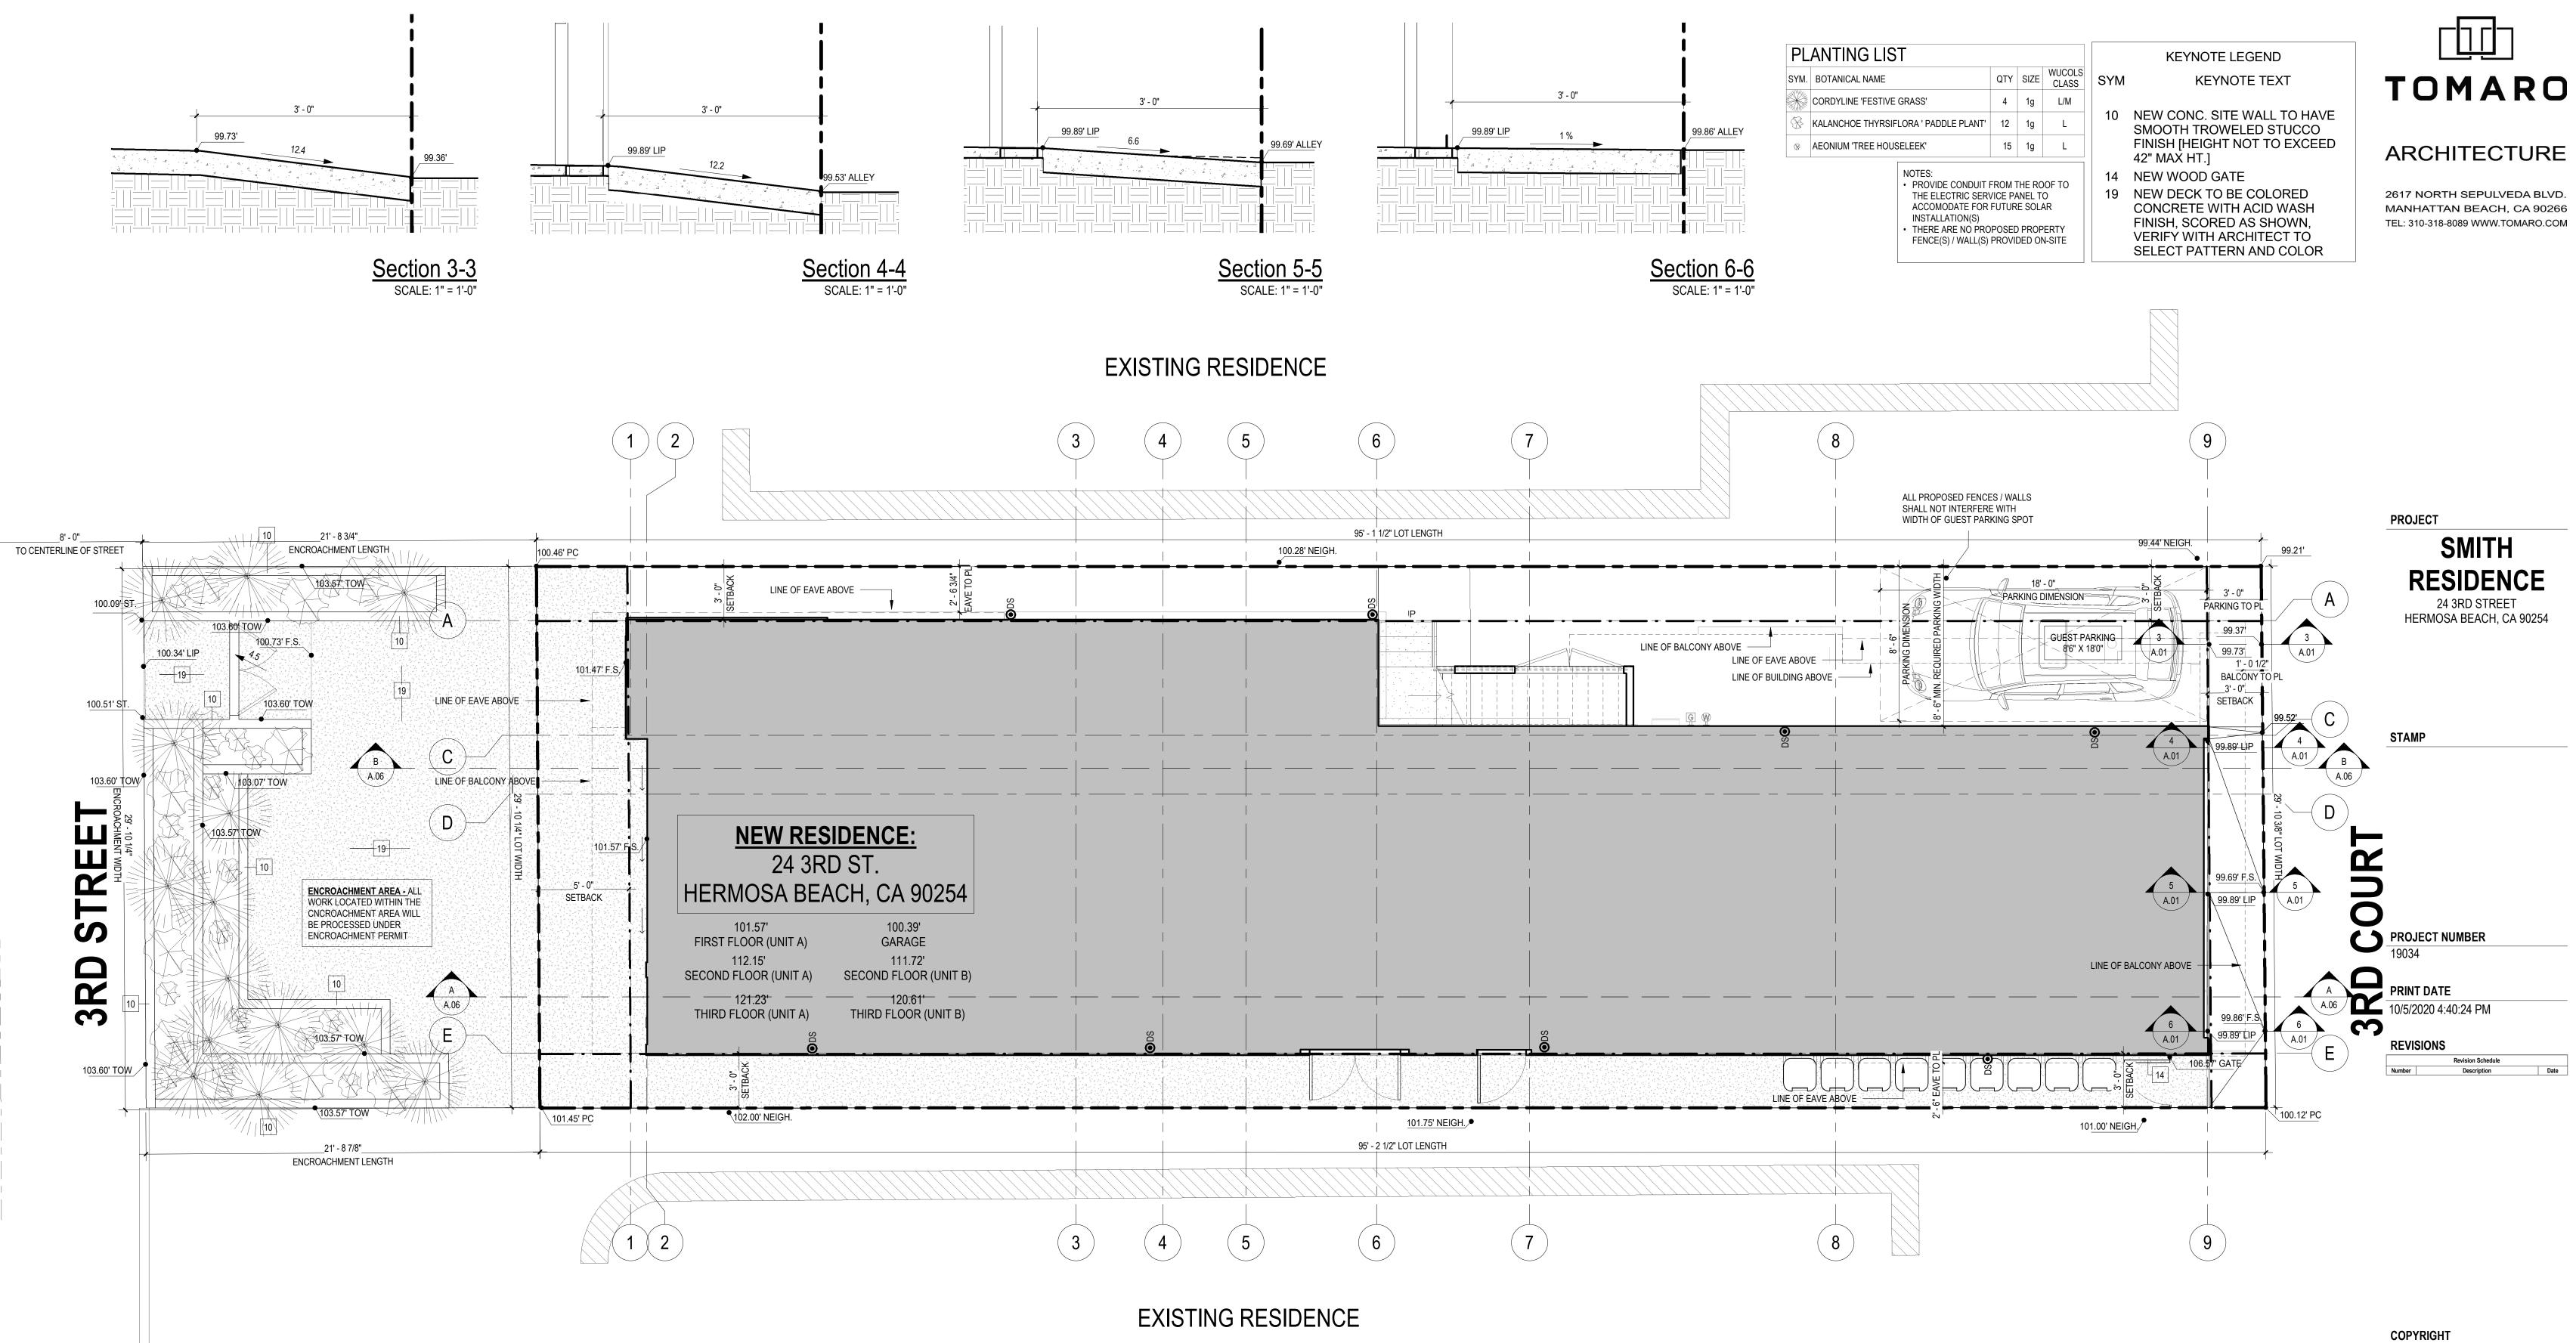




DRAWING





TOMARO DESIGN GROUP EXPRESSLY RESERVES ITS COMMON LAW COPYRIGHT AND OTHER PROPERTY RIGHTS IN THESE PLANS. THESE PLANS ARE NOT TO BE REPRODUCED, CHANGED OR COPIES IN ANY FORM OR MANNER WHATSOEVER, NOR ARE THEY TO BE ASSIGNED TO ANY THIRD PARTY WITHOUT FIRST OBTAINING THE EXPRESS WRITTEN PERMISSION AND CONSENT OF TOMARO DESIGN GROUP

SITE PLAN

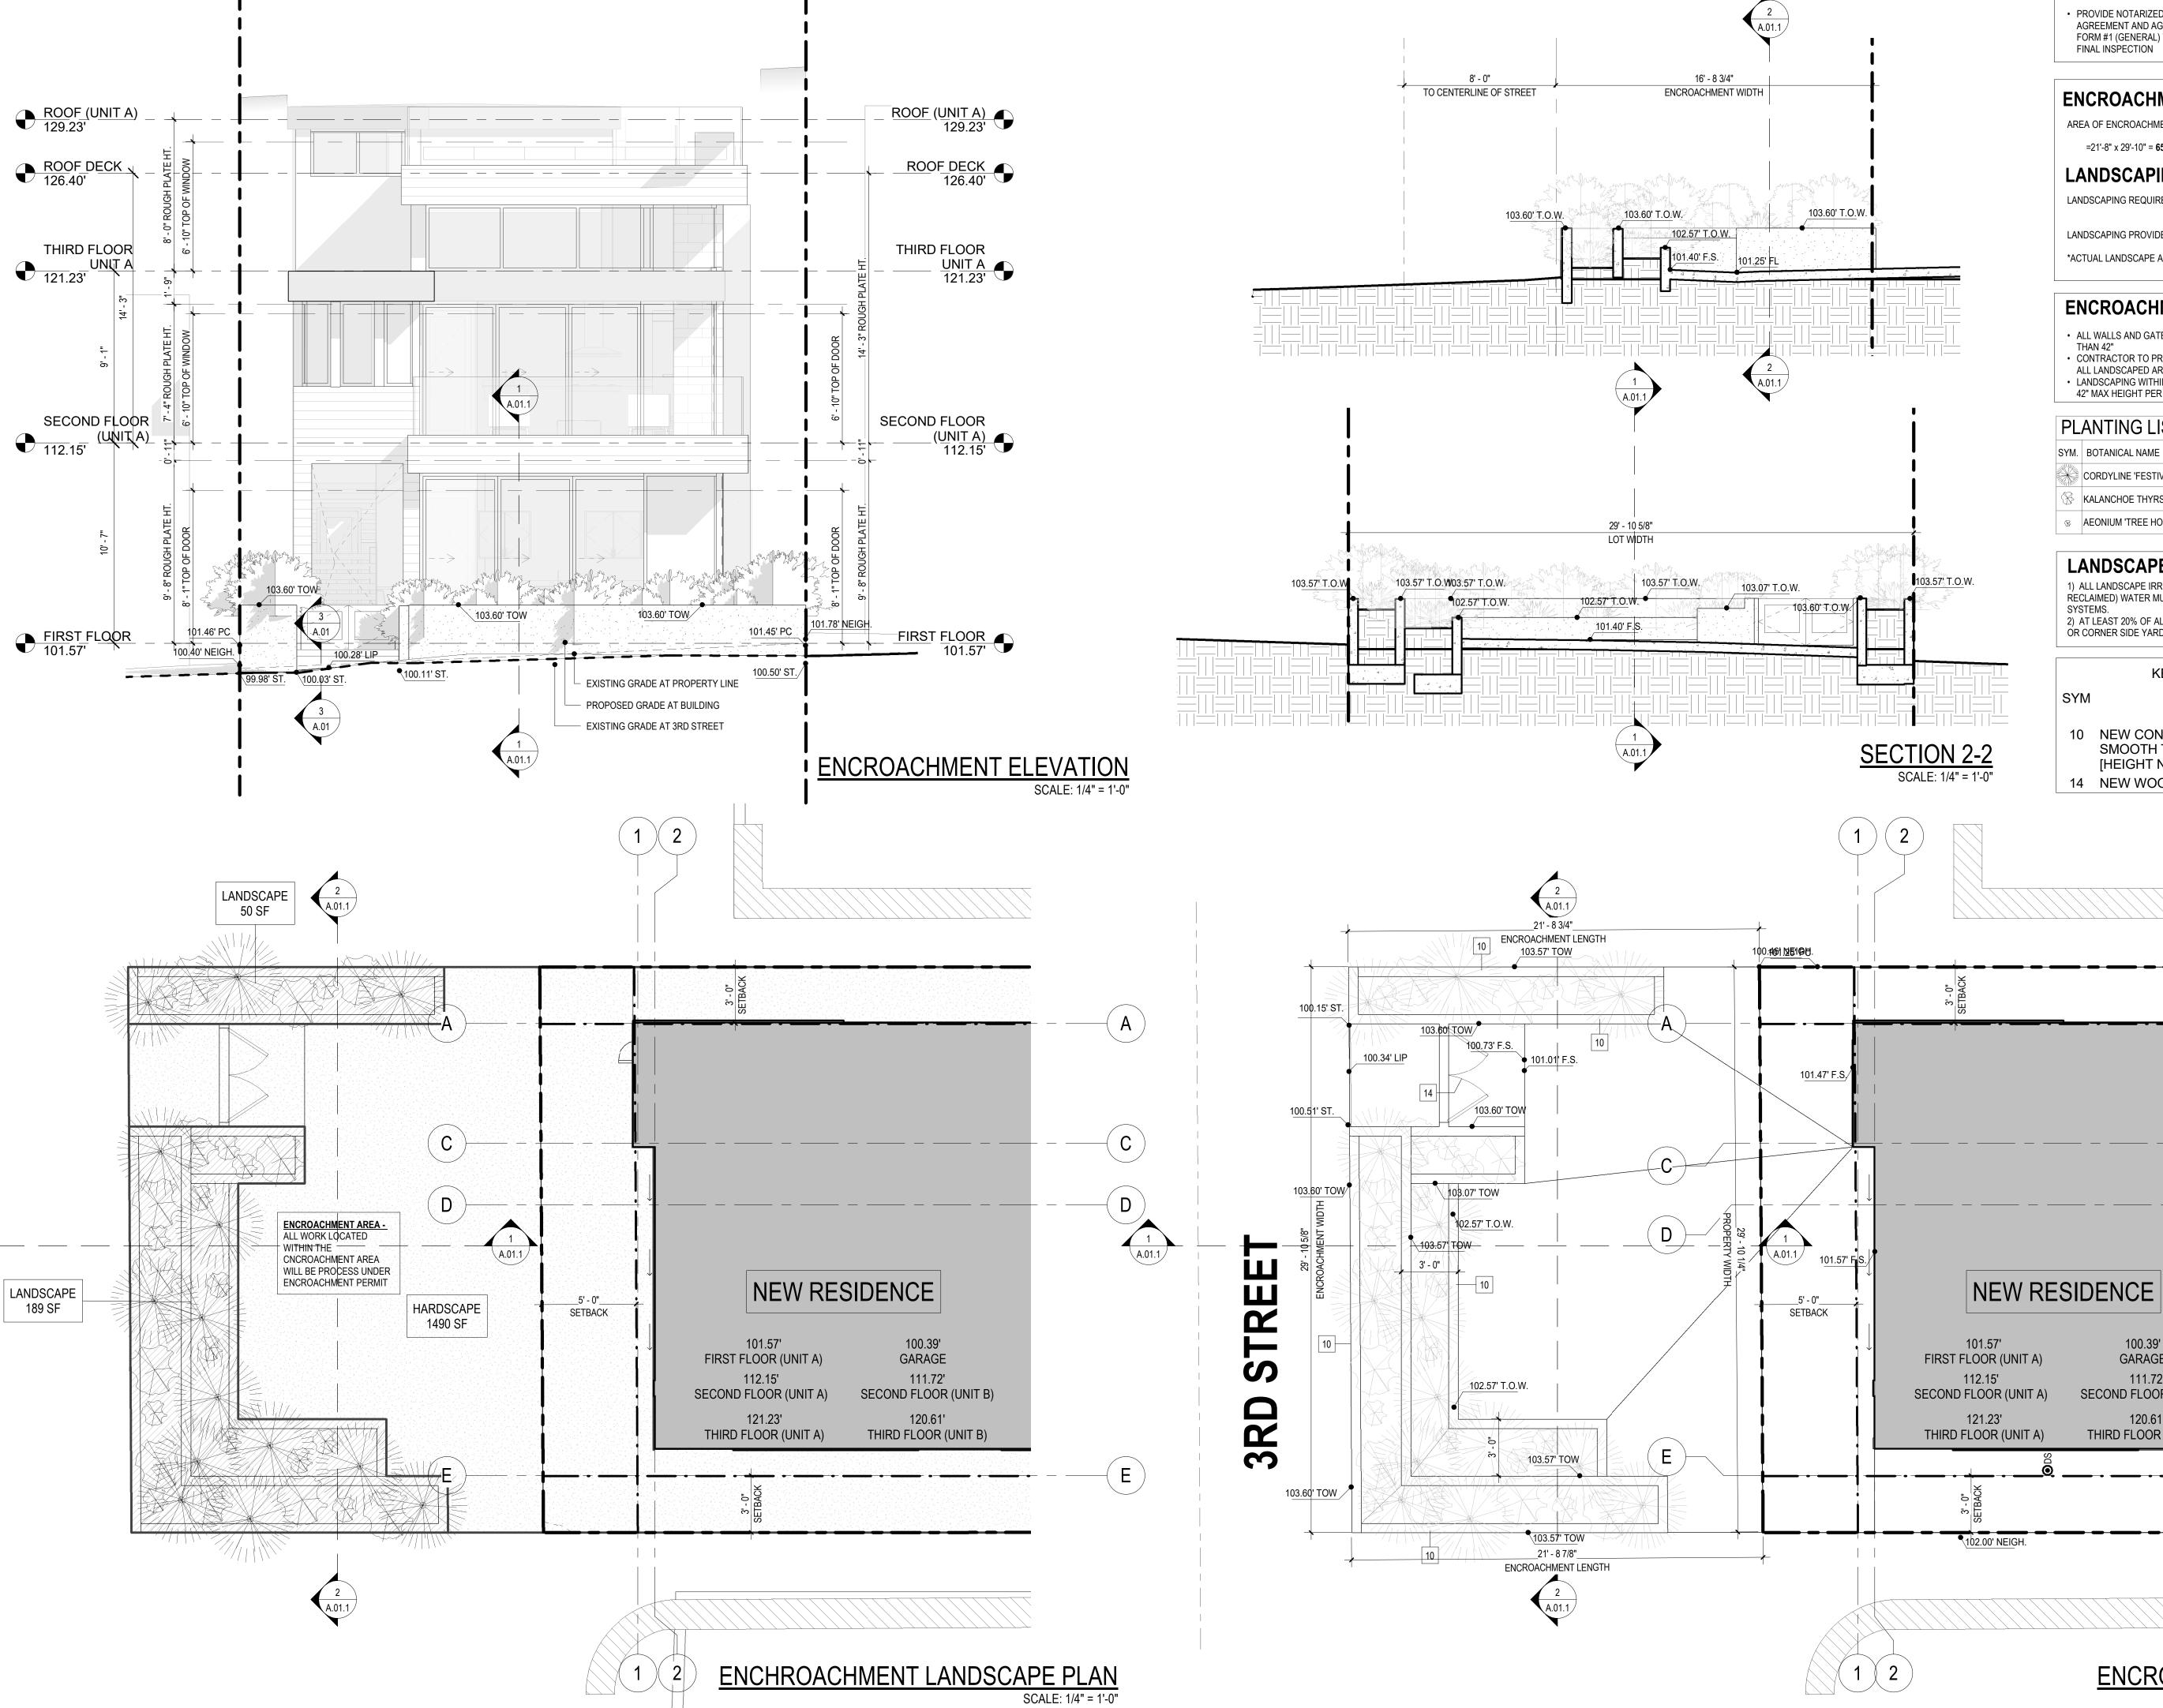



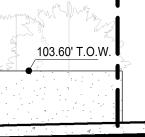

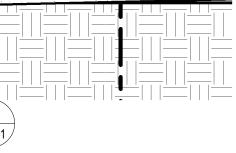

NOTARIZED OWNER'S AGREEMENT

 PROVIDE NOTARIZED OWNER'S ENCROACHMENT PERMIT AGREEMENT AND AGENCY SIGNED INSURANCE ENDORSEMENT FORM #1 (GENERAL) TO COMMUNITY DEVELOPMENT PRIOR TO FINAL INSPECTION

ENCROACHMENT CALCULATIONS

AREA OF ENCROACHMENT IN PUBLIC RIGHT OF WAY

=21'-8" x 29'-10" = **651 SF**

LANDSCAPING CALCULATIONS

LANDSCAPING REQUIRED = 1/3 OF ENC. AREA =1/3 X 651 = **217 SF**

LANDSCAPING PROVIDED = 189 + 50 = 239 SF

*ACTUAL LANDSCAPE AREA > REQUIRED LANDSCAPE AREA

ENCROACHMENT NOTES:

- ALL WALLS AND GATES IN ECROACHMENT AREA TO BE LESS
- THAN 42" CONTRACTOR TO PROVIDE FOR AUTOMATIC IRRIGATION FOR
- ALL LANDSCAPED AREAS PER MUNICIPAL CODE

 LANDSCAPING WITHIN ENCROACHMENT AREA NOT TO EXCEED 42" MAX HEIGHT PER MUNICIPAL CODE

PLANTING LIST

SYM.	BOTANICAL NAME	QTY	SIZE	WUCOLS CLASS
\mathbf{X}	CORDYLINE 'FESTIVE GRASS'	4	1g	L/M
×	KALANCHOE THYRSIFLORA ' PADDLE PLANT'	12	1g	L
8	AEONIUM 'TREE HOUSELEEK'	15	1g	L

LANDSCAPE NOTES:

1) ALL LANDSCAPE IRRIGATION PROVIDED BY POTABLE (NOT RECLAIMED) WATER MUST USE DRIP OR MICROSPRAY IRRIGATION SYSTEMS. 2) AT LEAST 20% OF ALL VISIBLE PORTIONS OF A REQUIRED FRONT OR CORNER SIDE YARD SHALL BE PLANTING AREA. MBMC 10.12.030

KEYNOTE LEGEND

KEYNOTE TEXT

SYM

10 NEW CONC. SITE WALL TO HAVE SMOOTH TROWELED STUCCO FINISH [HEIGHT NOT TO EXCEED 42" MAX HT.] 14 NEW WOOD GATE



ARCHITECTURE

2617 NORTH SEPULVEDA BLVD. MANHATTAN BEACH, CA 90266 TEL: 310-318-8089 WWW.TOMARO.COM

PROJECT



STAMP

19034

REVISIONS

COPYRIGHT

PROJECT NUMBER

PRINT DATE 10/5/2020 4:40:28 PM


Revision Schedule


Description

D

А

໌ດົ

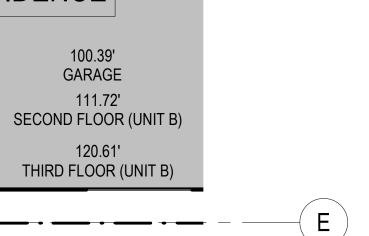

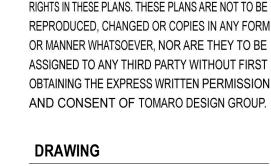

TOMARO DESIGN GROUP EXPRESSLY RESERVE


ITS COMMON LAW COPYRIGHT AND OTHER PROPERT






A.01.1

SHEET NUMBER

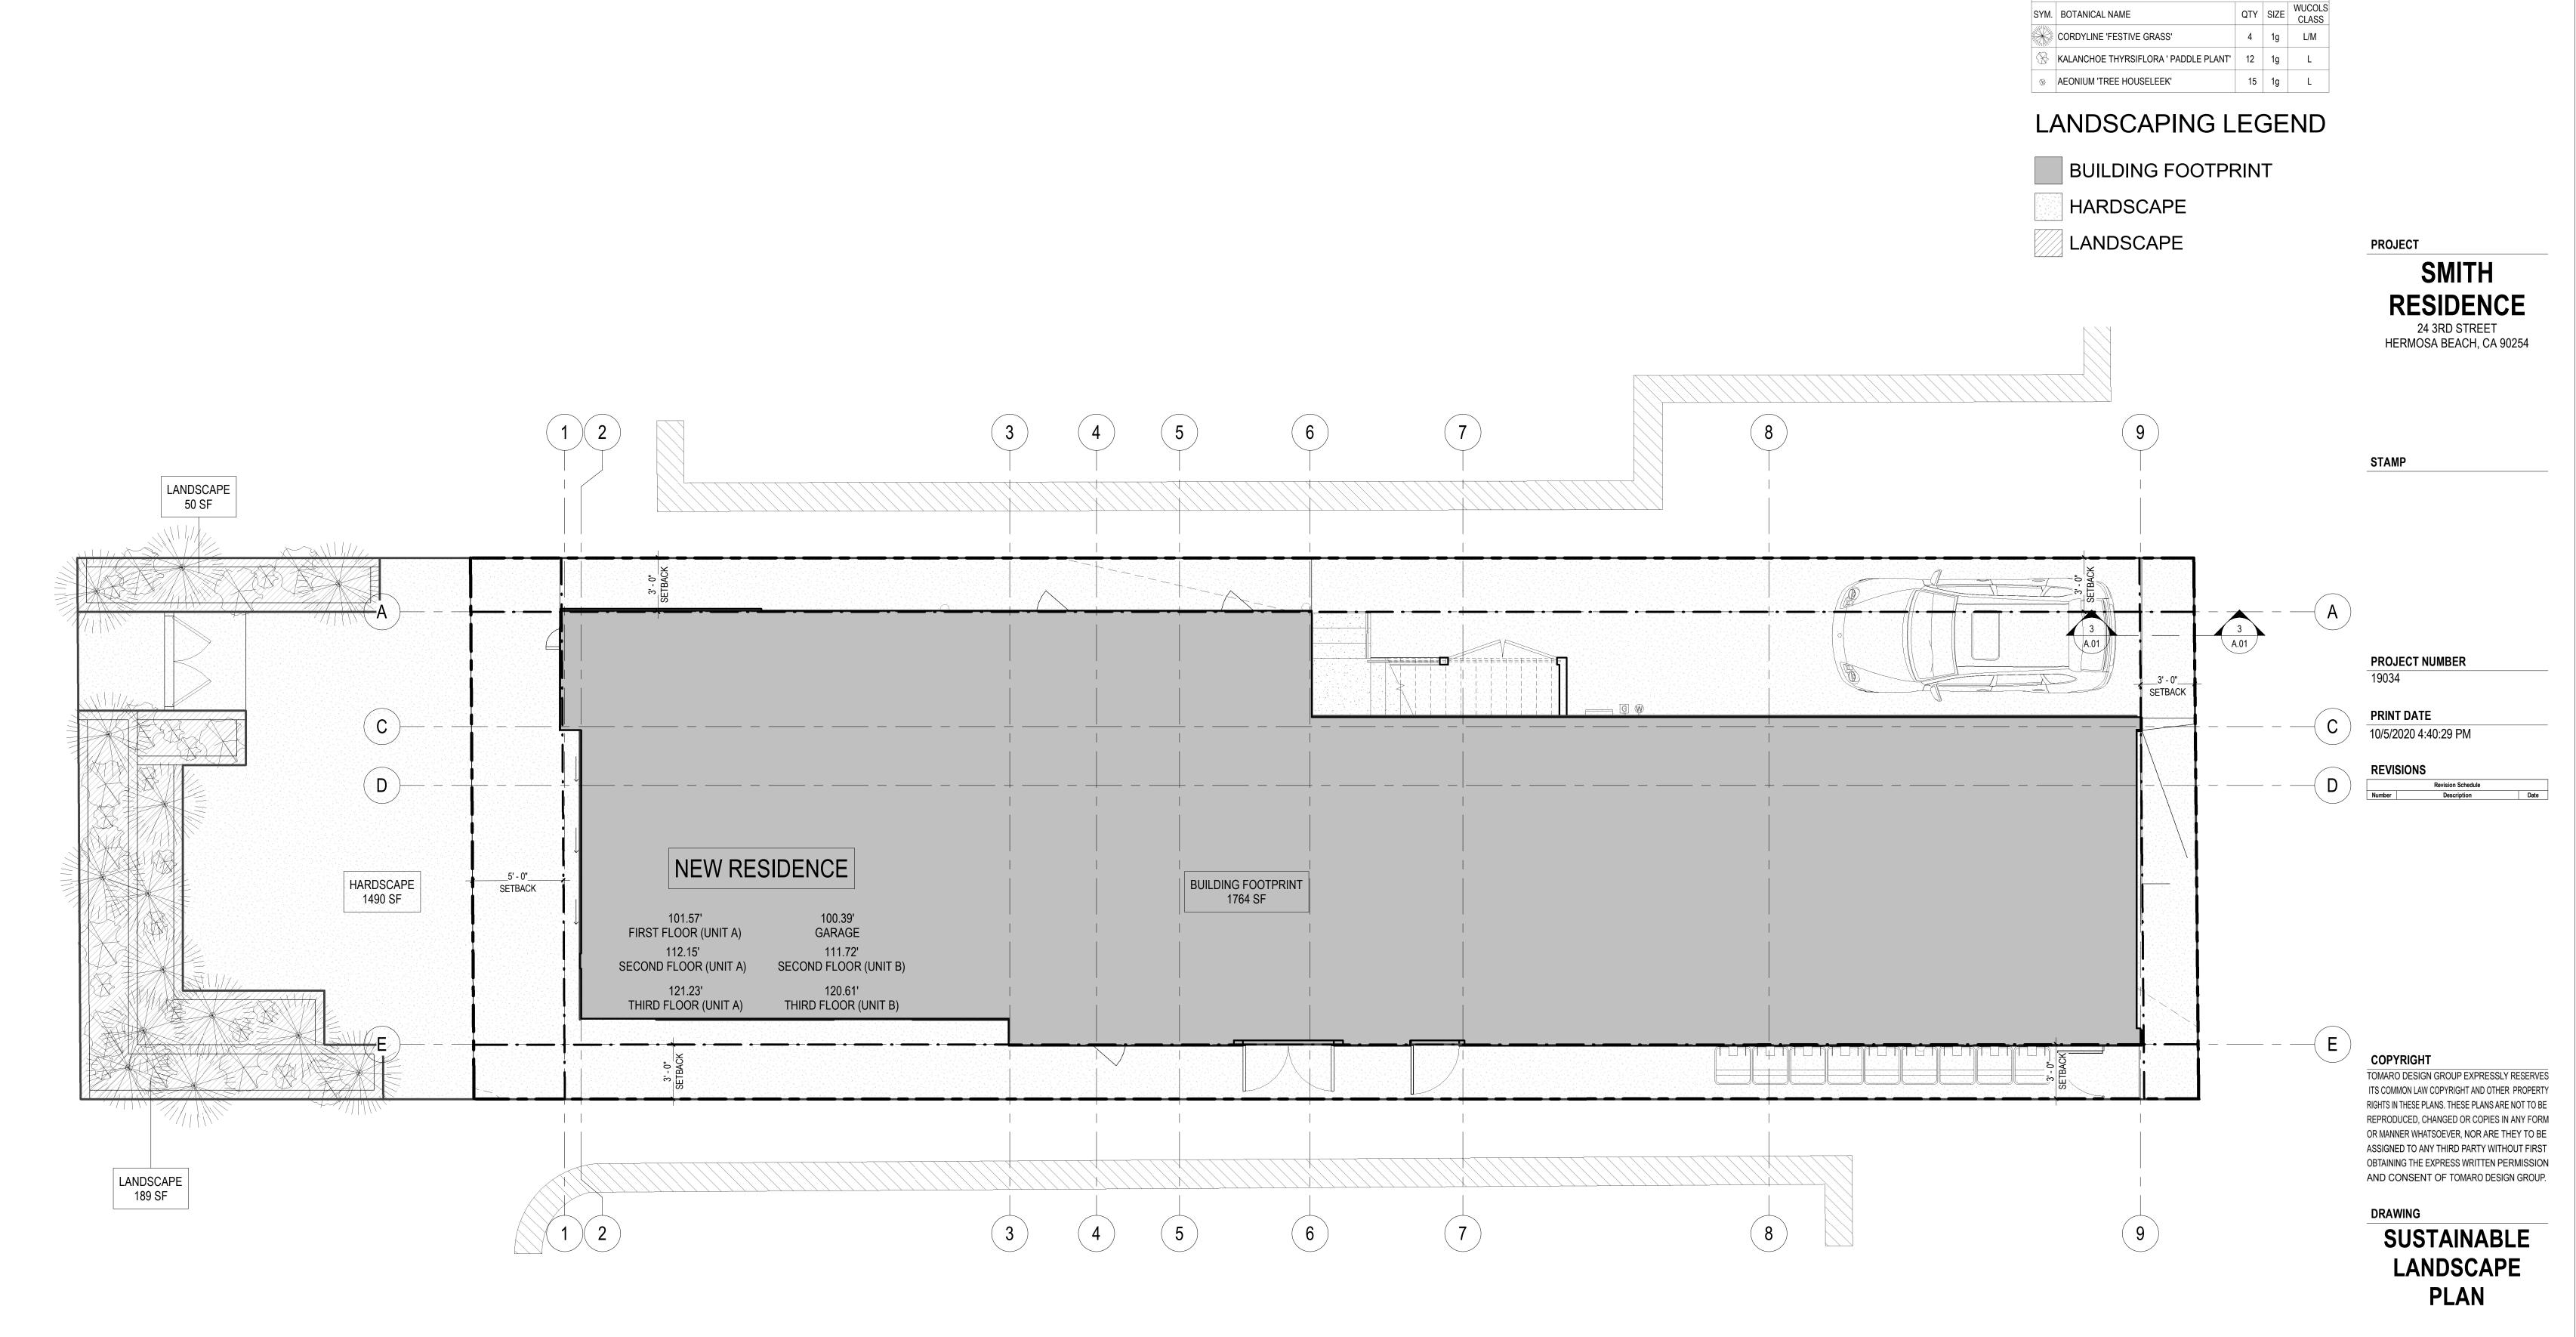

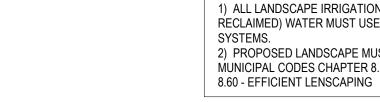

LANDSCAPE NOTES:


1) ALL LANDSCAPE IRRIGATION PROVIDED BY POTABLE (NOT RECLAIMED) WATER MUST USE DRIP OR MICROSPRAY IRRIGATION 2) PROPOSED LANDSCAPE MUST MEET HERMOSA BEACH MUNICIPAL CODES CHAPTER 8.56 - WATER CONSERVATION AND

PERMEABLE AREA CALCULATION

LOT AREA	2843 SF
BUILDING FOOTPRINT	1798 SF
EXTERIOR SURFACE AREA	1696 SF
LANDSCAPE AREA	239 SF
NON-PERMEABLE SURFACE (HARDSCAPE)	1490 SF
PERMEABLE SURFACE (HARDSCAPE)	000 SF
PERMEABLE AREA	239 SF
AT LEAST 50% (848 SF) OF THE EXTERIOR SURFACE AREA M BE PERMEABLE OR AN INFILTRATION SYSTEM MUST BE PROV	

PLANTING LIST

SYM. BOTANICAL NAME

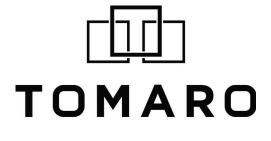



ARCHITECTURE

2617 NORTH SEPULVEDA BLVD. MANHATTAN BEACH, CA 90266 TEL: 310-318-8089 WWW.TOMARO.COM

SHEET NUMBER



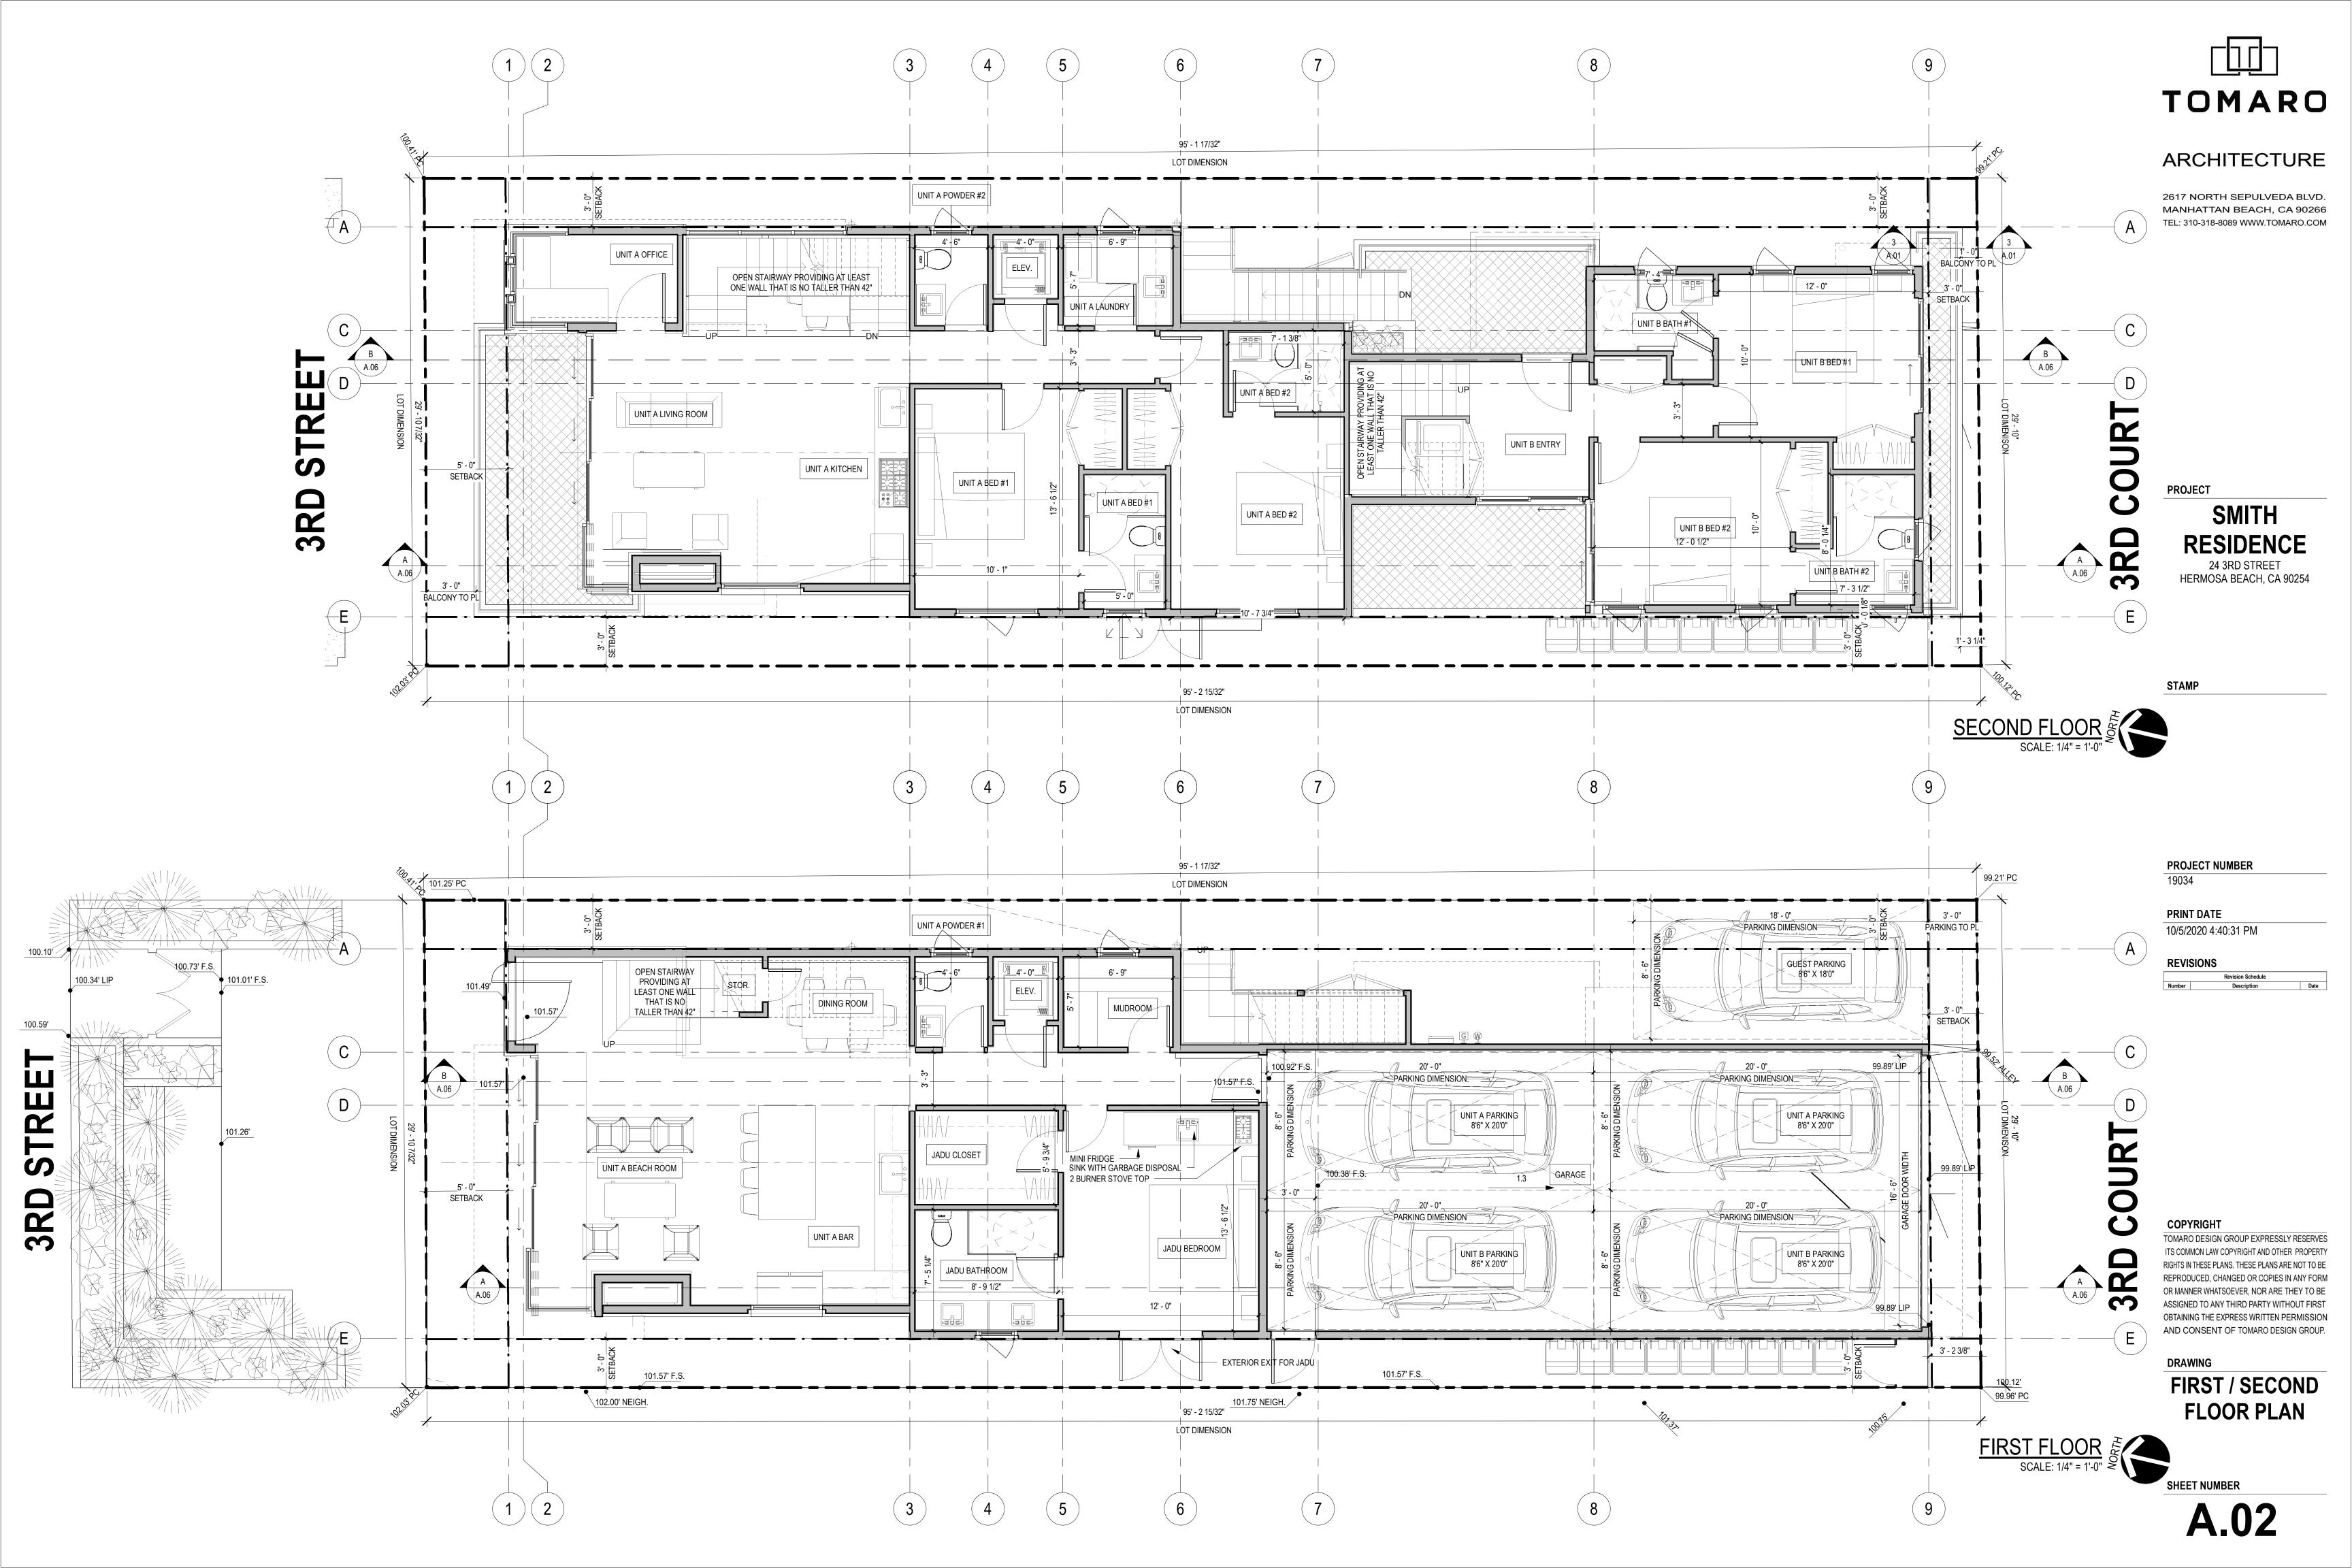

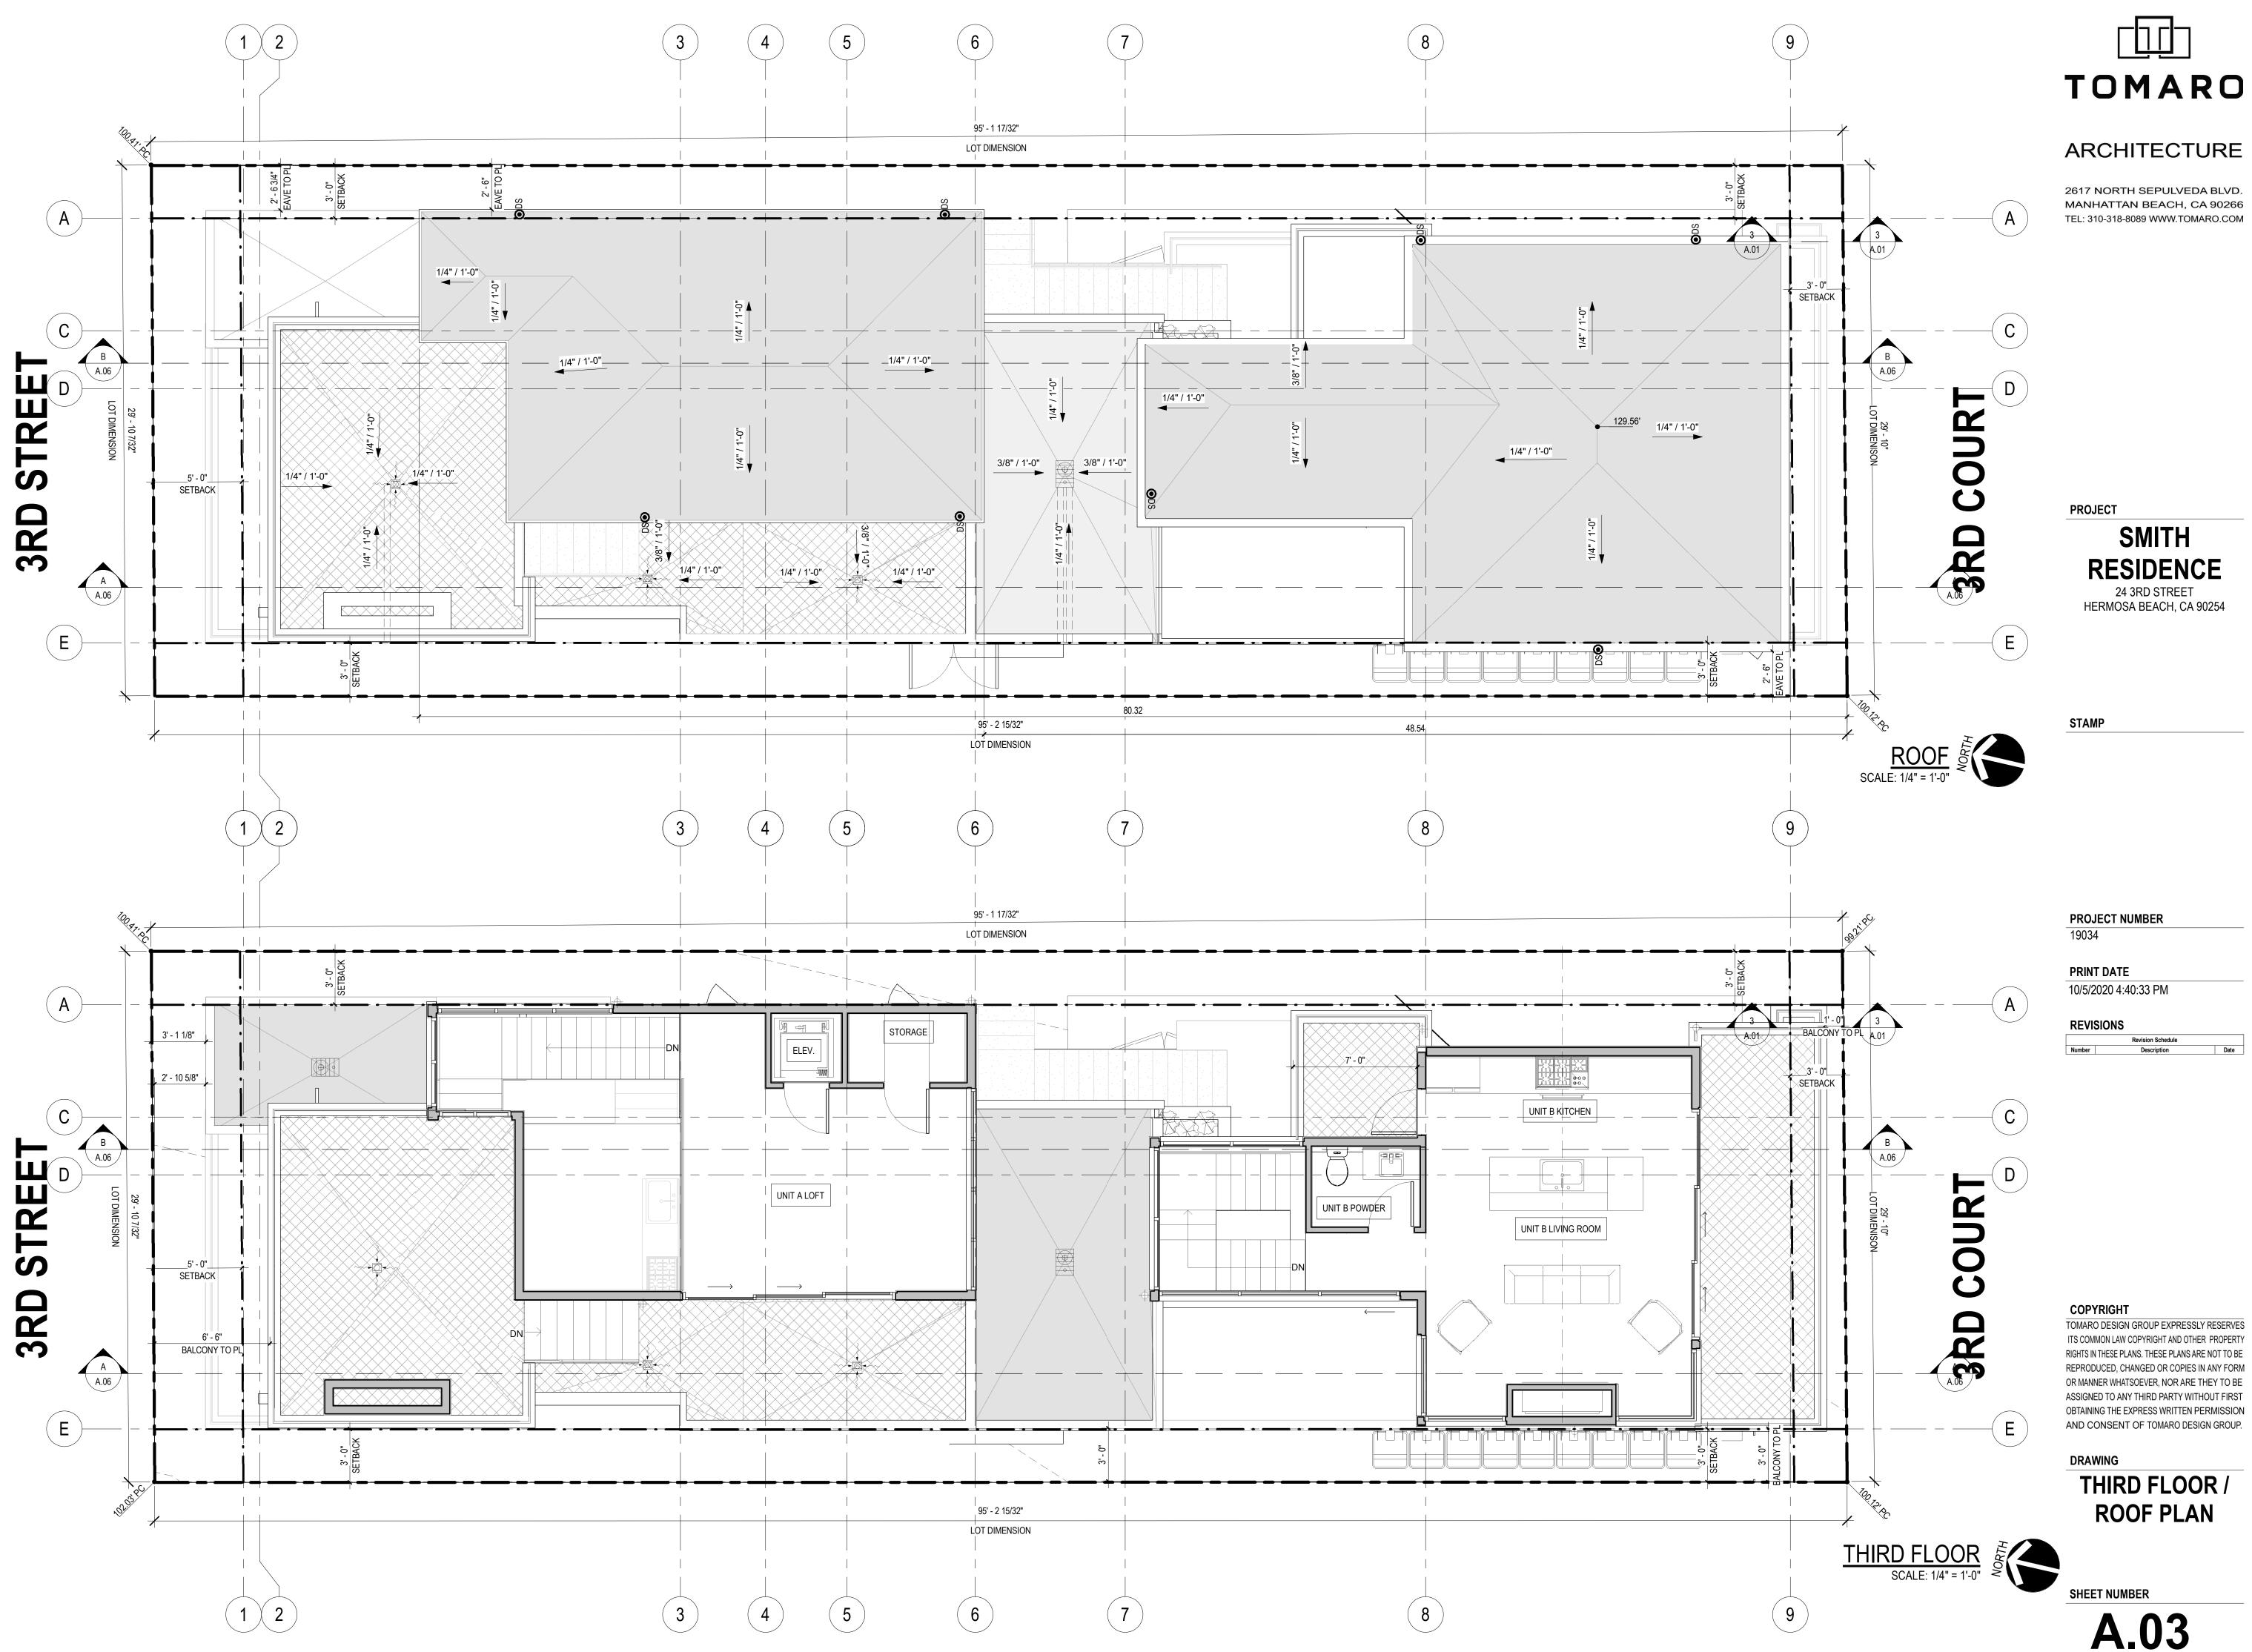

SHEET NUMBER A.03

DRAWING THIRD FLOOR / **ROOF PLAN**

COPYRIGHT TOMARO DESIGN GROUP EXPRESSLY RESERVES ITS COMMON LAW COPYRIGHT AND OTHER PROPERTY RIGHTS IN THESE PLANS. THESE PLANS ARE NOT TO BE REPRODUCED, CHANGED OR COPIES IN ANY FORM OR MANNER WHATSOEVER, NOR ARE THEY TO BE ASSIGNED TO ANY THIRD PARTY WITHOUT FIRST OBTAINING THE EXPRESS WRITTEN PERMISSION AND CONSENT OF TOMARO DESIGN GROUP

REVISIONS Revision Schedule Date Description Number

PRINT DATE 10/5/2020 4:40:33 PM


PROJECT NUMBER 19034

STAMP

PROJECT

SMITH RESIDENCE 24 3RD STREET HERMOSA BEACH, CA 90254

STREET **3RD**

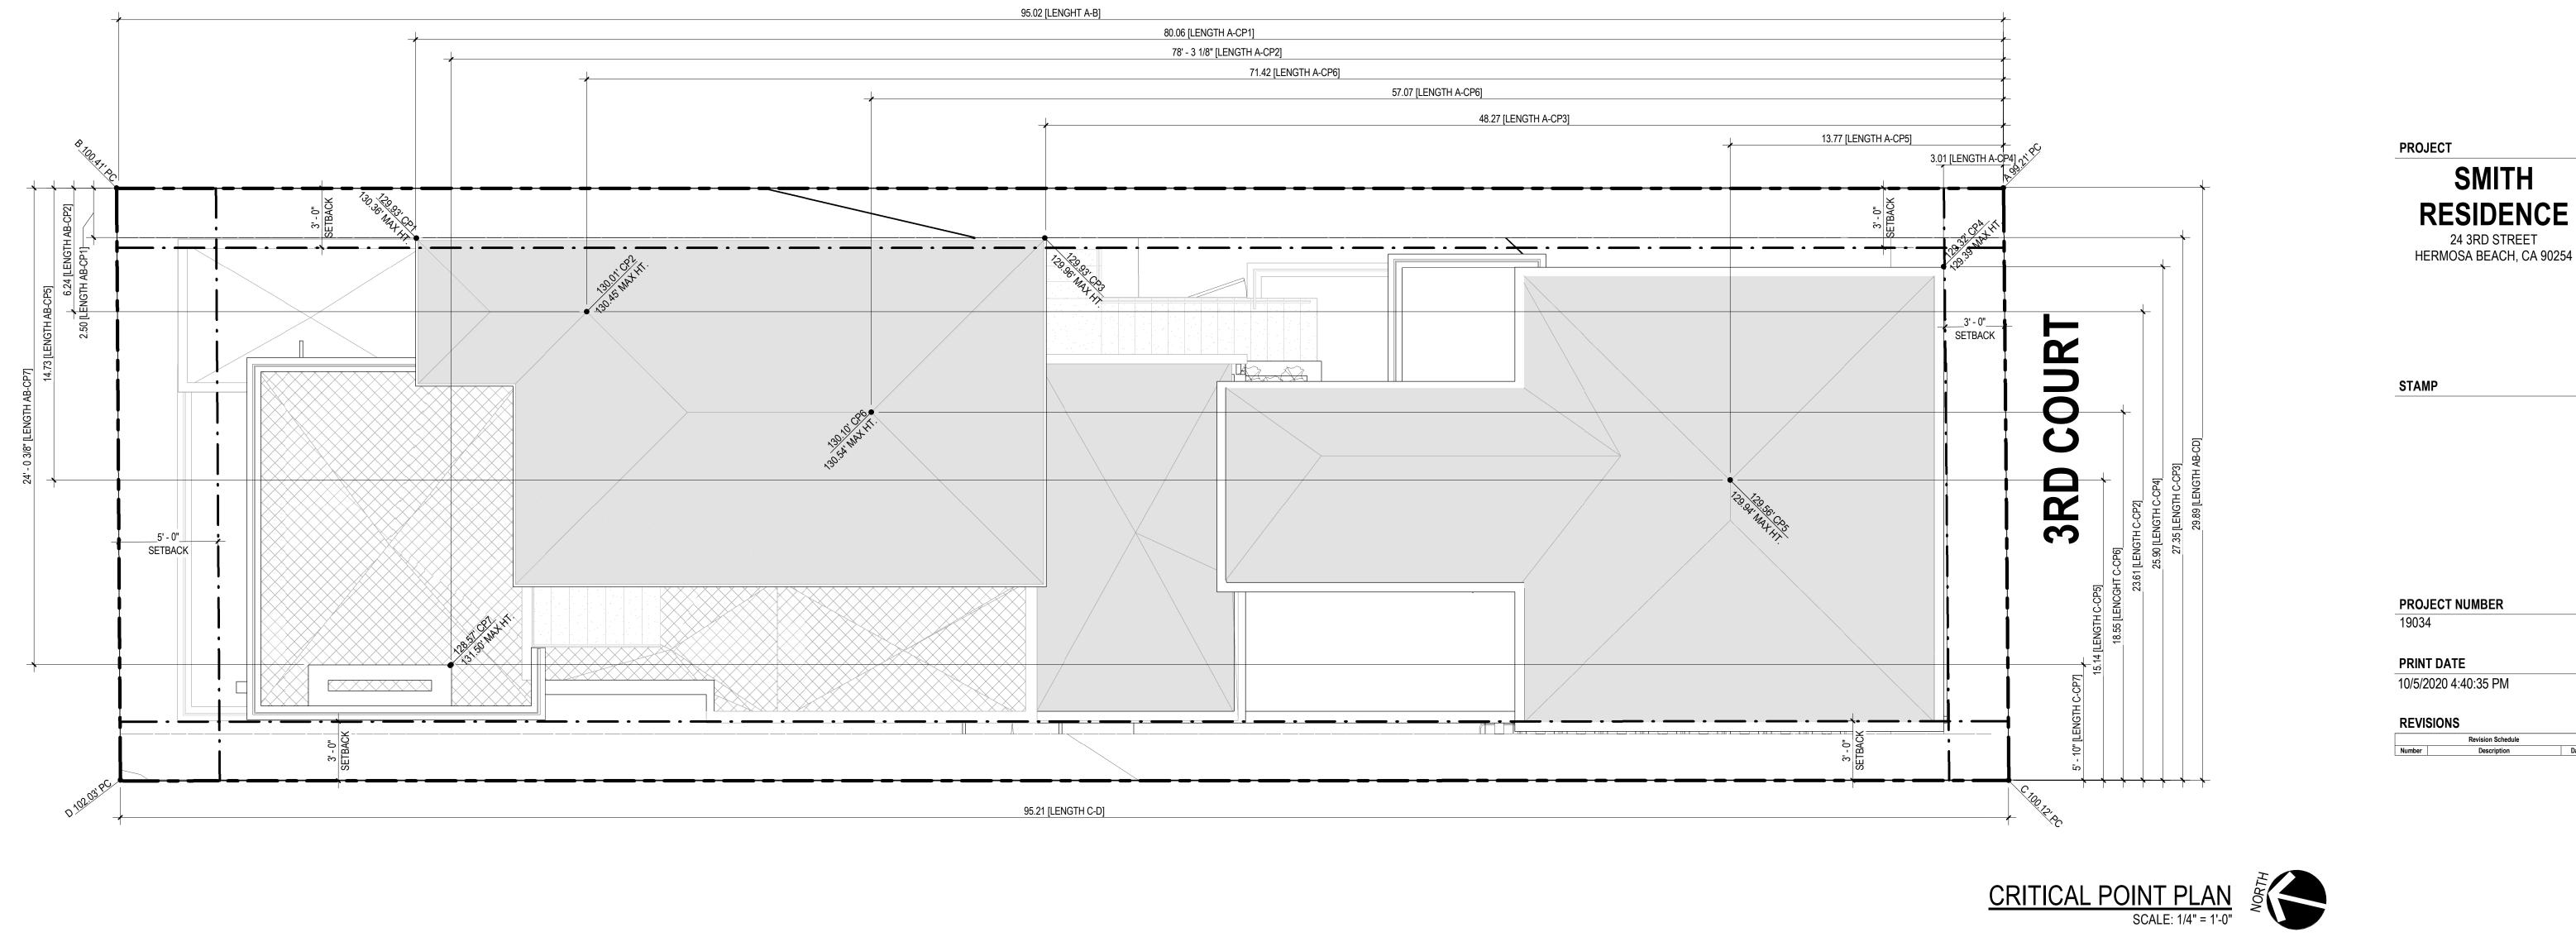



DRAWING **CRITICAL POINT** DIMENSION PLAN

TOMARO DESIGN GROUP EXPRESSLY RESERVES ITS COMMON LAW COPYRIGHT AND OTHER PROPERTY RIGHTS IN THESE PLANS. THESE PLANS ARE NOT TO BE REPRODUCED, CHANGED OR COPIES IN ANY FORM OR MANNER WHATSOEVER, NOR ARE THEY TO BE ASSIGNED TO ANY THIRD PARTY WITHOUT FIRST OBTAINING THE EXPRESS WRITTEN PERMISSION AND CONSENT OF TOMARO DESIGN GROUP.

Date


COPYRIGHT

ARCHITECTURE 2617 NORTH SEPULVEDA BLVD. MANHATTAN BEACH, CA 90266

TEL: 310-318-8089 WWW.TOMARO.COM

TOMARO



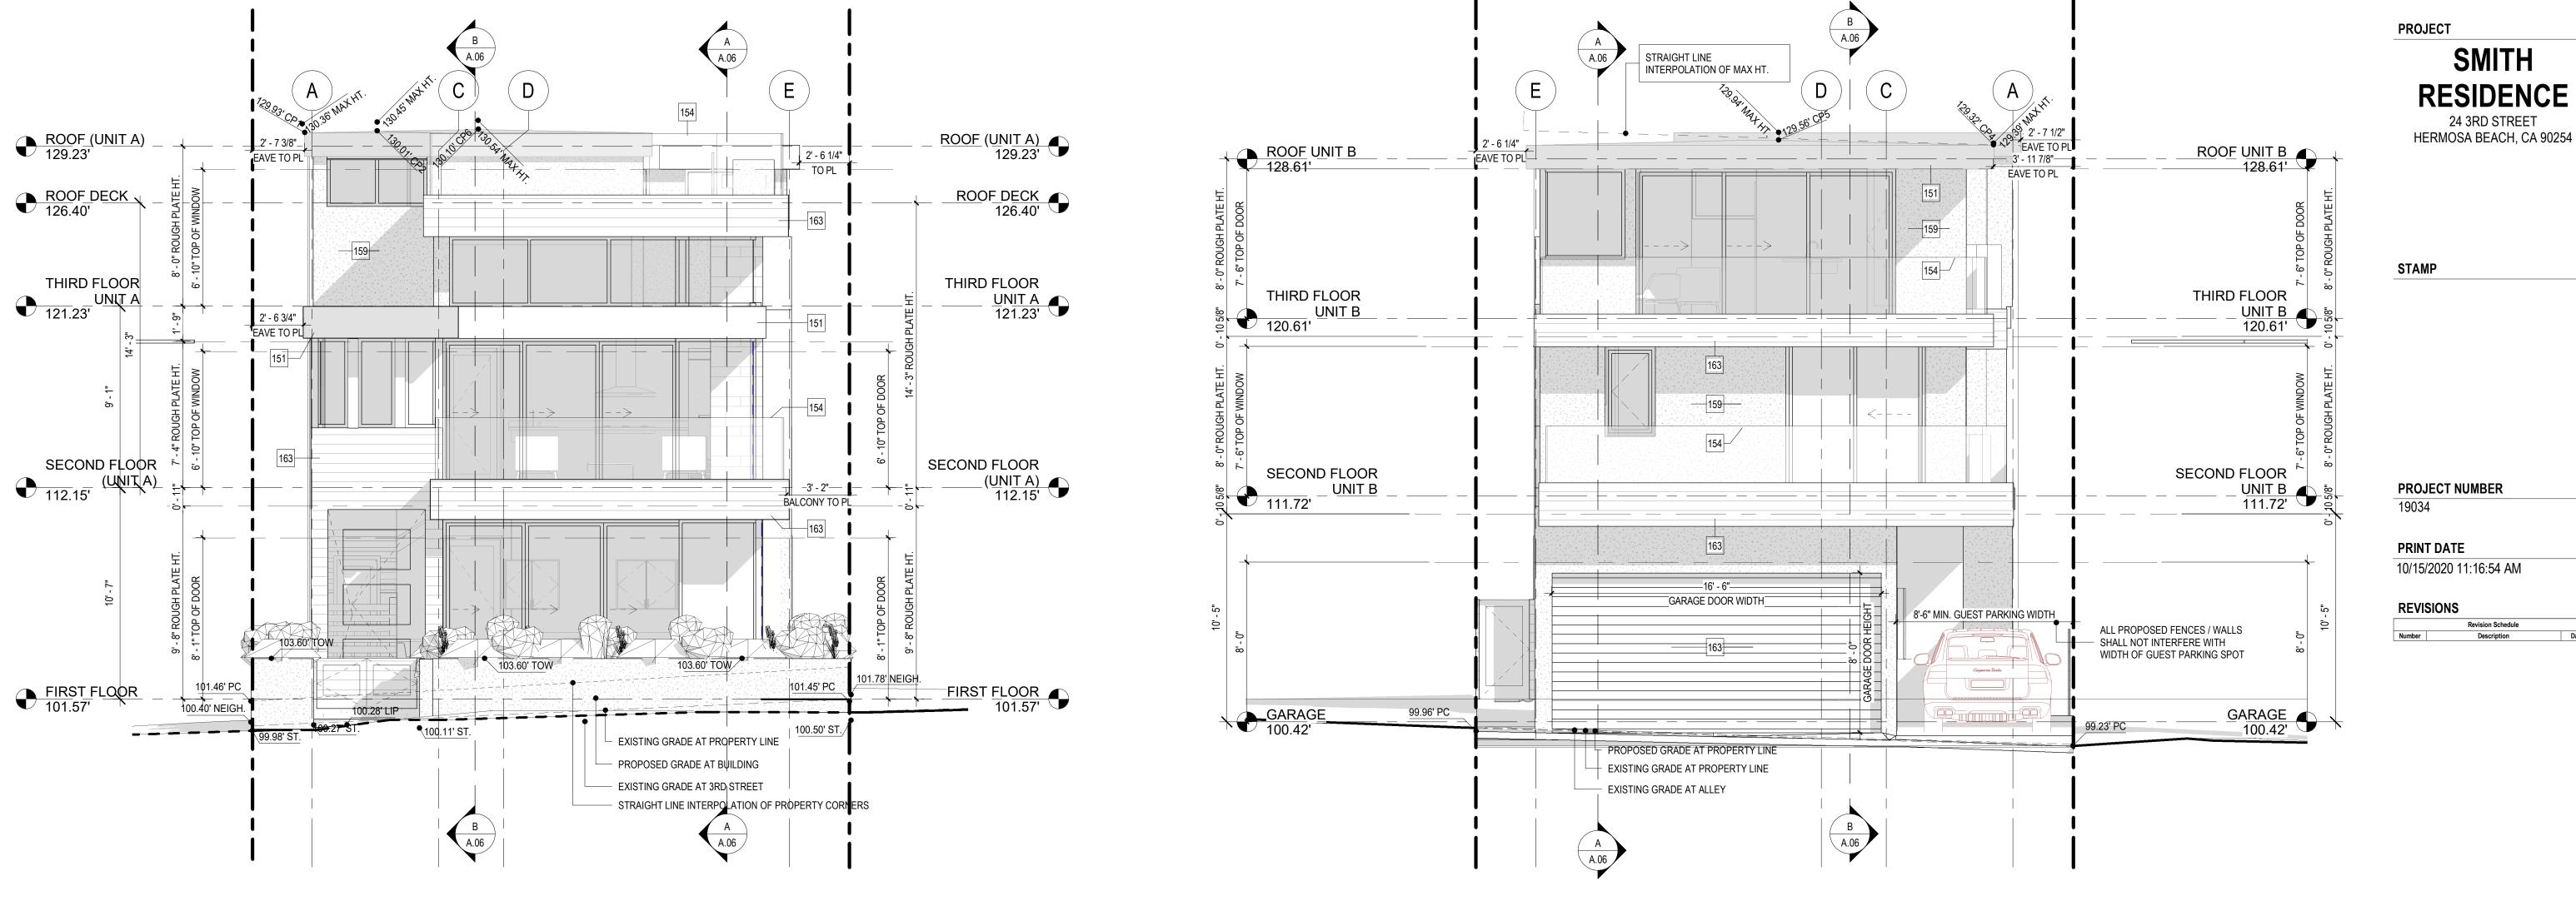

NORTH ELEVATION SCALE: 1/4" = 1'-0"

KEYNOTE LEGEND

KEYNOTE TEXT

SYM

- 151 EAVES: BONDERIZED METAL FASCIA
- 154 DECK RAILING: CLEAR GLASS RAILING IN METAL BASE CHANNEL. 159 STUCCO: 7/8" SMOOTH TROWEL FINISH STUCCO PLASTER OVER WIRE LATH ATTACHED WITH 8d COOLER NAILS @ 6" O.C. OWNER AND ARCHITECT TO SELECT
- AND/OR APPROVE COLOR 163 TRESPA WOOD SIDING: 1X6 WOOD SIDING OVER #15 FELT PAPER (OWNER TO SPECIFY COLOR)



2617 NORTH SEPULVEDA BLVD. MANHATTAN BEACH, CA 90266 TEL: 310-318-8089 WWW.TOMARO.COM



COPYRIGHT

TOMARO DESIGN GROUP EXPRESSLY RESERVES ITS COMMON LAW COPYRIGHT AND OTHER PROPERTY RIGHTS IN THESE PLANS. THESE PLANS ARE NOT TO BE REPRODUCED, CHANGED OR COPIES IN ANY FORM OR MANNER WHATSOEVER, NOR ARE THEY TO BE ASSIGNED TO ANY THIRD PARTY WITHOUT FIRST OBTAINING THE EXPRESS WRITTEN PERMISSION AND CONSENT OF TOMARO DESIGN GROUP


ELEVATIONS

Date

DRAWING

SHEET NUMBER

A.05

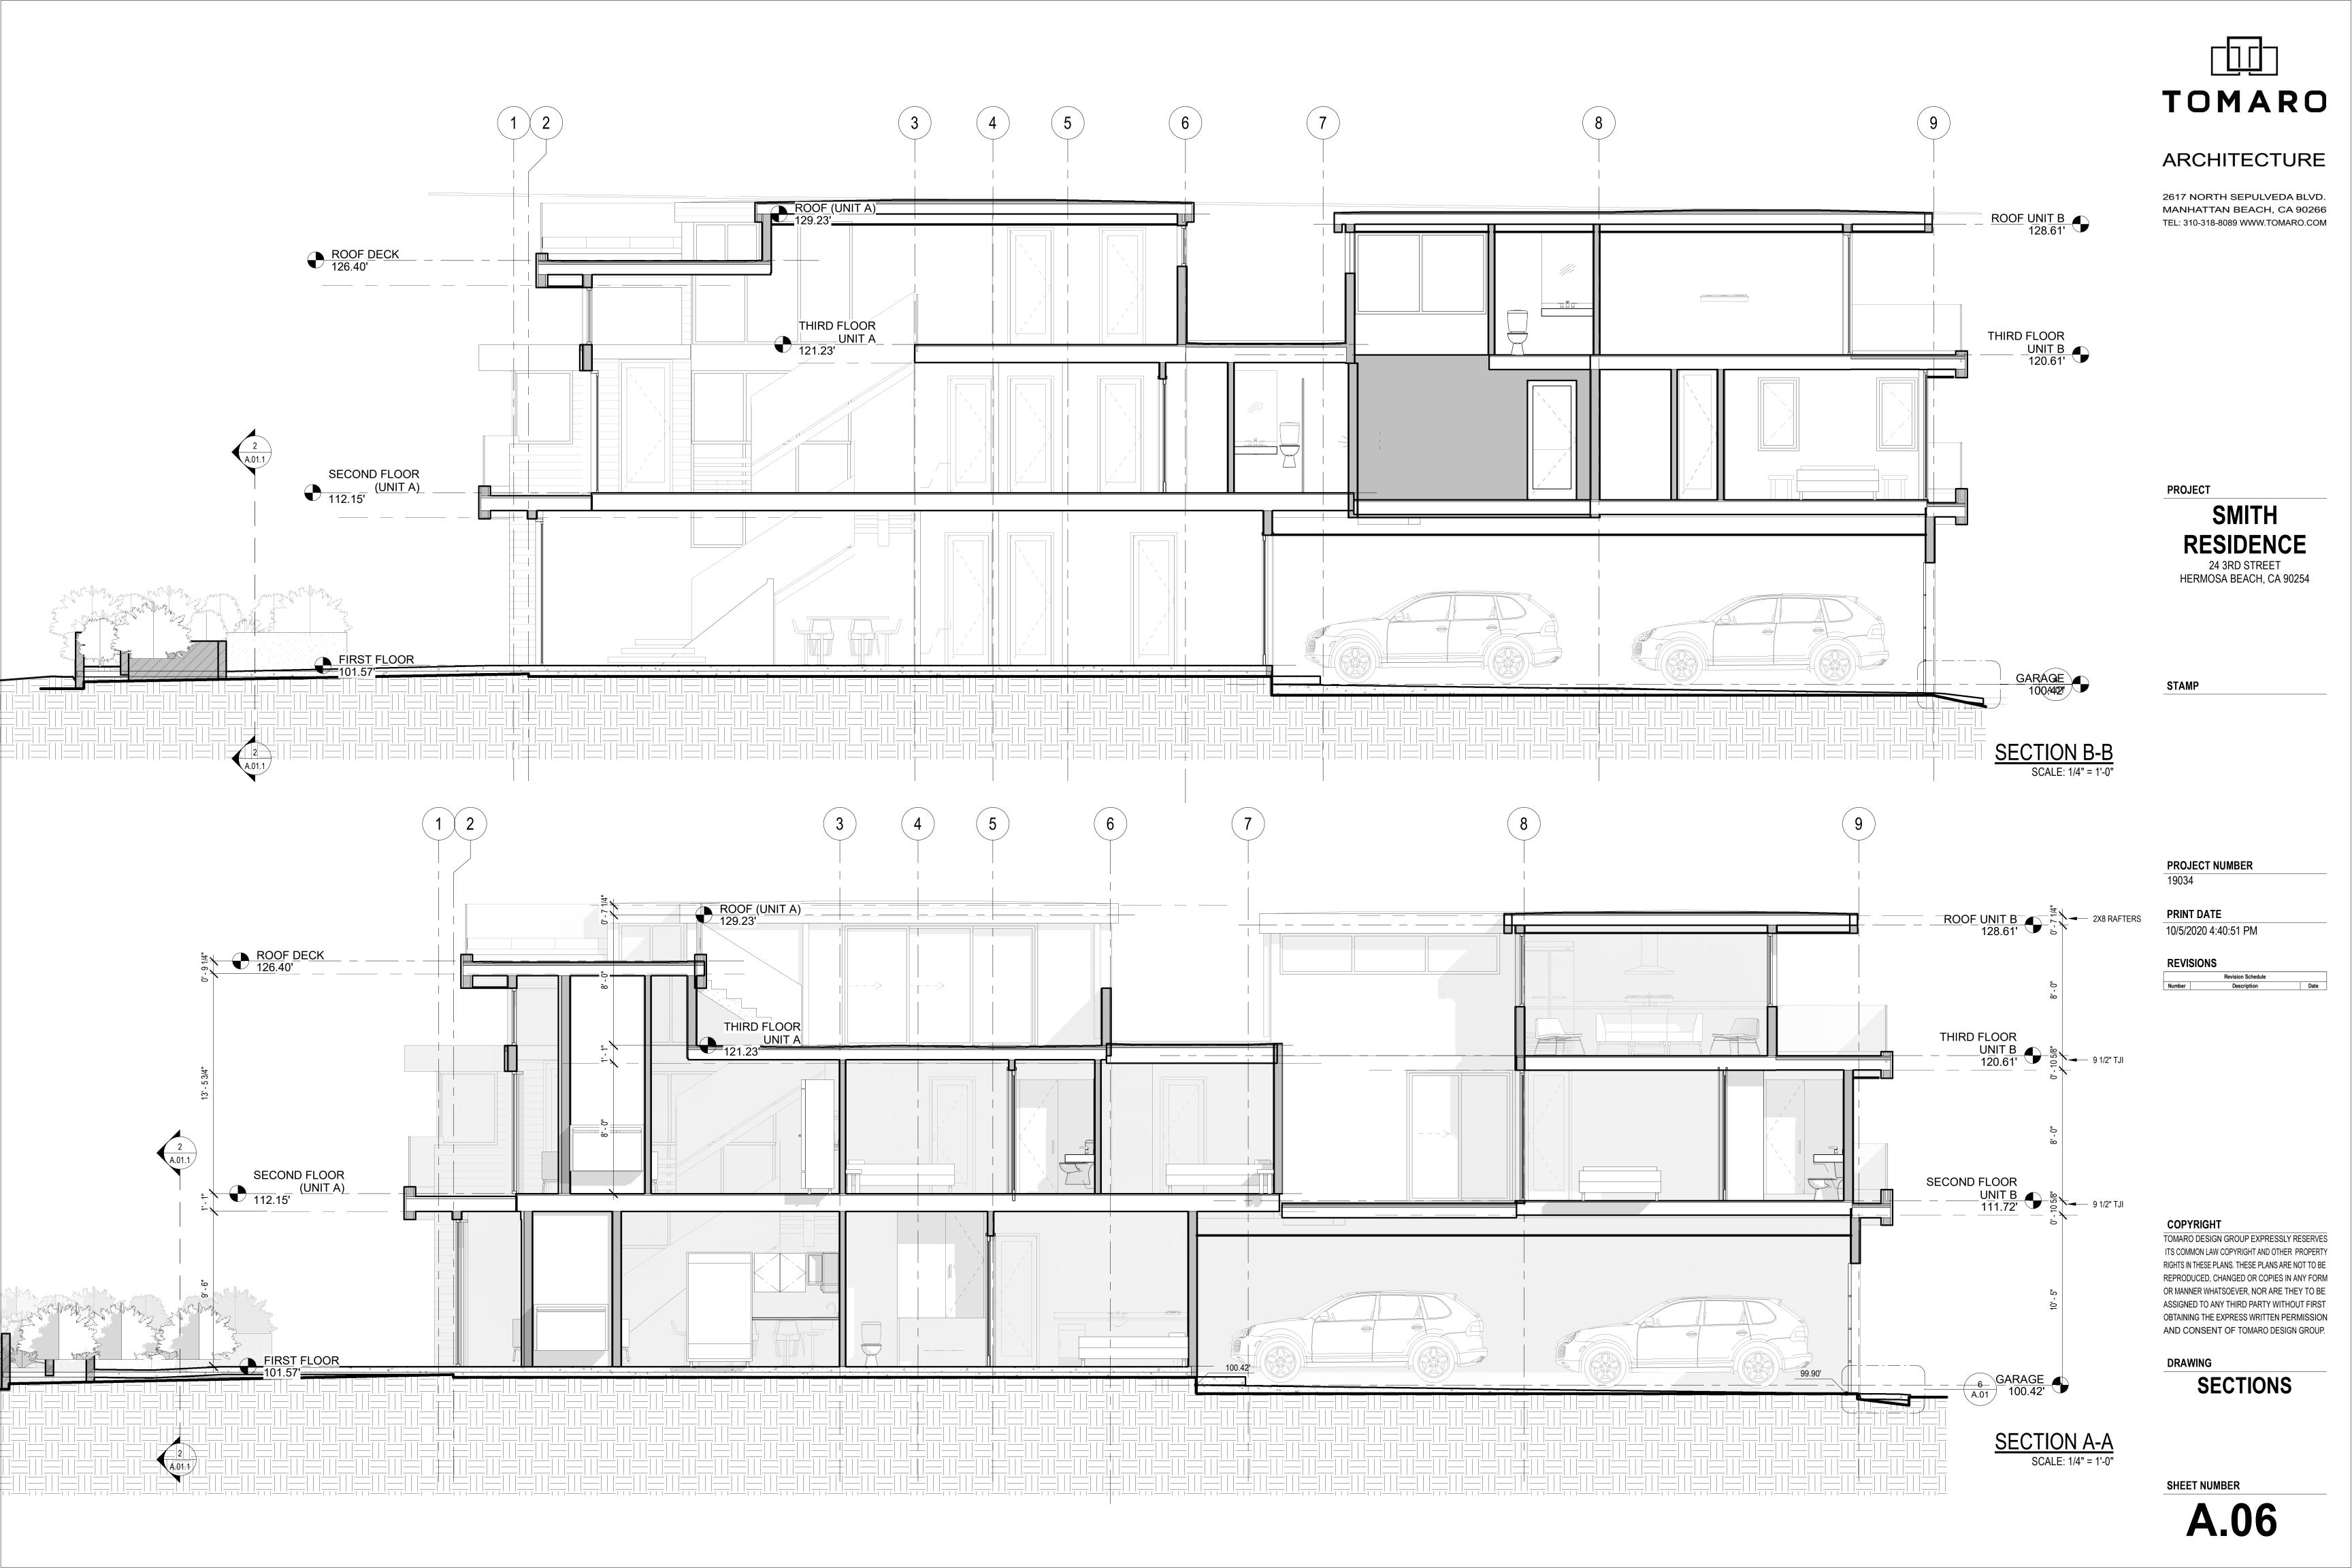

PUBLIC WORKS STANDARD NOTES

GENERAL CONSTRUCTION NOTES:

- 1. CONSTRUCTION WORK HOURS ARE LIMITED TO 8:00 AM TO 6:00 PM, MONDAY THROUGH FRIDAY. WORK PROHIBITED ON SATURDAYS, SUNDAYS AND NATIONAL HOLIDAYS.
- 2. ALL WORK SHALL BE DONE IN ACCORDANCE WITH THESE PLANS, THE LATEST EDITION OF THE STANDARD SPECIFICATIONS FOR PUBLIC WORKS CONSTRUCTION ("GREENBOOK"), AND CITY OF HERMOSA BEACH PUBLIC WORKS STANDARD PLANS
- 3. ALL WORK DONE WITHIN THE PUBLIC RIGHT-OF-WAY SHALL BE DONE BY A LICENSED CONTRACTOR WITH A CLASS A; C-8 OR C-12 LICENSE FOR ALL SIDEWALK, CURB AND GUTTER; C-12 LICENSE FOR ALL STREET PAVEMENT WORK; AND CLASS C-34 LICENSE FOR UTILITY WORK SUCH AS SEWER LATERAL, SEWER CAP AND UNDERGROUND UTILITY WORK IN CONJUNCTION WITH A SINGLE FAMILY RESIDENTIAL STRUCTURE.
- 4. IT SHALL BE THE CONTRACTOR'S RESPONSIBILITY TO OBTAIN ALL NECESSARY PERMITS. PUBLIC WORKS TEMPORARY RIGHT-OF-WAY PERMITS ARE REQUIRED FOR ANY SCAFFOLDING, UTILITY TRENCHING, LUMBER DROPS, CRANES, DUMPSTERS, ETC ON PUBLIC PROPERTY. THE PUBLIC WORKS PERMIT MUST BE ON THE JOB SITE AND AVAILABLE FOR REVIEW BY CITY OFFICIALS AT ALL TIMES. IF ANY WORK HAS BEGUN BEFORE OBTAINING A PERMIT, THE JOB WILL BE STOPPED UNTIL THE PERMIT IS OBTAINED.
- 5. ALL CONTRACTORS WORKING ON PUBLIC WORKS PROJECTS MUST HAVE A CURRENT CITY OF HERMOSA BEACH BUSINESS LICENSE.
- 6. THE CONTRACTOR SHALL CALL IN A LOCATION REQUEST TO UNDERGROUND SERVICE ALERT (USA) AT (800) 227-2600 TWO WORKING DAYS BEFORE PERFORMING ANY DIGGING. SECTION 4216/4217 OF THE GOVERNMENT CODE REQUIRES THAT A DIGALERT IDENTIFICATION NUMBER BE ISSUED BEFORE A "PERMIT TO EXCAVATE" WILL BE VALID.
- 7. ALL EXCAVATIONS SHALL BE BACKFILLED AT THE END OF EACH WORKING DAY AND ROADS OPENED TO VEHICULAR TRAFFIC UNLESS OTHERWISE APPROVED BY THE CITY ENGINEER.
- 8. CONTACT PUBLIC WORKS FOR INSPECTION AT LEAST 24 HOURS IN ADVANCE INSPECTIONS ARE AVAILABLE MONDAY THROUGH FRIDAY, 8:30 A.M. TO 12:00 A.M. AND 1:00 P.M. TO 4:30 P.M.; OFFICE COUNTER ASSISTANCE IS AVAILABLE FROM 7:00 A.M. TO 8:30 A.M. AND 4:30 P.M. TO 6:00 РМ
- 9. ALL FORMS AND COMPACTION SHALL BE INSPECTED PRIOR TO ANY CONCRETE POUR OR ASPHALT BEING PLACED.
- 10. ALL SURVEY POINTS AND MONUMENTS SHALL BE PROTECTED IN PLACE OR RE-ESTABLISHED IF THEY ARE REMOVED OR DESTROYED DURING CONSTRUCTION.
- 11. THE CONTRACTOR IS RESPONSIBLE FOR EROSION CONTROL, DUST CONTROL, AND TEMPORARY DRAINAGE CONTROL AT ALL TIMES.
- 12. ALL CONSTRUCTION TO BE IN CONFORMANCE WITH THE REGULATIONS OF CAL-OSHA.

GENERAL NOTES FOR STREET AND STORM DRAIN IMPROVEMENTS:

- 1. ALL STREET CLOSURES REQUIRE A TRAFFIC CONTROL PLAN TO BE REVIEWED AND APPROVED BY THE CITY ENGINEER PRIOR TO CONSTRUCTION. ALL TRAFFIC CONTROL SHALL BE PER THE WORK AREA TRAFFIC CONTROL HANDBOOK (WATCH) MANUAL. STREET CLOSURES APPROVED BY THE CITY ENGINEER WILL REQUIRE A MINIMUM OF 48 HOUR NOTICE TO BE POSTED AND DISTRIBUTED WITH PROPER DOOR-HANGERS TO ALL RESIDENCES ON SAME BLOCK. THE CONTRACTOR SHALL ALSO NOTIFY THE DISPATCH CENTER FOR HERMOSA BEACH POLICE AND FIRE DEPARTMENTS AT (310) 524-2750 OF ANY CLOSURES OR RESTRICTIONS IN ACCESS.
- GRAFFITI IN FRESHLY POURED CONCRETE SHALL BE REMOVED BY WHATEVER MEANS NECESSARY UP TO AND INCLUDING REMOVAL AND REPLACEMENT.
- 3. ANY ASPHALT OR CONCRETE PAVEMENT WITHIN THE PROPERTY LIMITS THAT IS DAMAGED PRIOR TO CONSTRUCTION SHALL BE REMOVED AND REPLACED TO MEET CURRENT CITY STANDARDS.
- 4. ANY PUBLIC PROPERTY DAMAGED DURING CONSTRUCTION SHALL BE REPLACED IN KIND OR BETTER TO THE SATISFACTION OF THE CITY PUBLIC WORKS INSPECTOR. THE CITY SHALL AT ITS DISCRETION, AND IN THE INTEREST OF PUBLIC SAFETY, MAKE ANY REPAIRS DEEMED NECESSARY; THE COST OF WHICH WILL BE DEDUCTED FROM THE DEPOSIT HELD BY THE CITY.
- 5. ALL EXISTING PAVEMENT TO BE REMOVED SHALL BE SAW-CUT OR WHEEL-CUT AND REMOVED TO CLEAN STRAIGHT LINES.
- 6. AT ALL LOCATIONS WHERE NEW PAVEMENT JOINS EXISTING, THE EXISTING PAVEMENT SHALL BE COATED WITH AN ASPHALTIC EMULSION.

GENERAL NOTES FOR SEWER AND UTILITY IMPROVEMENTS:

- SEPARATION OF SEWER AND WATER FACILITIES SHALL BE IN CONFORMANCE WITH LATEST EDITION OF THE STATE OF CALIFORNIA DEPT OF HEALTH SERVICES.
- 2. SEWER LATERALS SHALL BE CONNECTED TO THE SEWER MAIN WITH WYES.
- 3. THE SEWER LINE SHALL BE TESTED PRIOR TO MAKING PERMANENT SERVICE CONNECTIONS.
- 4. BACKFILL OF TRENCHES SHALL BE DONE IN LIFTS OF NO MORE THAN 8-INCHES WITH WATER AND APPROPRIATE COMPACTION TOOLS USED BETWEEN EACH LIFT. ONE SACK SLURRY MIX CAN BE USED IN PLACE OF NATIVE SOIL. AFTER BACKFILLING THE TRENCH, A TEMPORARY ASPHALT PATCH SHALL BE PLACED OVER THE TRENCH AND REMAIN FOR NO MORE THAN TWO WEEKS. THE FINAL PATCH SHALL BE A MINIMUM OF 5" THICK OR 1" THICKER THAN THE EXISTING PAVEMENT. THE CONTRACTOR SHALL FOLLOW THE LATEST HERMOSA BEACH STANDARD PLANS FOR AC AND P.C.C. PAVEMENT.
- 5. THE FINAL PATCH IN ASPHALT STREETS SHALL BE DONE IN TWO LIFTS, A BASE OF 3" MINIMUM 3/4" AGGREGATE AND A TOP LIFT OF 2" OF 3/8" AGGREGATE. ALL EDGES OF THE CUT ASPHALT TO BE TACKED THOROUGHLY AND THE PATCH COMPACTED BY MECHANICAL MEANS TO A HEIGHT SLIGHTLY HIGHER THAN THE EXISTING ASPHALT AND ALL EDGES TO BE TACKLE.
- 6. THE FINAL PATCH ON CONCRETE STREETS TO BE CLASS 3500 P.S.I (7 SACK), EXISTING CONCRETE TO BE DRILLED TWO AND ONE HALF INCHES (2 ½") BELOW THE SURFACE TO A DEPTH OF 6" MINIMUM AND DOWELLED WITH #5 REBAR ON 18" SPACING. FINISH TO MATCH EXISTING OR MEDIUM BROOM.
- 7. ALL UTILITY BOXES ARE TO BE ADJUSTED TO THE NEW GRADE. DAMAGED BOXES SHALL BE REPLACED. KEEP ALL UTILITY BOXES OUT OF DRAINAGE FLOW LINES, CURB RETURNS, DRIVEWAY APPROACH AND WHEEL CHAIR RAMPS, UNLESS APPROVED BY THE CITY ENGINEER.

BENCH MARK:

TEMPORARY BENCHMARK TO BE N&T RCE 30826 2.00' S'LY OF CORNER ON PROP. LINE PROP. ELEVATION. 100.17 FEET. SEE KEYNOTE (5) ON C-1.



JOB SAFETY REQUIREMENTS:

- TRAFFIC CONTROL HANDBOOK (WATCH) MANUAL.
- PEDESTRIANS AT ALL TIMES.
- CONSTRUCTED.
- 6. ALL WORK VEHICLES ARE SUBJECT TO ALL APPLICABLE PARKING RESTRICTIONS.
- TO USE THE OPPOSING LANE TO PASS.

WATER QUALITY REQUIREMENTS:

- DRAIN SYSTEM.
- TIMES.

6. DURING CONSTRUCTION:

- SEAL, ETC.
- COLLECT AND RECYCLE EXCESS ABRASIVE GRAVEL OR SAND.

- UNDER MACHINE WHEN NOT IN USE.

PROJECT DESCRIPTION:

NEW 3 STORY DUPLEX WITH A JADU. LOT AREA: 2,843 SF.

DRAINAGE NOTE:

PROVISIONS FOR CONTRIBUTORY DRAINAGE SHALL BE MADE AT ALL TIMES.

GRADING NOTES:

- APPROVED ROUTE ON VICINITY MAP HEREIN.
- 2. OFFSITE GRADING APPROVAL MUST BE OBTAINED IN WRITING.
- 3. BORROW OR DISPOSAL SITE MUST BE PERMITTED & BONDED (IF WITHIN CITY) AND PERMITTED.
- FIRST FLOOR.
- FONT 2" HEIGHT AND $\frac{1}{4}$ " DEPTH.
- RECEIVING PUBLIC WORKS FINAL SIGN OFF.
- WITH THE SOILS REPORT RECOMMENDATIONS.

TOTAL	CUT SOILS:
TOTAL	FILL SOILS:
TOTAL	EXPORT SOILS:

TOTAL IMPORT SOILS:

AND NO GUARANTEE IS EXPRESSED OR IMPLIED REGARDING THEIR ACCURACY.

	REVISIONS							
No.	DESCRIPTION	DATE						
\bigtriangleup								

1. PROPER BARRICADES SHALL BE PLACED AROUND ANY CONSTRUCTION SITE WITHIN THE PUBLIC RIGHT-OF-WAY. THESE BARRICADES SHALL COMPLY WITH THE REQUIREMENTS OF THE WORK AREA

2. ALL CONSTRUCTION FENCING SHALL BE BEHIND THE SIDEWALK AND ALL CONSTRUCTION MATERIAL WITHOUT PERMITS ARE TO BE BEHIND THE FENCE. SIDEWALKS ARE TO BE ACCESSIBLE TO

3. NO CONSTRUCTION EQUIPMENT, CONSTRUCTION MATERIAL, PORTABLE TOILETS, DUMPSTERS, ETC. SHALL BE LEFT ON THE PUBLIC RIGHT-OF-WAY WITHOUT PROPER PERMITS. THESE OBSTRUCTIONS MUST HAVE PROPER BARRICADES WITH FLASHING YELLOW LIGHTS AFTER DARK

4. ANY PUBLIC SIDEWALK DAMAGED TO THE POINT OF CAUSING A TRIP HAZARD MUST BE REPAIRED IMMEDIATELY. THE PANEL OF CONCRETE SHALL BE REMOVED AND PATCHED WITH A TEMPORARY ASPHALT PATCH AND MUST BE KEPT IN GOOD REPAIR UNTIL THE PERMANENT SIDEWALK IS

5. ALL VEHICLES THAT INTRUDE INTO A NORMAL TRAFFIC LANE MUST HAVE PROPER SIGNAGE AND BARRICADES AS REQUIRED BY THE (WATCH) MANUAL.

7. FLAGMEN ARE REQUIRED FOR ANY VEHICLES THAT BLOCK THE TRAVEL LANE AND REQUIRE TRAFFIC

1. 1PRECAUTIONS SHALL BE TAKEN TO PREVENT ANY CONSTRUCTION MATERIAL DEBRIS OR RUNOFF FROM ENTERING ANY PUBLIC RIGHT-OF-WAY OR COUNTY STORM DRAIN. ALL SAW CUT RESIDUE MUST BE RETAINED WITH BERMS OR SANDBAGS AND VACUUMED TO PREVENT IT FROM ENTERING INTO ANY STORM

2. SANDBAGS ARE REQUIRED FOR EROSION CONTROL DURING THE RAINY SEASON, OCTOBER 15TH THROUGH APRIL 15TH, AND MAY BE REQUIRED AT OTHER TIMES. SANDBAGS ARE REQUIRED AT NEARBY CATCH BASINS DURING CONSTRUCTION. SANDBAGS SHALL BE MAINTAINED AND IN GOOD CONDITION AT ALL

3. MAKE SURE BROKEN PAVEMENT DOES NOT COME IN CONTACT WITH RAINFALL OR RUNOFF.

4. SHOVEL OR VACUUM SAW-CUT SLURRY AND REMOVE FROM THE SITE. FOR DISPOSAL INFORMATION CONTACT THE L.A. COUNTY DEPARTMENT OF PUBLIC WORKS AT 800-552-5218.

5. COVER OR BARRICADE STORM DRAIN OPENINGS DURING SAW-CUTTING.

PROTECT CATCH BASINS AND MAINTENANCE HOLES WHEN APPLYING SEAL COAT, SLURRY SEAL, FOG

USE CHECK DAMS, DITCHES OR BERMS TO DIVERT RUNOFF AROUND EXCAVATIONS.

AVOID OVER-APPLICATION BY WATER TRUCKS FOR DUST CONTROL

NEVER HOSE DOWN "DIRTY" PAVEMENT OR SURFACES. CLEAN UP ALL SPILLS AND LEAKS USING "DRY" METHODS (WITH ABSORBENT MATERIALS AND /OR RAGES), OR DIG UP AND REMOVE CONTAMINATED SOIL. FOR DISPOSAL INFORMATION CALL (800) 552-5218. CATCH DRIPS FROM PAVER WITH DRIP PANS OR ABSORBENT MATERIAL (CLOTH, RAGS, ETC.) PLACED

1. HAUL ROUTE MUST BE APPROVED BY ENGINEERING SERVICES. SEE CITY'S

4. SEWER MAIN/LATERAL SHALL BE CONSTRUCTED PRIOR TO CONSTRUCTION OF

5. UTILITY LINES LOCATION SHALL BE PERMANENTLY IDENTIFIED ON CURB FACE.

6. IT IS RESPONSIBILITY OF DEVELOPER TO HAVE ALL STRIPING AND UTILITY TRENCHES PROPERLY RESTORED PER CITY STANDARD PLANS PRIOR TO

7. IF SHORING REQUIRED, CONTRACTOR SHALL PROVIDE PRIOR TO ANY EXCAVATION ACTIVITY A "SHORING PLAN" DESIGNED TO BE IN ACCORDANCE

PROJECT CUBIC YARDAGE DATA

20 CUBIC YARDS ±

0 CUBIC YARDS \pm

- 20 CUBIC YARDS ±
- 0 CUBIC YARDS \pm

1. CONTRACTOR IS RESPONSIBLE FOR COMPLETING HIS OWN CUT AND FILL CALCULATIONS. VOLUMES SHOWN ARE FOR OWNERS PLANNING PURPOSES ONLY


OWNER'S INFORMATION

BARRY AND JILL SMITH 24 3RD STREET, SUITE C HERMOSA BEACH, CA 90254


> SURVEYOR: 3914 DEL AMO BLVD. STE. 921

TORRANCE, CA 90503

PLANS PREPARED BY: CITY OF HE PUBLIC WORK RECOMMENDED FOR PERU CONSULTANTS, INC **CIVIL ENGINEERING & DRAFTING SERVICES** 09/15/2020 1976 W 234th Street, Torrance, CA 90501 Ph: (310) 270-0811 email: peruconsultants@live.com DATE CHRISTIAN J. PEREZ, RCE LICENSE No. 80680

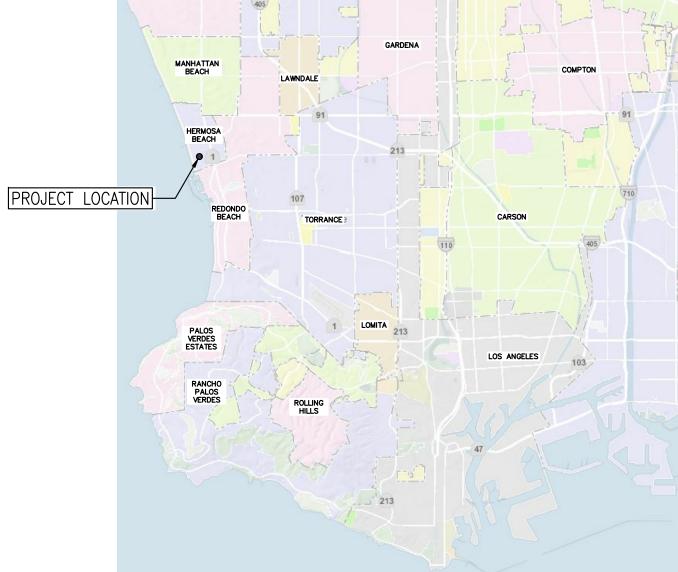

VICINITY MAP

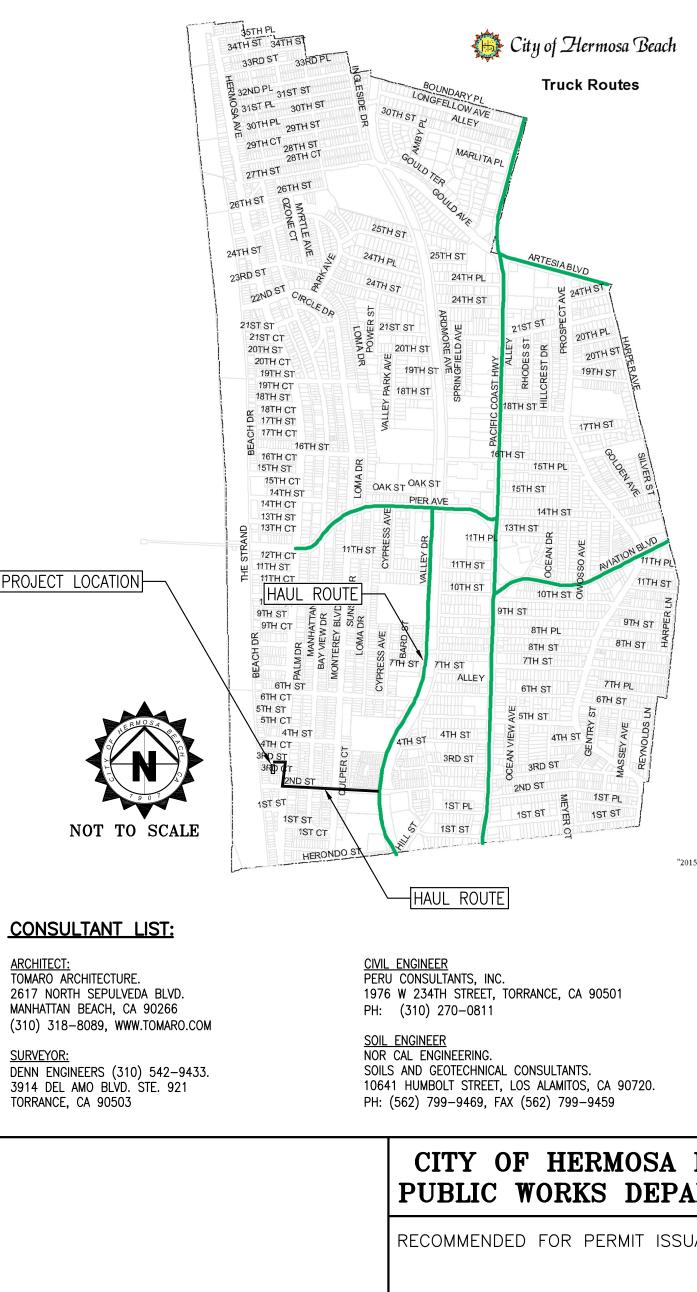

REGIONAL MAP



SHEET INDEX

- TITLE SHEET C-0
- C-1 GRADING & DRAINAGE PLAN
- C-2 PUBLIC IMPROVEMENTS
- C-3 DETAILS
- DRIVEWAY PROFILE AND SECTIONS C-4
- EROSION CONTROL PLAN C-5

PROPERTY INFORMATION:

APN: 4188-007-009 HERMOSA BEACH LOT 9 BLOCK 3. LATITUDE & LONGITUDE: 33°51'18.9"N 118°23'54.9"W PROPERTY TYPE: R3 LOT SIZE: 2,843 SF SITE ADDRESS: 24 3RD STREET, HERMOSA BEACH, CA 90254

LID INFORMATION

SOIL INFILTRATION RATE: 120 IN/HR (FS=2.0) SOIL TYPE: SILTY SAND BMP TYPE: INFILTRATION TOTAL DRAINAGE AREA (ACRES): 0.065 ACRES

IMPERVIOUS AREA: 3,282 SF PERVIOUS AREA: 210 SF PDESIGN: 0.80 IN

CATCHMENT AREA (SF) = IMPERVIOUS AREA (SF)*0.9 + PERVIOUS AREA (SF)*0.1 SWQDV (CF) = CATCHMENT AREA (SF)*PDESIGN*0.083(FT/IN)

CATCHMENT AREA (SF) = 2,975 SFSWQDV (CF) = 198 CF

STORAGE CAPACITY (CUBIC FEET): 725 CF (ONE SINGLE ECORAIN TANK) STORM WATER QUALITY DESIGN VOLUME (CUBIC FEET): 198 CF

GEOTECHNICAL ENGINEERING CONSULTANT STATEMENT

THE UNDERSIGNED GEOTECHNICAL ENGINEERING HAVE REVIEWED THESE PLANS. AND FOUND THEM TO BE IN COMPLIANCE WITH THE RECOMMENDATIONS AND GUIDELINES OF NORCAL ENGINEERING REPORT DATED <u>03/30/2020</u>, PROJECT No. <u>21721-20</u>.

GEOTECHNICAL ENGINEER: KEITH D. TUCKER R.G.E 841 DATE

STAMP

STANDARD DESING PLATES & DETAILS

STANDARD PLAN FOR PUBLIC WORKS CONSTRUCTION (2009 EDITION)

- 150–3 CURB DRAIN
- 222-2 HOUSE CONNECTION SEWER


CITY OF HERMOSA BEACH STANDARD DETAILS

- 100 CURBS
- COMBINED CURB AND GUTTER 101
- 102 RESIDENTIAL DRIVEWAY
- 106 SIDEWALK
- CONCRETE PAVEMENT REPLACEMENT 115
- SIDEWALK & DRIVEWAY REPLACEMENT 116
- 117 UTILITY TRENCH REPAIR

LEGEND & ABBREVIATIONS:

FOR LEGEND AND ABBREVIATIONS, SEE DRAWING C-1.

A 90501		SUBMITTALS					
	No.	DESCRIPTION	DATE	No.	DESCRIPTION		DATE
	1	1ST SUBMITTAL	04/30/2020	4	4TH SUBMITTAL		09/15/2020
ITS. OS, CA 90720.	2	2ND SUBMITTAL	07/16/2020				
9–9459	3	3RD SUBMITTAL	08/06/2020				
ERMOSA BEACH	זת		OVEND	יזאה	T DIANC		NUMBER
KS DEPARTMENT	PRIVATE IMPROVEMENT PLANS					20017-CIVIL	
PERMIT ISSUANCE:		24 3RD) STR	EE	T		G PERMIT: -00173
	CIVIL PLANS						Ο
0.75	TITLE SHEET				U -	-0	
DATE			JIILL	1		SHT.	1_ OF_6_

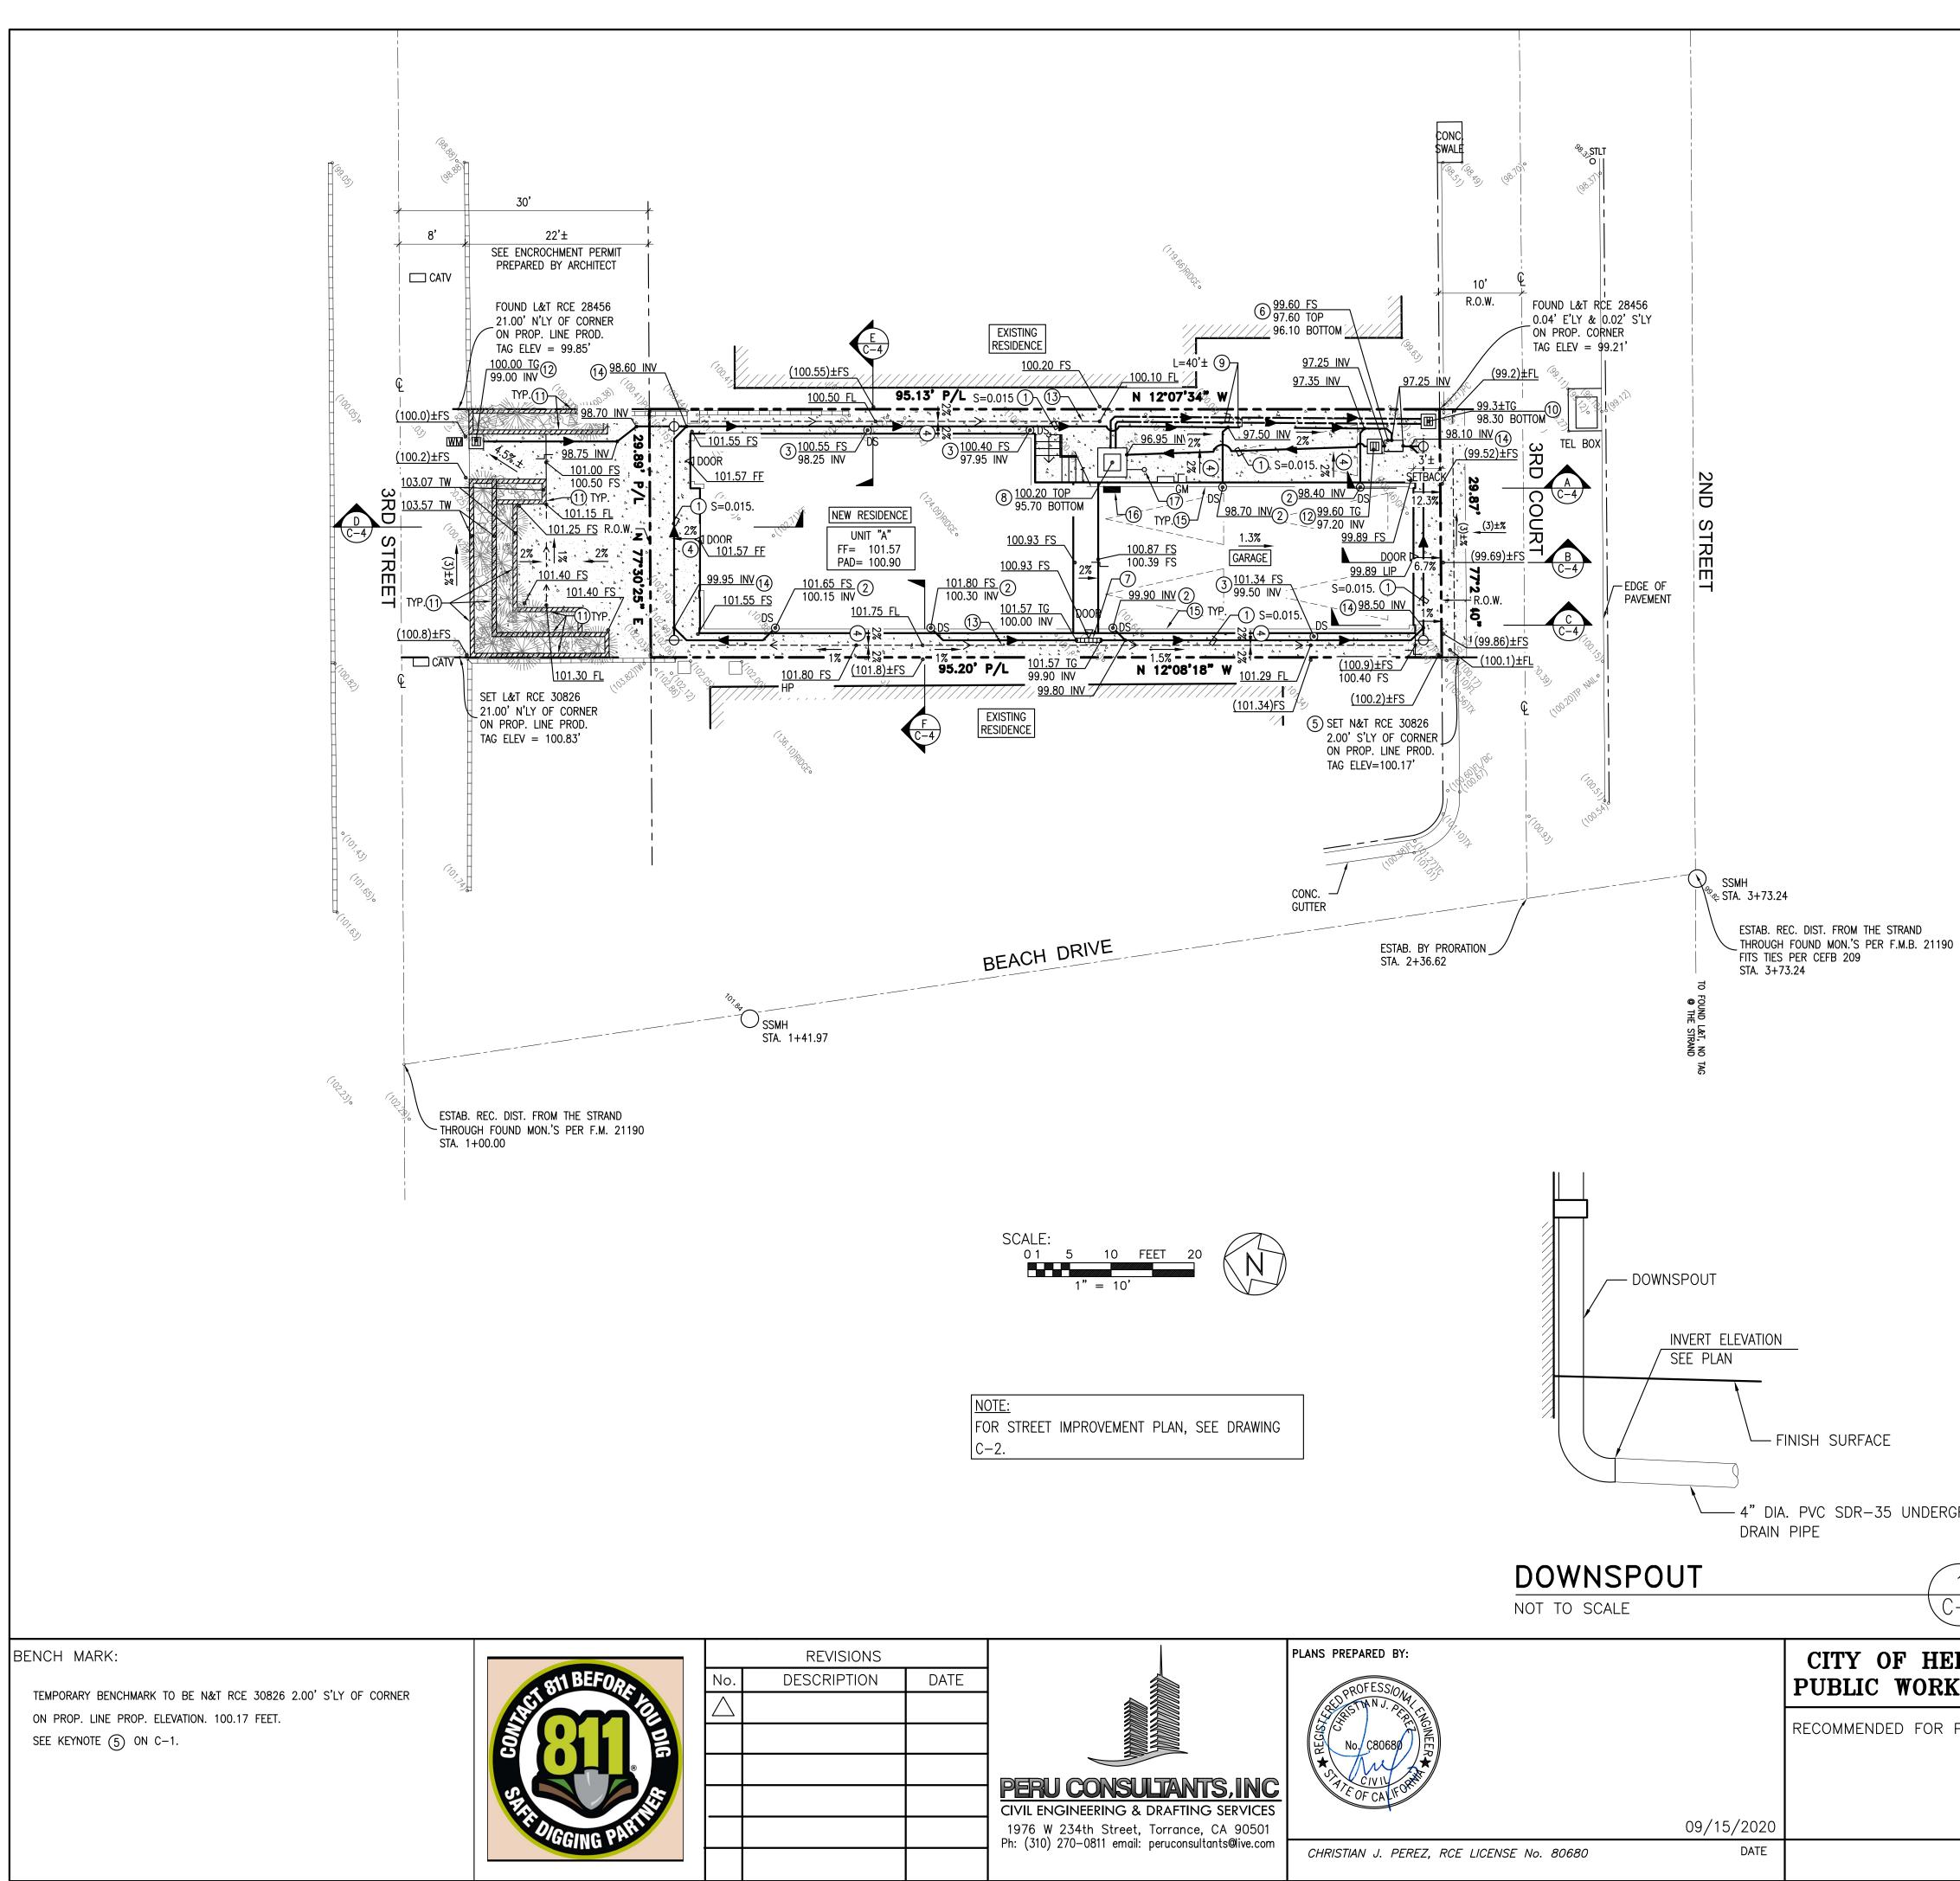

CONSTRUCTION NOTES

- 1 4"ø PVC SDR-35 SOLID PIPE. SLOPE=0.01 MIN.
- (2) DOWNSPOUTS LOCATED INSIDE BUILDING. SEE ARCHITECTURAL DRAWINGS.
- 3 DOWNSPOUTS CONNECTED UNDERGROUND. $\begin{pmatrix} 1 \\ C-1 \end{pmatrix}$
- (4) 5% MIN. SLOPE AWAY FROM BUILDING FOR UNPAVED/LANDSCAPE ADJACENT TO BUILDING AND 2% MIN. SLOPE AWAY FROM BUILDING FOR PAVEMENT ADJACENT TO BUILDING.
- 5 TEMPORARY BENCHMARK (TBM). TO BE N&T RCE 30826 2.00' S'LY OF CORNER ON PROP. LINE PROD. ELEVATION 100.17 FEET
- 6 INSTALL 2.25' X 1.34' X 1.50' DEEP INFILTRATION PIT (1) DOUBLE ECORAIN TANK, INFILTRATION ALLOWED AT THE BOTTOM OF THE TANKS ONLY. WRAP THE SIDES WITH IMPERMEABLE FABRIC. $\begin{pmatrix} 1 \\ 0 \\ -1 \end{pmatrix}$
- 7 4" WIDE TRENCH DRAIN. (2)
- (8) INSTALL (2) ZOELLER PUMP MODEL 53, INSIDE A 2.5' X 2.5' X 4' DEEP SUMP PIT. 3
- (9) (2) 3" DIA. CAST IRON FORCE MAIN.
- (10) 12" x 12" BUBBLER CATCH BASIN. $\begin{pmatrix} 4 \\ C-3 \end{pmatrix}$
- 1) PLANTER WALL. FOR WALL HEIGHT AND DETAILS, SEE ENCROACHMENT PERMIT PREPARED BY ARCHITECT.
- 12"x12" CATCH BASIN WITH FILTER INSERT MANUFACTURED BY KRISTAR ENTERPRISES, INC. (800-579-8819 OR WWW.KRISTAR.COM) MODEL FG-M1212.
- (13) FLOWLINE.
- (14) 6" DIA. STORM DRAIN CLEANOUT.
- (15) FOUNDATION ELEVATION SHALL EXTEND ABOVE FLOW LINE A MINIMUM OF 12 INCHES PER CBC 1808.7.4.
- (16) BACKUP POWER LOCATION. INSTALL TESLA WALL INSIDE GARAGE PER MANUFACTURER'S RECOMMENDATIONS (WWW.TESLA.COM, OR 877-798-3752).


(17) 4" DIA. VENT. PIPE. (3)

ABBREVIATIONS:

LEGEND:

BOTT.	BOTTOM OF BASIN ELEVATION.		CATCH BASIN WITH FILTER INSERT
DS	DOWNSPOUT		FILTER INSERT
(E)	EXISTING	<u> </u>	6" DIA. PVC SDR-35
ELE.	ELEVATION		SANITARY SEWER PIPE
ЕМ	ELECTRICAL METER		4" DIA. PVC SDR-35
FF	FINISH FLOOR		STORM DRAIN PIPE
FL	FLOW LINE		
FS	FINISH SURFACE		LIMIT OF NEW PAVING
FG	FINISH GRADE		
GM	GAS METER		
GTEPB	GTE PULLBOX		BASEMENT LINE
GB	GRADE BREAK		
Н	HEIGHT	\bullet	POINT OF CONNECTION
HP	HIGH POINT		
INV	INVERT ELEVATION	* * * *	
PC	PROPERTY CORNER	* * *	GRASS/LANDSCAPE SURFACE
P.0.C	POINT OF CONNECTION	* * * *	JONIACE
PP	POWER POLE	₹ . ``∆	CONCRETE PAVING
RIM	RIM ELEVATION	а <u>А</u>	SURFACE
SD	STORM DRAIN		
ТС	TOP OF CURB		PERMEABLE SURFACE
TF	TOP OF FOOTING		
TG	TOP OF GRATE		
TVPB	TELEVISION PULL BOX	79.50 FS	PROPOSED ELEVATION
TW	TOP OF WALL		
TYP.	TYPICAL	(79.50)FS	EXISTING ELEVATION
Π.	TOP OF TANK		

		SUBMI	TTALS	5		
No.	DESCRIPTION	DATE	No.	DESCRIPTION		DATE
1	1ST SUBMITTAL	04/30/2020	4	4TH SUBMITTAL		09/15/2020
2	2ND SUBMITTAL	07/16/2020				
3	3RD SUBMITTAL	08/06/2020				
						NUMBER
PF	RIVATE IMPR	OVEME	EN	Γ PLANS	2001	7-CIVIL
	24 3RC) STR	EE	T		G PERMIT: -00173
	CIVIL	PLA	NS		\mathbf{C}	1
	GRADING & E	RAINA	GE	E PLAN	\mathbf{U}	
	1 2 3 PI	1 1ST SUBMITTAL 2 2ND SUBMITTAL 3 3RD SUBMITTAL PRIVATE IMPR 24 3RC CIVIL	No.DESCRIPTIONDATE11ST SUBMITTAL04/30/202022ND SUBMITTAL07/16/202033RD SUBMITTAL08/06/2020PRIVATE IMPROVEME24 3RD STR CIVIL PLA	No.DESCRIPTIONDATENo.11ST SUBMITTAL04/30/2020422ND SUBMITTAL07/16/2020433RD SUBMITTAL08/06/202008/06/2020PRIVATE IMPROVEMENT24 3RD STREECIVIL PLANS	11ST SUBMITTAL04/30/202044TH SUBMITTAL22ND SUBMITTAL07/16/202007/16/202007/16/202033RD SUBMITTAL08/06/202008/06/202007/16/2020	No. DESCRIPTION DATE No. DESCRIPTION 1 1ST SUBMITTAL 04/30/2020 4 4TH SUBMITTAL 2 2ND SUBMITTAL 07/16/2020 4 4TH SUBMITTAL 3 3RD SUBMITTAL 07/16/2020 5 5 FILE 3 3RD SUBMITTAL 08/06/2020 5 FILE PRIVATE IMPROVEMENT PLANS 24 3RD STREET CIVIL PLANS BUILDIN BUILDING & DRAINAGE C

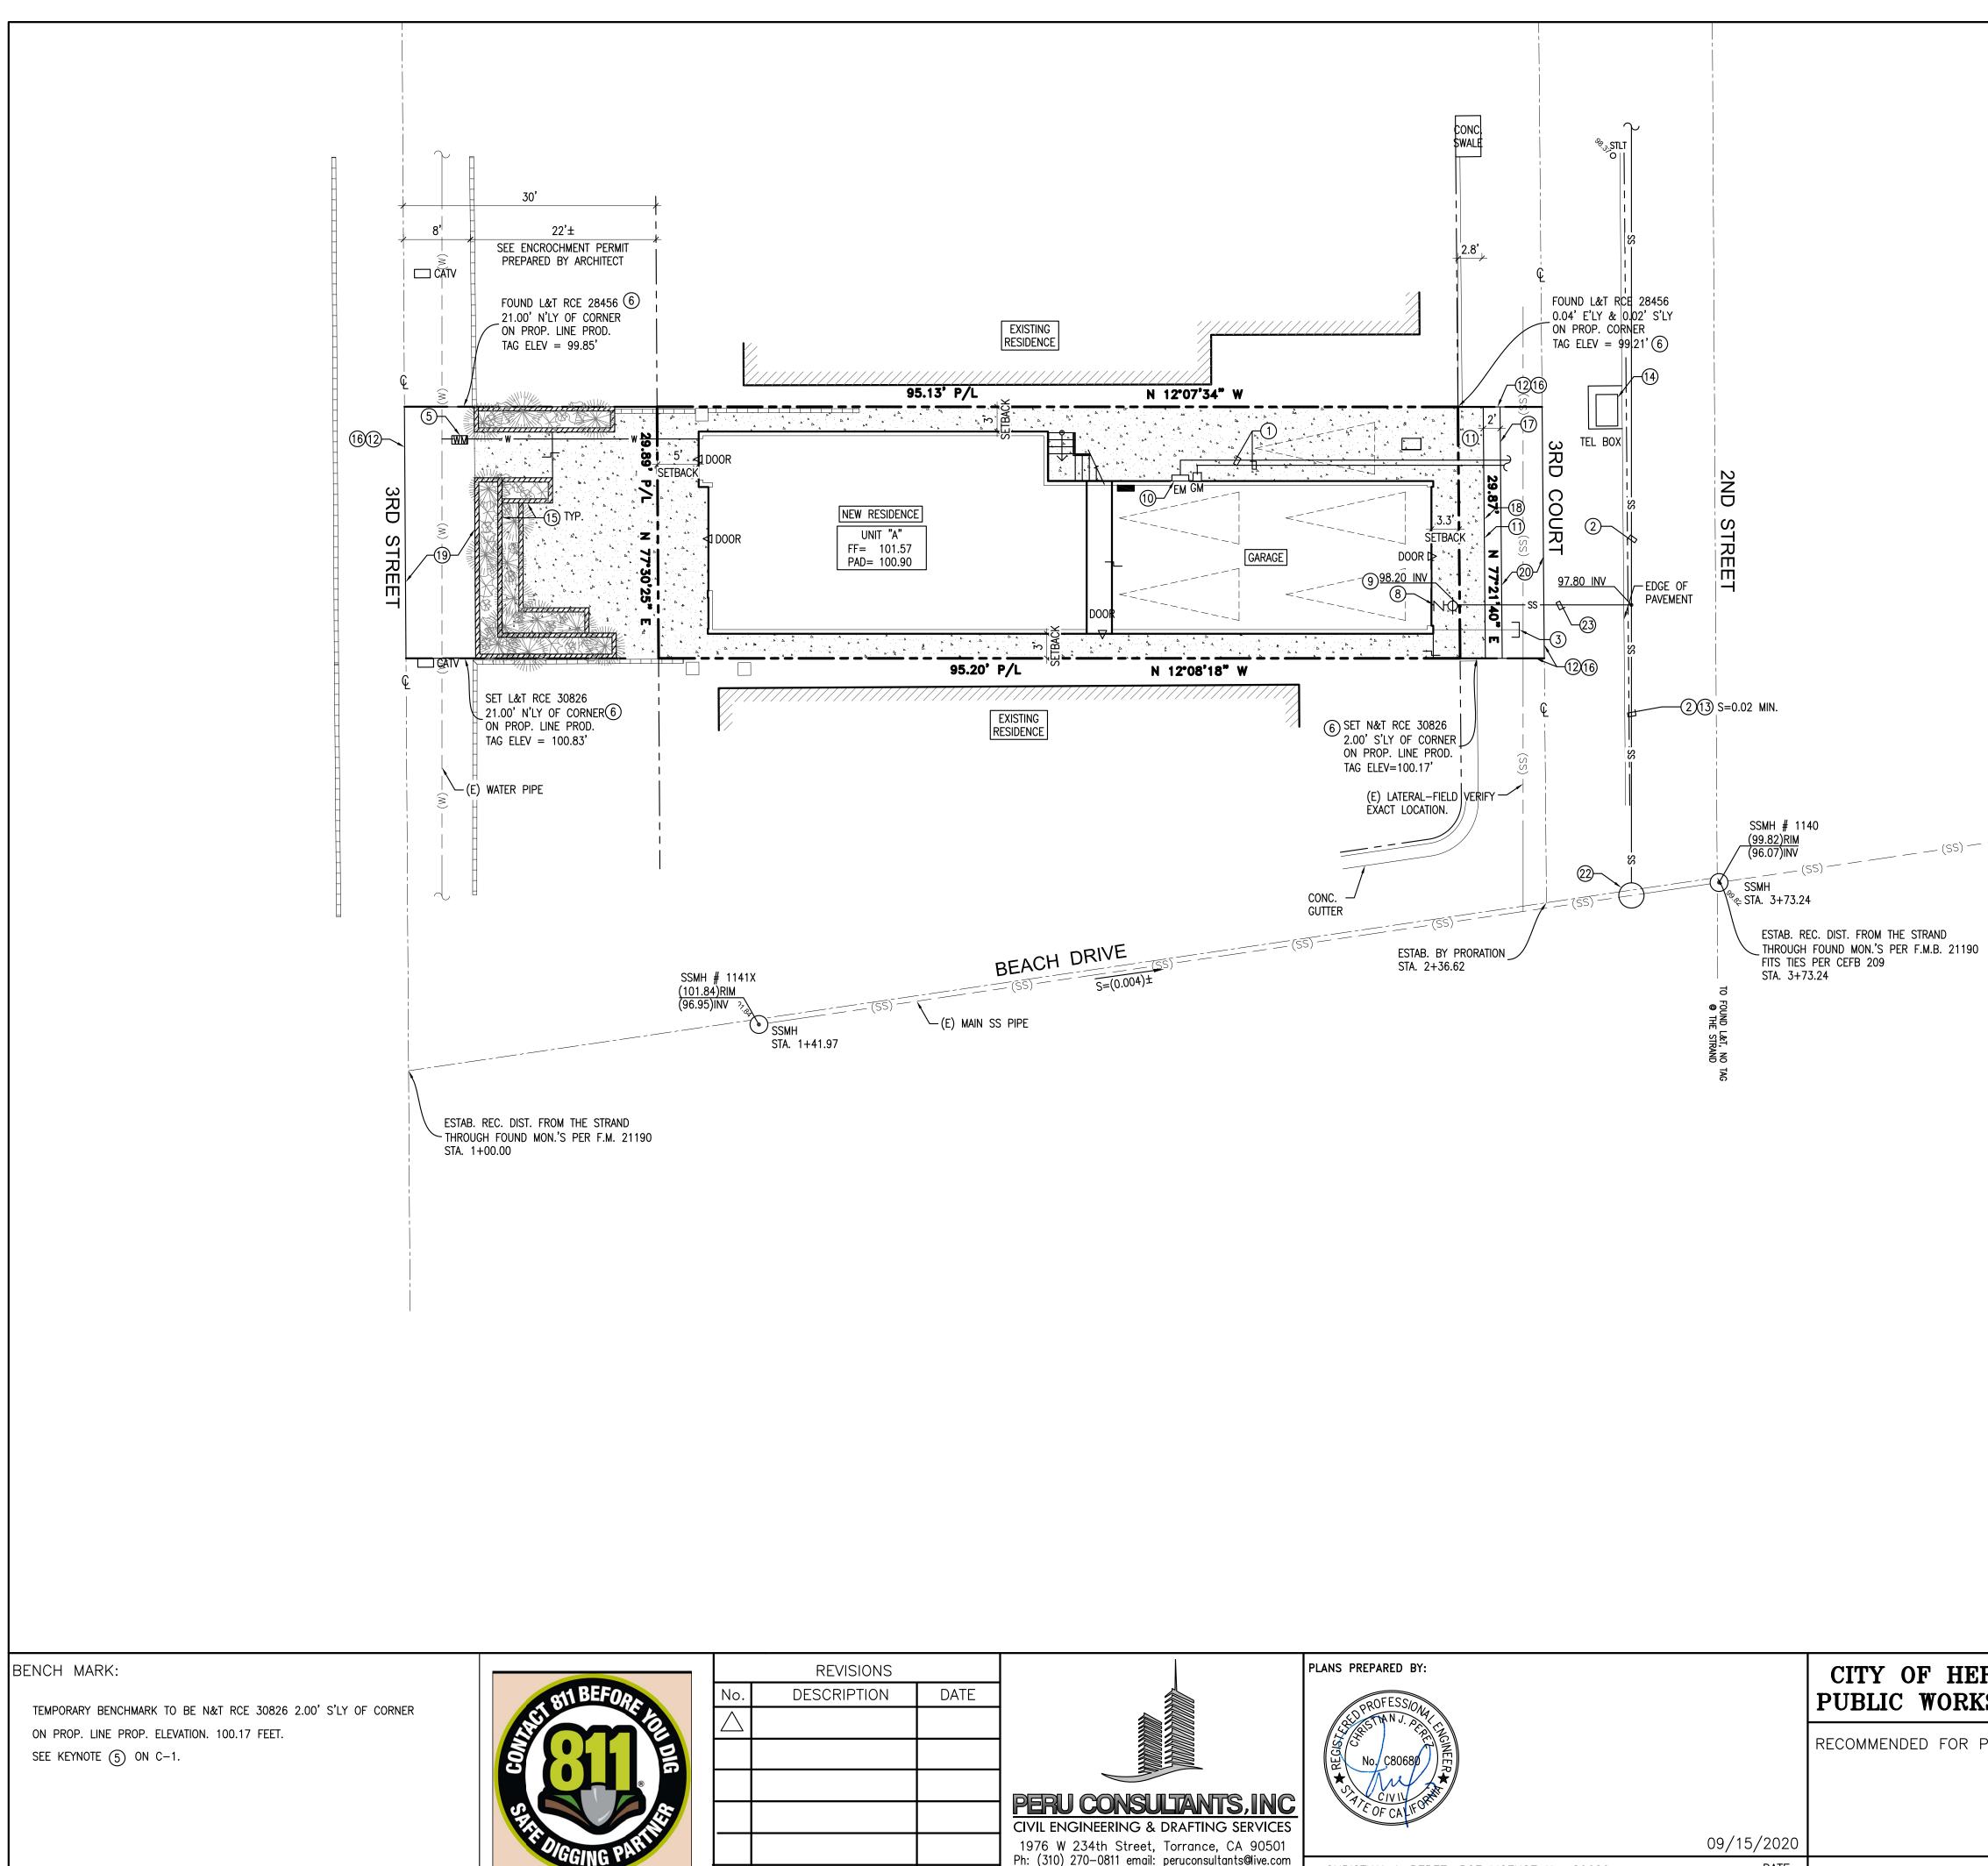

DATE		PLANS PREPARED BY:	CITY OF HE PUBLIC WORK
			RECOMMENDED FOR F
	PERU CONSULTANTS, INC CIVIL ENGINEERING & DRAFTING SERVICES 1976 W 234th Street, Torrance, CA 90501	09/15/2020	
	Ph: (310) 270—0811 email: peruconsultants@live.com	CHRISTIAN J. PEREZ, RCE LICENSE No. 80680 DATE	

CONSTRUCTION NOTES

- (1) ALL OVERHEAD UTILITIES IN 3RD COURT & 3RD STREET SHALL BE UNDERGROUNDED. OBTAIN PLAN FROM SCE FOR UG. APPLY FOR PERMIT FROM THE CITY. ABANDONED UTILITY WIRES SHALL BE CLEANED UP. CONTACT UTILITY COMPANY.
- (2) CONTRACTOR TO BUILD NEW 8" DIA. PVC SDR-35 SEWER MAIN PER CITY'S DESIGN PREPARED BY PSOMAS.
- (3) EXISTING SEWER LATERAL SHALL BE CAPPED AT LATERAL CONNECTION IN 3RD COURT IF PROPERTIES ARE STILL BEING SERVED BY THE LATERAL AT THE TIME OF CONSTRUCTION. IF ALL PROPERTIES SERVED BY THE LATERAL HAVE BEEN CONNECTED TO NEW MAIN, CAP EXISTING LATERAL AT MAIN. OBTAIN A PERMIT FROM PUBLIC WORKS FOR THE SEWER CAP. CONTRACTOR TO FIELD VERIFY EXACT LOCATION.
- (4) NO TRASH AREA IS PERMITTED WITHIN THE PUBLIC RIGHT OF WAY. (5) NO METER BOXES ARE PERMITTED WITHIN 2 FT OF DRIVEWAY APPROACH. COORDINATE
- WITH CAL WATER TO RELOCATE, IF REQUIRED. (6) PROTECT SURVEY MONUMENT PER NOTE #10 OF THE GENERAL CONSTRUCTION NOTES HEREON IF REQUIRED.
- (7) TRENCH SEPARATION REQUIREMENTS SHALL BE IN ACCORDANCE WITH CALIFORNIA DEPARTMENTS OF HEALTH SERVICES, "CRITERIA FOR THE SEPARATION OF WATER MAINS AND NON-POTABLE PIPELINES." TRENCHING SHALL BE PER CITY OF HERMOSA BEACH STANDARD PLAN No. 117.
- (8) BACKFLOW PREVENTION VALVE.
- (9) 6" CLEANOUT.
- (10) ELECTRIC METER LOCATION.
- (11) CONSTRUCT 2' WIDE GUTTER PER CITY STD REFERENCE PLAN NO.102, FROM P/L TO P/L OR THE NEXT CONSTRUCTION JOINT WHICHEVER IS GREATER. ALIGN WITH EXISTING CONCRETE SWALE UP STREET (2.5' WIDE APPROX.) UTILITY LINES SHALL BE PERMANENTLY IDENTIFIED ON CURB FACE. FONT 2" HEIGHT and ¼" depth.
- (12) SAWCUT (E) PAVING.
- (13) INSTALL UNDERGROUND UTILITIES. CONTRACTOR TO FIELD VERIFY EXACT LOCATION AND DEPTH OF EXISTING MAIN UTILITY LINES (CONTACT DIG ALERT). COORDINATE WITH THE UTILITY COMPANY & PUBLIC WORKS PRIOR TO INSTALLATION. REPAIR PAVING TO MATCH EXISTING, PER CITY STANDARD PLAN No 117. IF INSTALLATION IS IN A MORATORIUM STREET, PUBLIC WORKS WILL DETERMINE THE EXTENT OF THE AREA TO BE REPAVED. SEE GENERAL CONSTRUCTION NOTES ON C-O.
- (14) PROTECT IN PLACE EXISTING UTILITY.
- 15 planter wall for wall height and details, see encroachment permit PREPARED BY ARCHITECT.
- (16) JOIN TO MATCH EXISTING GRADE.
- (17) 24" WIDE FULL DEPTH AC PATCHBACK.
- (18) REPAINT RED FIRE LANE, TO MATCH EXISTING.
- (19) REMOVE AND REPLACE PCC PAVEMENT PER HERMOSA BEACH STANDARD PLAN No. 115 AND CRUSHED AGGREGATE BASE PER CITY STANDAR PLAN No. 111, ½ STREET, PL TO PL OR THE NEXT CONSTRUCTION JOINT, WHICHEVER IS GREATER.
- (20) GRIND AND CONSTRUCT 2" AC OVERLAY. USE $\frac{1}{2}$ " FINE. REMOVE AND REPLACE DETERIORATED AC PAVEMENT. REPLACEMENT SHALL BE PER CITY STANDARD PLANS. ½ STREET, PL TO PL OR THE NEXT CONSTRUCTION JOINT, WHICHEVER IS GREATER.
- (21) CONTRACTOR SHALL IMPLEMENT AND MAINTAIN BMPs. THE PUBLIC R.O.W. SHALL NOT BE USED AS STORAGE AREA AND AREA SURROUNDING SITE SHALL BE CLEAR OF DEBRIS. SEE DRAWING C-5 FOR EROSION CONTROL PLAN.
- (22) CONTRACTOR TO BUILD NEW MANHOLE PER CITY'S DESIGN PREPARED BY PSOMAS.
- (23) CONSTRUCT NEW 6" VCP SEWER LATERAL PER APWA STD PLAN No 222-1. CONNECTION INTO MAIN LINE SHALL INCORPORATE THE INSTALLATION OF A NEW "WYE". SADDLES SHALL NOT BE ALLOWED. SEWER MAIN/LATERAL SHALL BE CONSTRUCTED PRIOR TO THE CONSTRUCTION OF THE FIRST FLOOR.

NOTE: FOR GRADING & DRAINAGE PLAN, SEE DRAWING


SCALE: 01 5 10 FEET 20


SUBMITTALS							
No. DESCRIPTION DATE No. DESCRIPTION						DATE	
1	1ST SUBMITTAL	04/30/2020	4	4TH SUBMITTAL		09/15/2020	
2	2ND SUBMITTAL	07/16/2020					
3	3RD SUBMITTAL	08/06/2020					
					FILE	NUMBER	

ERMOSA BEACH KS DEPARTMENT PRIVATE IMPROVEMENT PLANS BUILDING PERMIT: PERMIT ISSUANCE: 24 3RD STREET B20-00173

DATE

CIVIL PLANS PUBLIC IMPROVEMENTS

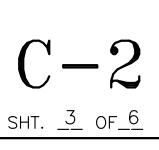

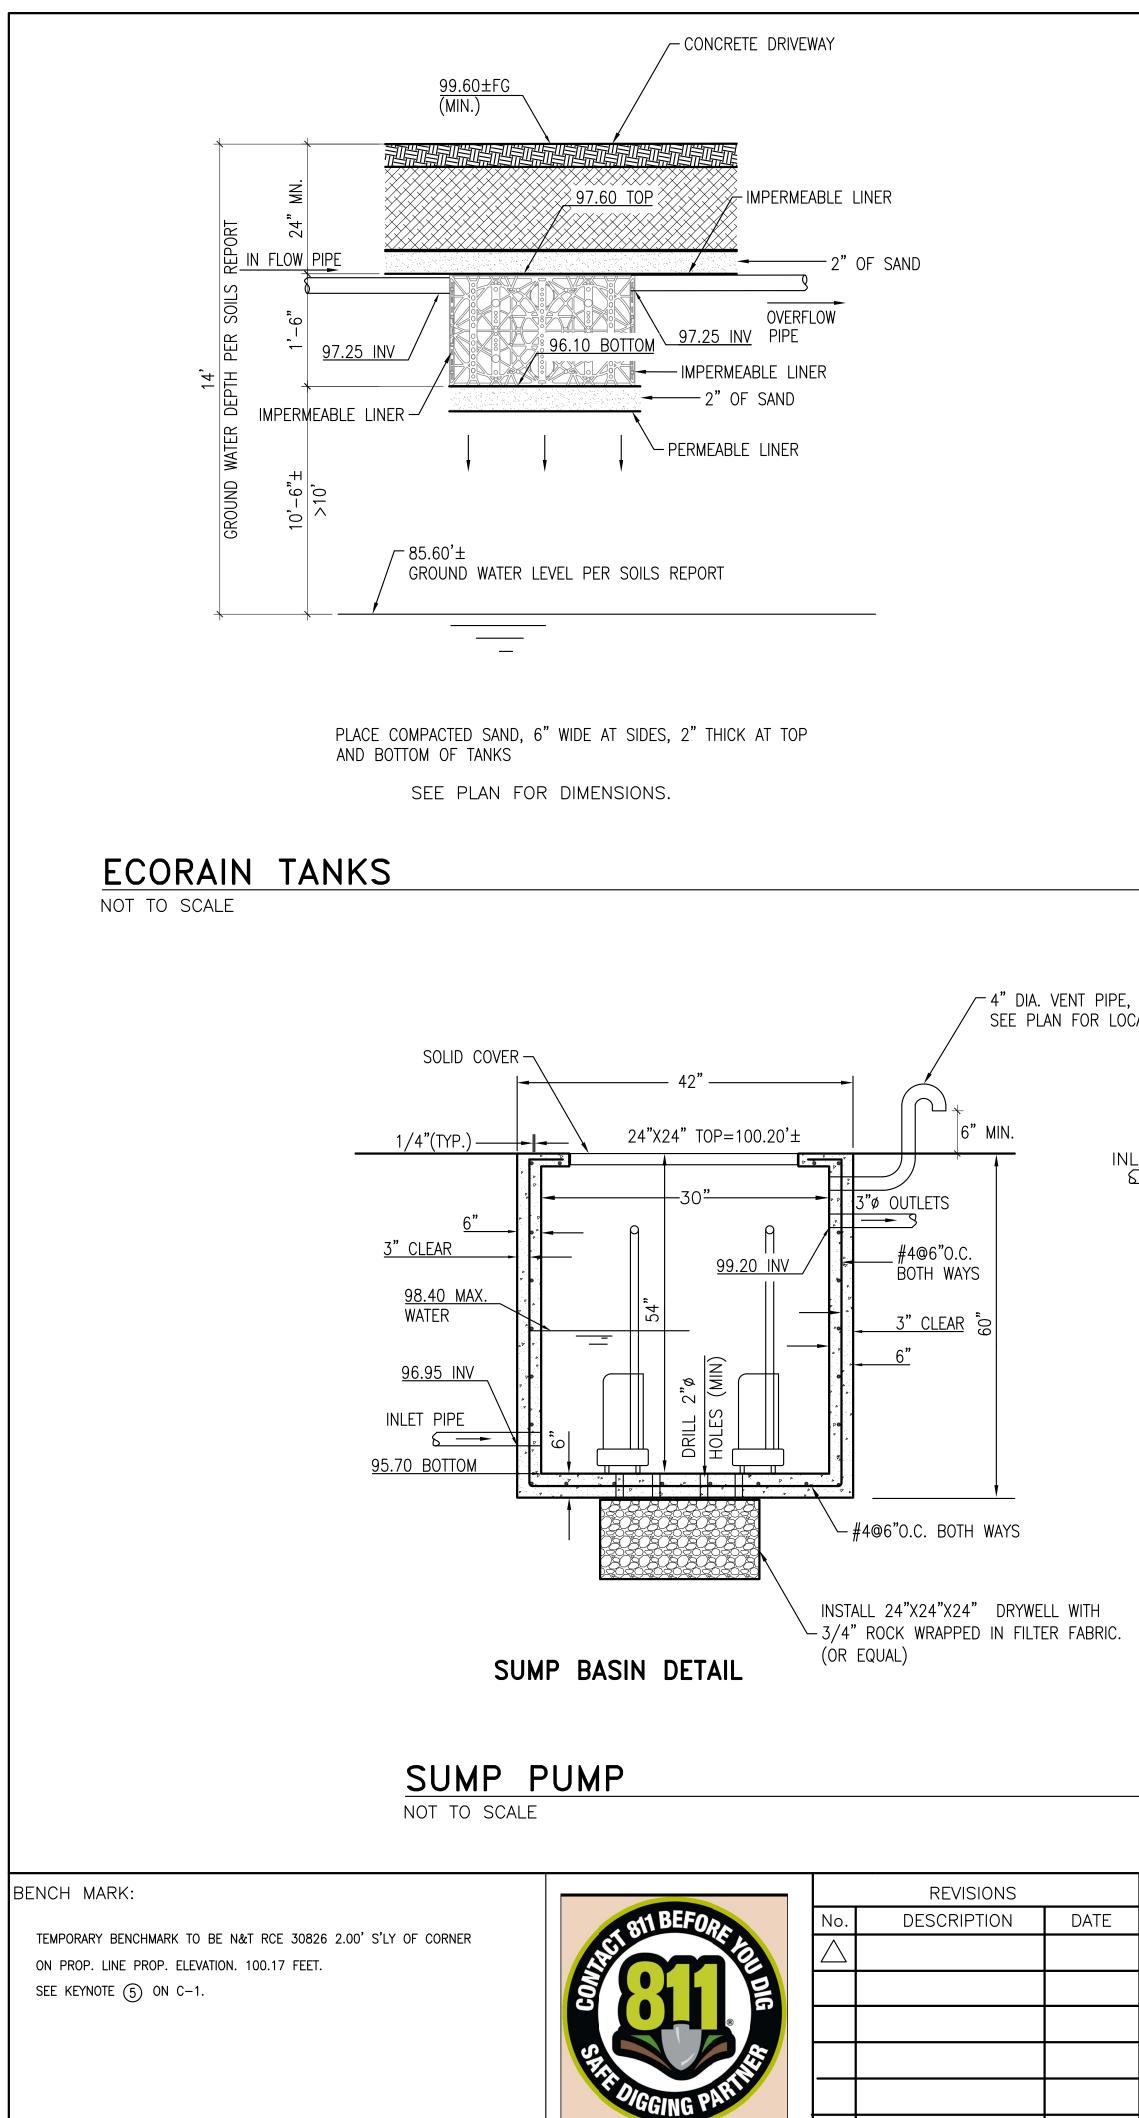


INSTALLATION REQUIREMENTS:

- 1. EXCAVATE TRENCH LARGER THAN SPECIFIED TANK SIZE.
- 2. COMPACT BASE TO 35 PSI.
- 3. ADD SAND TO BASE, COMPACT AND LEVEL WITH A STRAIGHT EDGE.
- 4. LAY GEOTEXTILE MATERIAL IN BOTTOM AND ON SIDES OF TRENCH, ENOUGH TO FULLY WRAP TANK, WITH 12" SEAM OVERLAPS.
- 5. INSTALL TANKS UPRIGHT FOR MAXIMUM STRENGTH.
- 6. COVER ECORAIN TANKS WITH GEOTEXTILE MATERIAL-WRAP TIGHT, CUT AWAY EXCESS FOLDS, OVERLAP AND/OR SEAL JOINTS WITH TAPE.
- 7. BACKFILL SIDES WITH SANDY FILL IN MAXIMUM 12" LAYER-COMPACTING EACH LAYER AT LEAST 95%.
- 8. INFILTRATION OCCURS AT THE BOTTOM OF THE PIT ONLY. THE WALLS SHALL BE WRAPPED WITH IMPERMEABLE FABRIC. SEE SECTION VIEW.

NOTE:

CONTACT STORMWATER SOLUTIONS REGARDING INSTALLATION.


SEE PLAN FOR LOCATION.

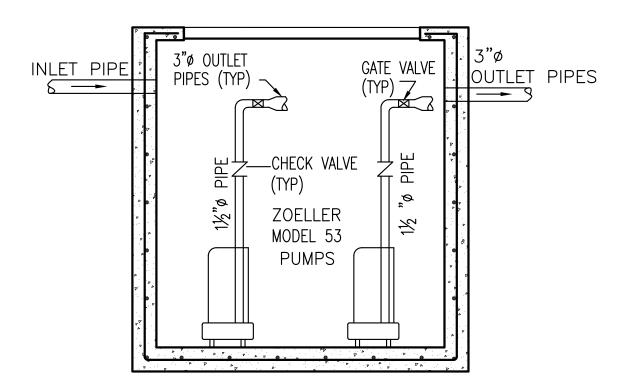

NOTE:


AN ALARM SYSTEM & MECHANICAL OR ELECTRICAL ALTERNATORS SHALL BE CONSIDERED FOR THE PUMP SYSTEM.


PUMP INSTALL DETAIL

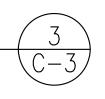

DATE		PLANS PREPARED BY:		CITY OF HEI PUBLIC WORK
	PERU CONSULTANTS, INC	No. C80680		RECOMMENDED FOR F
	CIVIL ENGINEERING & DRAFTING SERVICES 1976 W 234th Street, Torrance, CA 90501		09/15/2020	
	Ph: (310) 270—0811 email: peruconsultants@live.com	CHRISTIAN J. PEREZ, RCE LICENSE No. 80680	DATE	



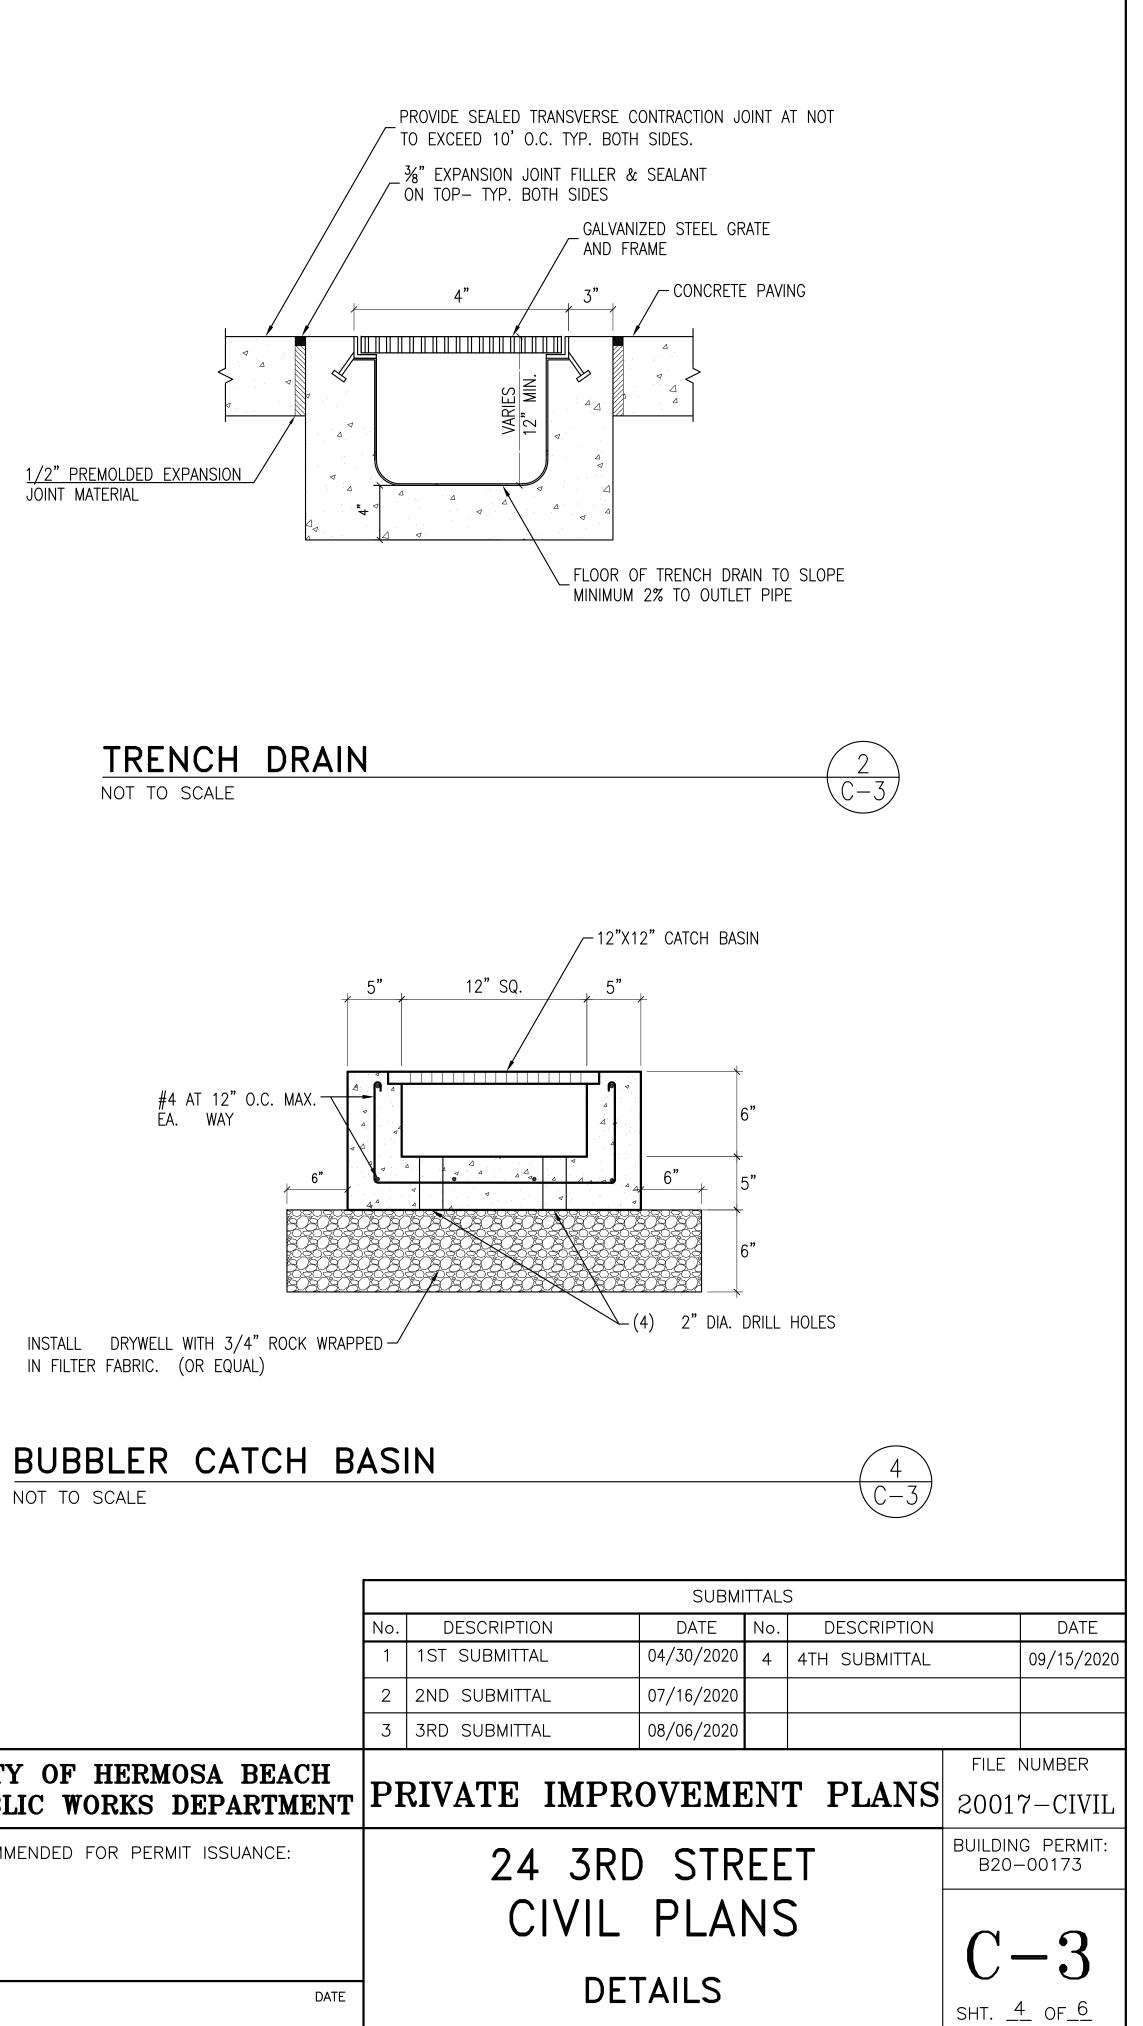

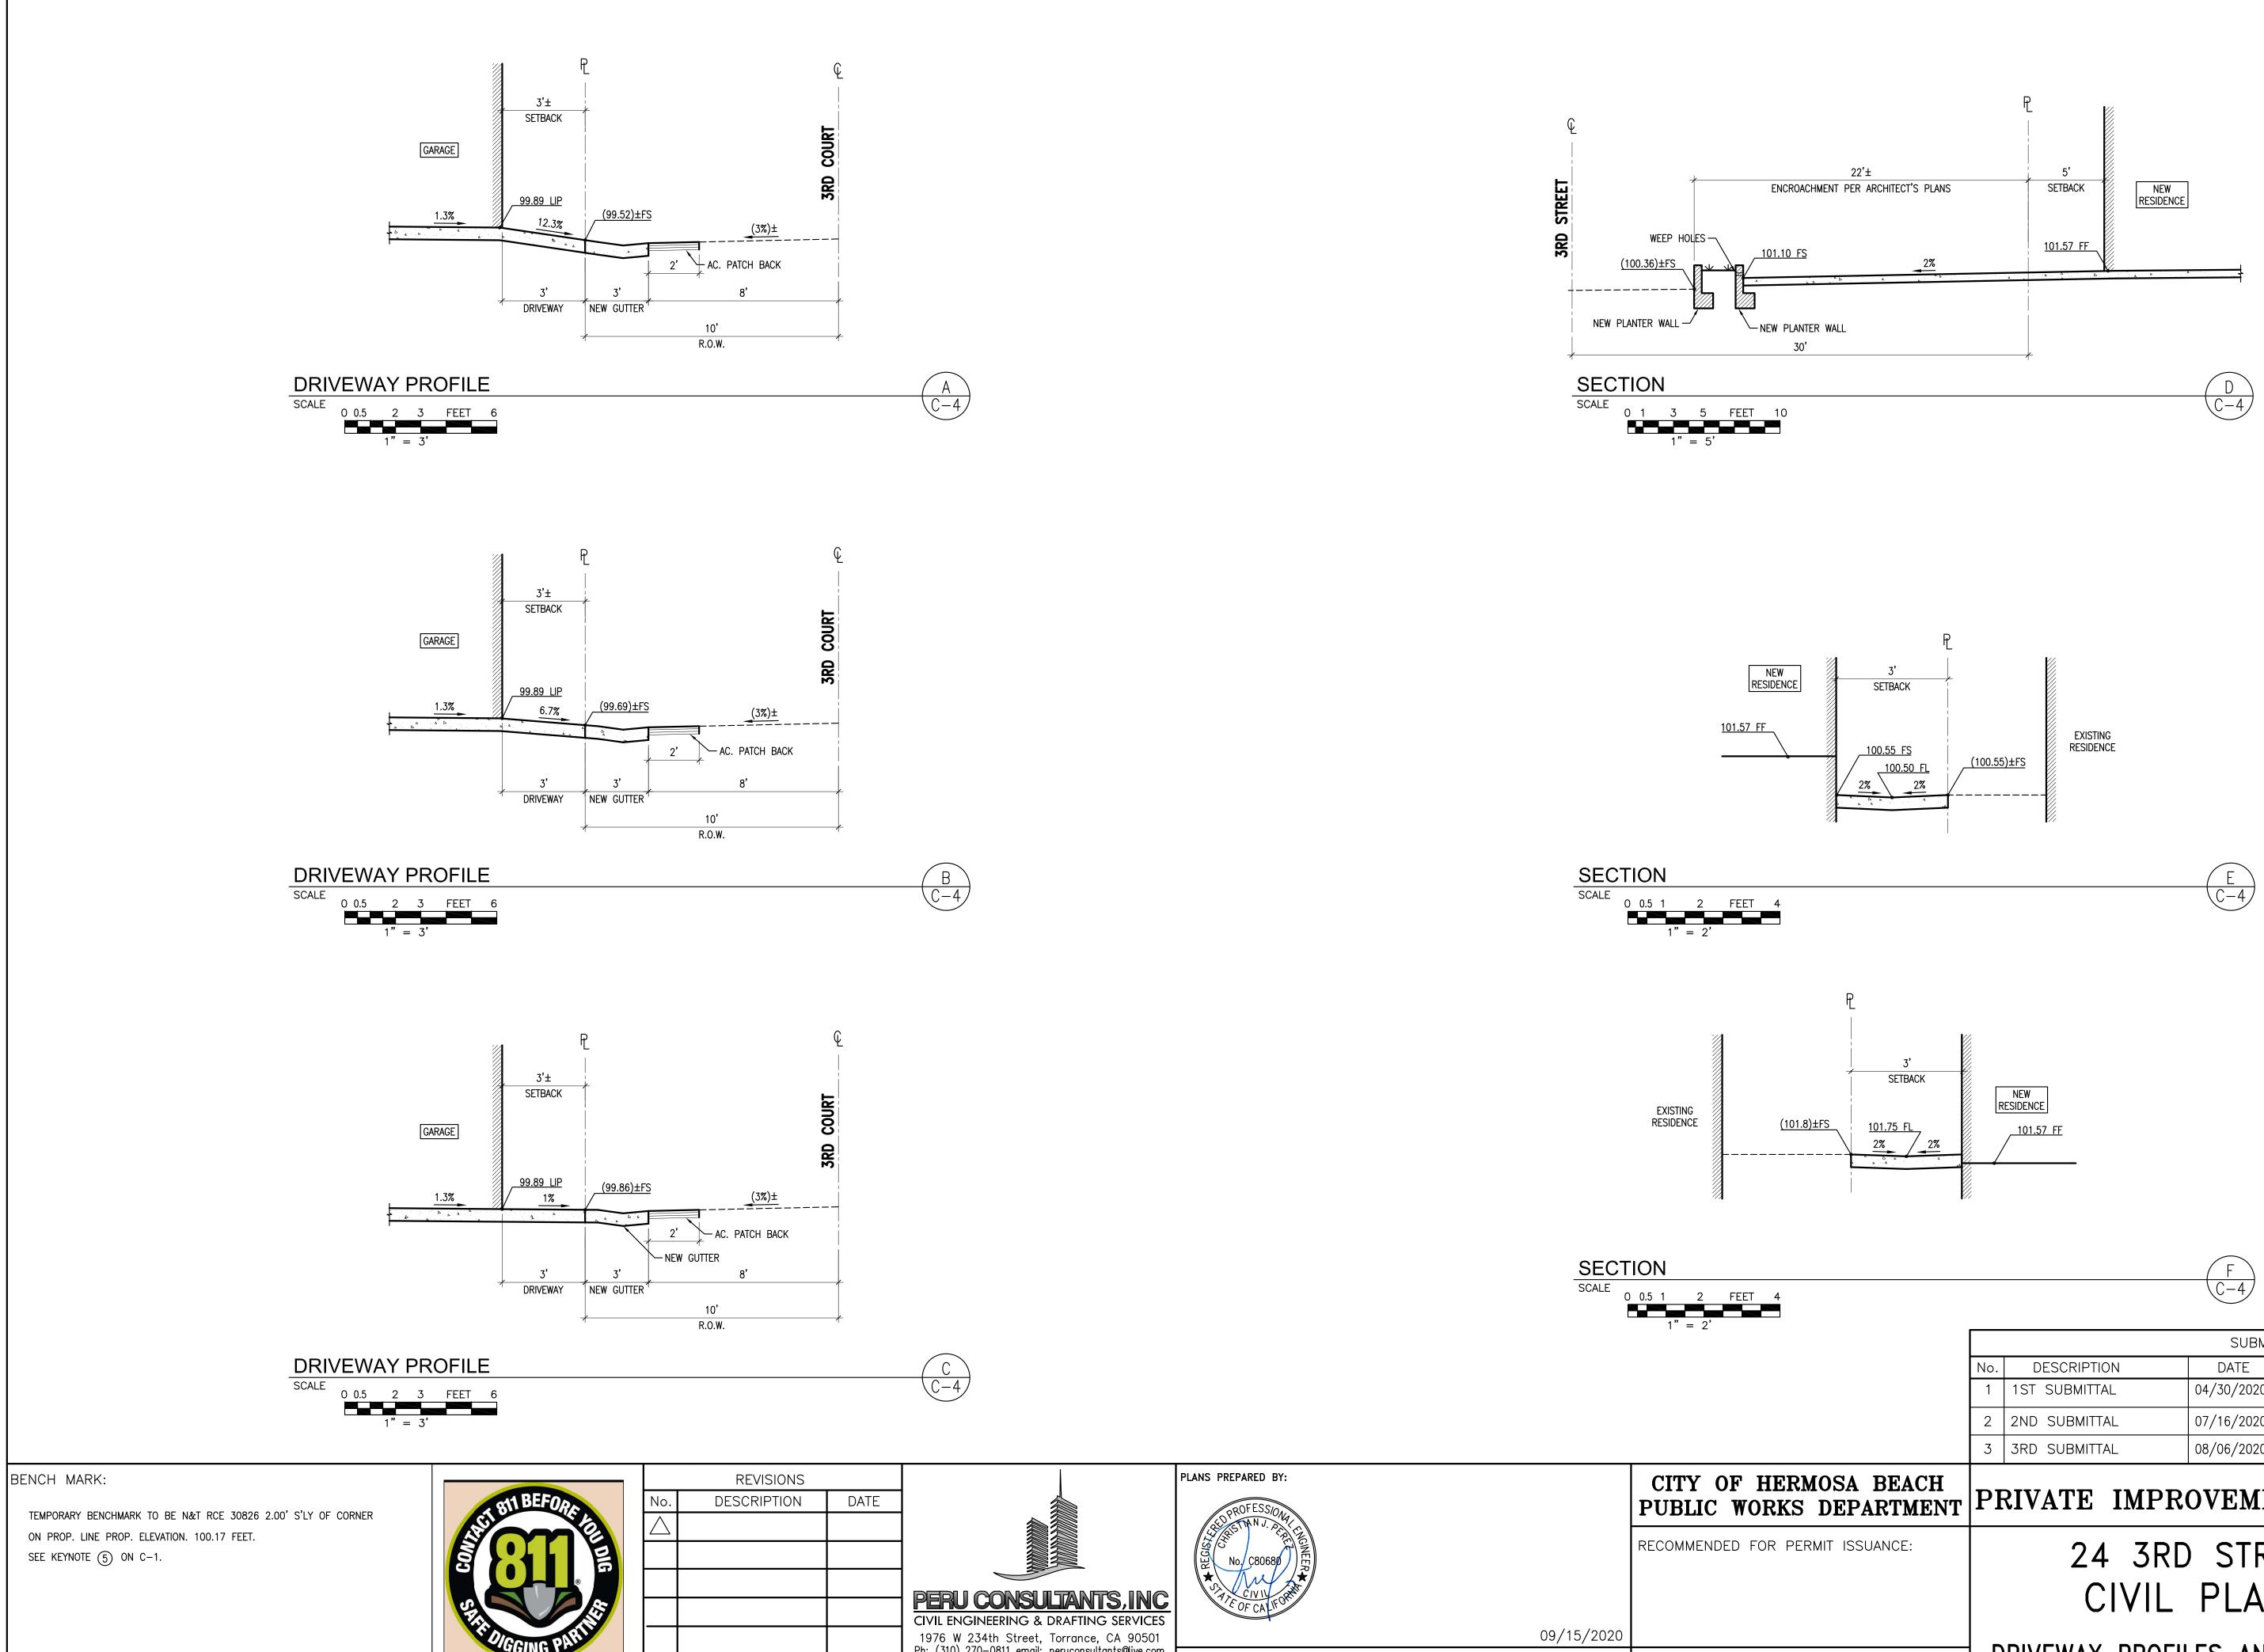


1976 W 234th Street, Torrance, CA 90501 Ph: (310) 270-0811 email: peruconsultants@live.com

CHRISTIAN J. PEREZ, RCE LICENSE No. 80680

DATE

4	F C-4						
			SUBMI	TTALS	6		
	No.	DESCRIPTION	DATE	No.	DESCRIPTION		DATE
	1	1ST SUBMITTAL	04/30/2020	4	4TH SUBMITTAL		09/15/2020
	2	2ND SUBMITTAL	07/16/2020				
	3	3RD SUBMITTAL	08/06/2020				
ERMOSA BEACH							NUMBER
KS DEPARTMENT	PI	RIVATE IMPRO	OVEME	EN	Г PLANS	2001	7-CIVIL
R PERMIT ISSUANCE:	24 3RD STREET		T		G PERMIT: -00173		
		CIVIL PLANS				C-	_ 1
DATE	D	DRIVEWAY PROFILES AND SECTIONS					<u>5</u> OF <u>6</u>

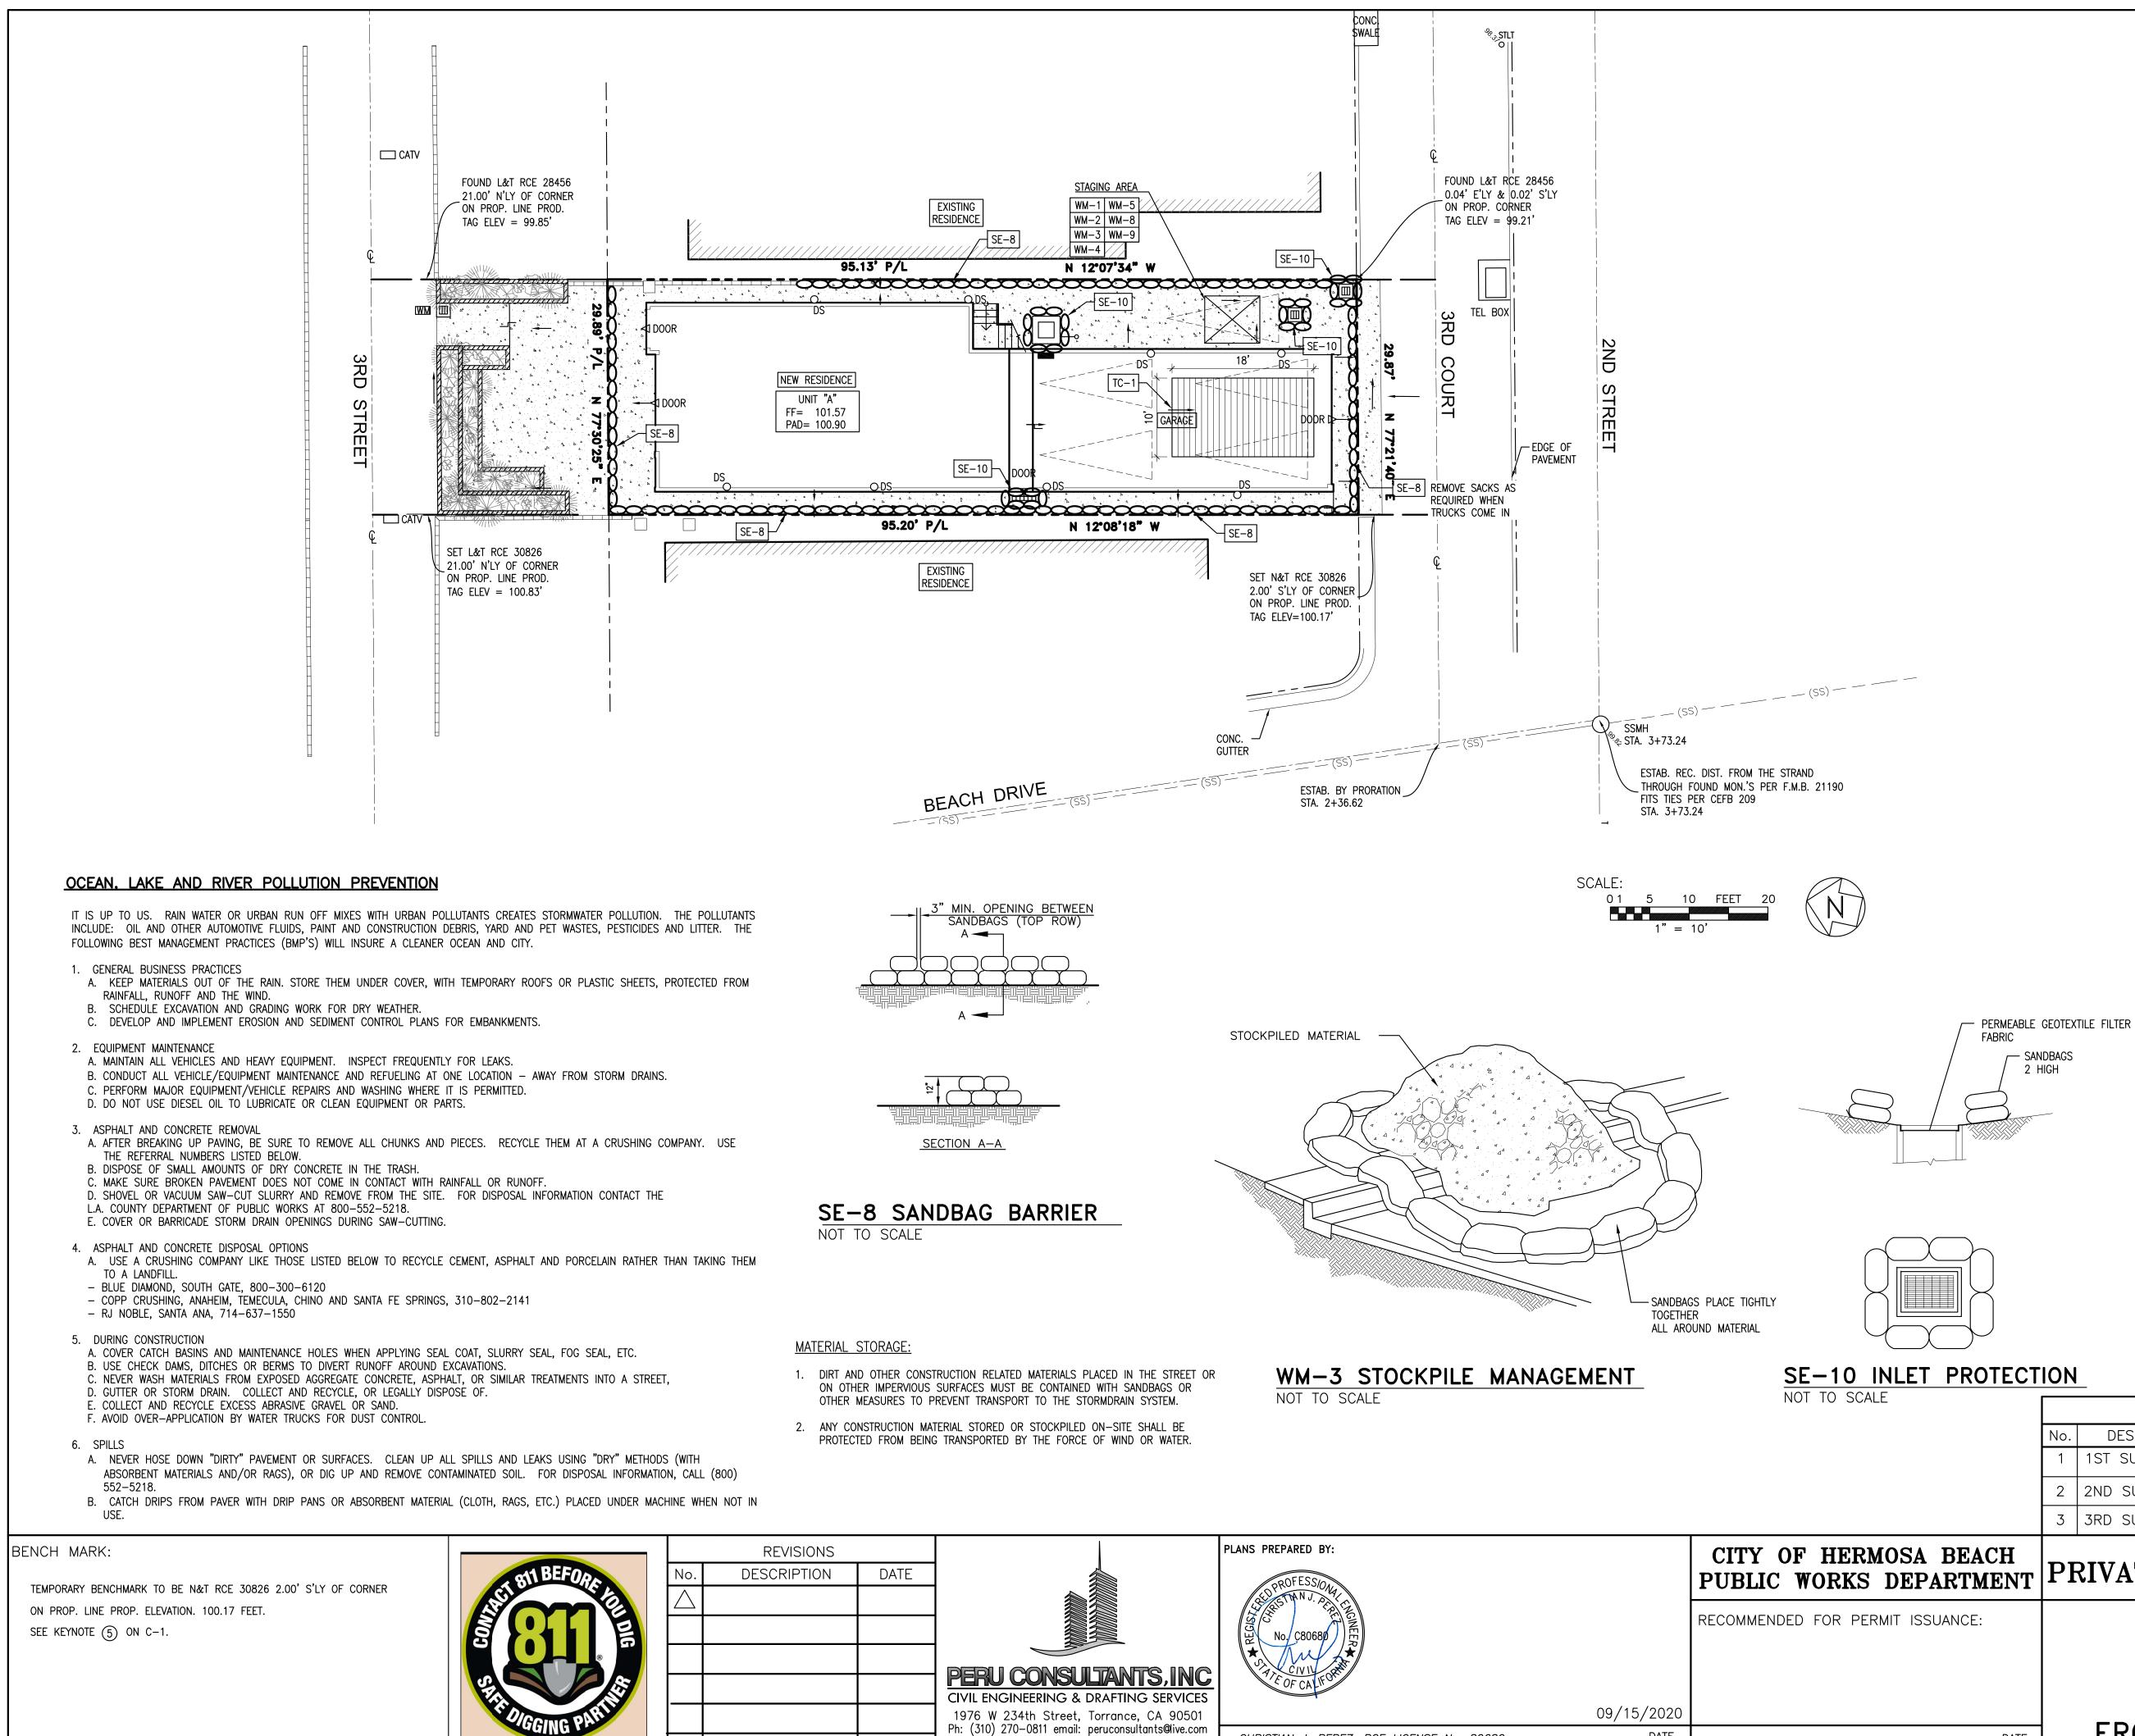

DATE		PLANS PREPARED BY:		CITY OF HE PUBLIC WORK
				RECOMMENDED FOR F
	PERU CONSULTANTS, INC CIVIL ENGINEERING & DRAFTING SERVICES 1976 W 234th Street, Torrance, CA 90501 Ph: (310) 270–0811 email: peruconsultants@live.com	FEOFCALFOR	09/15/2020	
	Ph: (310) 270—0811 email: peruconsultants@live.com	CHRISTIAN J. PEREZ, RCE LICENSE No. 80680	DATE	

BMP SELECTION AND LEGEND:

BMP'S SPECIFIED ON THIS PLAN REFERENCE THE NOVEMBER 2009 EDITION OF CASQA "CALIFORNIA STORMWATER HANDBOOK". IT IS THE RESPONSIBILITY OF THE CONTRACTOR TO OBTAIN BMP DETAILS AVAILABLE AT WWW.CAQA.ORG.

THE FOLLOWING BMP'S ARE NOT SHOWN IN SPECIFIC LOCATIONS ON THIS PLAN AND ARE APPLICABLE TO THE PROJECT. THE CONTRACTOR SHALL INCORPORATE THESE BMP'S INTO THE PROJECT SCOPE:

EC-1	PROJECT SCHEDULE
EC-2	PRESERVATION OF EXISTING VEGETATION
NS-1	WATER CONSERVATION
NS-3	PAVING AND GRINDING
NS-6	DISCHARGE REPORTING
NS-7	POTABLE WATER/IRRIGATION
NS-8	VEHICLE CLEANING
NS-9	VEHICLE FUELING
NS-10	VEHICLE MAINTENANCE
WE-1	WIND EROSION CONTROL

THE FOLLOWING BMP'S ARE SPECIFIED ON THIS PLAN:

SE-1	SILT FENCE
SE-8	SANDBAG BARRIER

SE-10	INLET	PROTECTION	

TC-1 STABILIZED CONSTRUCTION ENTRANCE/EXIT

THE FOLLOWING BMP'S SHALL BE USED IN THE CONTRACTOR STAGING AREA:

WM-1	MATERIAL	STORAGE
------	----------	---------

WM—2 MATERIAL USAGE	
---------------------	--

WM-3	STORAGE MANAGEMENT	
------	--------------------	--

- WM-4 SPILL PREVENTION KIT
- SOLID WASTE (TRASH) WM-5
- WM-8 CONCRETE WASTE (WASHOUT)
- WM-9 SEPTIC/SANITARY FACILITIES

DEWATERING NOTES:

- 1. UTILIZE APPROPRIATE DEWATERING SYSTEMS AND TECHNIQUES TO MAINTAIN THE EXCAVATED AREA SUFFICIENTLY DRY FROM GROUNDWATER AND/OR SURFACE RUNOFF SO AS NOT TO ADVERSELY AFFECT CONSTRUCTION PROCEDURES OR CAUSE EXCESSIVE DISTURBANCE OF UNDERLYING NATURAL GROUND.
- PROVIDE AND STORE AUXILIARY DEWATERING EQUIPMENT ON THE SITE IN THE EVENT OF BREAKDOWN. PROVIDE NON-WOVEN FILTER FABRIC WHERE REQUIRED FOR UNDERDRAIN SYSTEMS. THE NON-WOVEN FILTER FABRIC SHALL BE SPECIFICALLY DESIGNED FOR SUBSURFACE DRAINAGE APPLICATIONS.
- 3. WATER FROM THE TRENCHES AND EXCAVATIONS SHALL BE DISPOSED OF IN SUCH A MANNER AS TO AVOID PUBLIC NUISANCE, INJURY TO PUBLIC HEALTH OR THE ENVIRONMENT, DAMAGE OR PUBLIC OR PRIVATE PROPERTY, OR DAMAGE TO PUBLIC OR PRIVATE PROPERTY, OR DAMAGE TO THE WORK COMPLETED OR IN PROGRESS. DO NOT DISCHARGE WATER INTO ANY SANITARY SEWER SYSTEM. SILTATION BARRIERS SHALL BE UTILIZED AS NECESSARY.
- 4. WATER FROM TRENCHES AND EXCAVATIONS SHALL NOT BE DISCHARGED DIRECTLY TO STORM DRAIN SYSTEMS. PROPER TREATMENT TO A SEDIMENTATION AREA IS TO TAKE PLACE PRIOR TO DISCHARGE TO ANY DRAINAGE SYSTEMS.
- 5. THE CONTRACTOR SHALL REPAIR ANY DAMAGE RESULTING FROM THE FAILURE OF THE DEWATERING OPERATIONS OR FROM FAILURE TO MAINTAIN ALL THE AREAS OF WORK IN SUITABLE DRY CONDITION.
- 6. PRECAUTIONS SHALL BE TAKEN TO PROTECT NEW WORK FROM FLOODING DURING STORMS OR FROM OTHER CAUSES. GRADING IN THE AREAS SURROUNDING ALL EXCAVATIONS SHALL BE PROPERLY SLOPED TO PREVENT WATER FROM RUNNING INTO THE EXCAVATED AREA OR TO ADJACENT PROPERTIES. WHERE REQUIRED, TEMPORARY DITCHES SHALL BE PROVIDED FOR DRAINAGE. UPON COMPLETION OF THE WORK AND WHEN DIRECTED, ALL AREAS SHALL BE RESTORED IN A SATISFACTORY MANNER AND AS DIRECTED.
- 7. ALL PIPELINES OR STRUCTURES NOT STABLE AGAINST UPLIFT DURING CONSTRUCTION OR PRIOR TO COMPLETION SHALL BE THOROUGHLY BRACED OR OTHERWISE PROTECTED.
- 8. DO NOT EXCAVATE UNTIL THE DEWATERING SYSTEM IS OPERATIONAL AND THE EXCAVATION MAY PROCEED WITHOUT DISTURBANCE TO THE FINAL SUBGRADE.

9. UNLESS OTHERWISE SPECIFIED, CONTINUE DEWATERING UNINTERRUPTED UNTIL THE STRUCTURES, PIPES, AND APPURTENANCES TO BE BUILT HAVE BEEN PROPERLY INSTALLED. WHERE SUBGRADE MATERIALS ARE UNABLE TO MEET THE SUBGRADE DENSITY REQUIREMENTS DUE TO IMPROPER DEWATERING TECHNIQUES, REMOVE AND REPLACE THE MATERIALS AS DIRECTED BY THE INSPECTOR.

CALE		—					
JALL							
	No.	No. DESCRIPTION DATE No. DESCRIPTION					DATE
	1 1ST SUBMITTAL 04/30/2020 4 4TH SUBM		4TH SUBMITTAL		09/15/2020		
	2 2ND SUBMITTAL 07/16/2020						
	3	3RD SUBMITTAL	08/06/2020				
RMOSA BEACH	MOSA BEACH			FILE NUMBER			
S DEPARTMENT	PI	RIVATE IMPRO	OVEME	EN'	Γ PLANS	2001'	7-CIVIL
PERMIT ISSUANCE:	ISSUANCE: 24 3RD STREET					G PERMIT: -00173	
	CIVIL PLANS					C	F
DATE EROSION CONTROL PLAN				SHT6	-5 5_ of <u>6</u>		