

JOB INFO.

4187-014-043

847 Bard Street
TRACT NO 2002 LOT 2 BLK T

R3							
DEMOLISH EXISTING 2 STORY BUILDING AND BUILD TWO UNIT							
CONDOMINUMS							
E: FOR ADDITION ANI	DREMODEL PROJECTS, PLEASE						
AND ADDED AREA.)							
UNIT #1	UNIT #2						
17' X 20'-2" & 1	7' X 20'						
297 SQ.FT.	297 SQ.FT.						
1,021 SQ.FT.	978 SQ.FT.						
NONE							
779 SQ.FT.	697 SQ.FT.						
219+192	235+141						
2,097 SQ.FT.	1,972 SQ.FT.						
411 SQ.FT.	376 SQ.FT						
3BD RMS	3BD RMS						
3.5 BATH	3.5 BATH						
REQUIRED	PROVIDED						
1.320	1.649.30						
65%	63.69%						
T							
	DEMOLISH EXISTIN CONDOMINUMS E: FOR ADDITION AN AND ADDED AREA.) UNIT #1 17' X 20'-2" & 1 297 SQ.FT. 1.021 SQ.FT. NONE 779 SQ.FT. 219+192 2.097 SQ.FT. 411 SQ.FT. 3BD RMS 3.5 BATH REQUIRED						

LOT AREA	1.320	1.649.30
LOT COVERAGE	65%	63.69%
YARDS:		
FRONT	5'	5'
SIDE	3'	3' & 4'
REAR	5'	5'
PARKING AND DRIVEWAYS:	,	
NUMBER OF SPACES	2	2
GUEST SPACES	1	1
PARKING SETBACK	N/A	N/A
PARKING STALL DIMENSION	8.5'X 20'	8.5'X 20' & 8.5'X 20.1
TURNING AREA	25'	27'
DRIVEWAY WIDTH	9'	9'
DRIVEWAY MAXIMUM SLOPE	20%	20%
OPEN SPACE:		
ON GRADE	_	0
DEOLO (DAL CONIEC		

DECKS/BALCON	IES	_		219+	-192	235+141	
TOTAL		300		UNIT	#1 411	UNIT#2 376	
BASEMENT QUA	LIFICATION CALCULATION	ON					
(REQUIRED FOR	ALL PROJECTS PROPOS	SING TWO STORI	ES AND BAS	EMENT)			
UNIT#1	UNIT #2						

	UNIT #1 UNIT #2				
	1ST LEVEL F.F. ELEVATION	97.18'	95.97		
TELEVISION	LINEAL FEET (LF) OF PERIMETER	113.25'	116.08'		
TOP OF WALL TYPICAL	LF OF PERIMETER <6' FROM GRADE TO F.F. ABOVE	37.25'	30.5'		
UNFINISHED UNLESS NOTED OTHERWISE	% OF PERIMETER < 6' to FF ABOVE	32.9%	26.27%		
VERTICAL VESTIBULE	f:b95\cd\applicat\progsumm 7/27/15				

ALL WORK SHALL COMPLY W/ 2016 CRC, 2016 CBC, 2016 CPC, 2016 CMC, 2016 CEC, 2016 CALIFORNIA

PLANNING INFO

VERTICAL VESTIBULE

WOOD

WINDOW WITHOUT

WAINSCOT

WEIGHT

WATERPROOF

WELDED WIRE MESH

6th St

WATER CLOSET

ROOF DRAIN

RIGHT HAND

ROOM

SOUTH

SILL BOLT

SECTION

SHEETING

SIMILAR SPECIFICATION

SERVICE SINK

STATION

STAGGERED

STRONG

STEEL STORAGE

STRUCTURAL

SYMETRICAL

TOP OF BEAM

TELEPHONE

TERRAZO

TOP OF FRAME

TONGUE & GROVE

TOP OF PAVMENT

TOP AND BOTTOM

TEMPORARY/TEMPRED

TREAD

SOUND TRANSMITION CLASS

STA. STAG.

STG. STL. STOR.

SOLID CORE

REFRIGERATOR UNF.

REINFORCED U.N.O. REQUIRED VERT. RESILIENT VEST.

ROUGHT OPENING WDW.

SELECT STRUCTURAL

PROJECT LOCATION:

LEGAL DESCRIPTION: ASSESSOR PARCEL NO.:

ON JANUARY 22, 2018 THE COMMUNITY DEVELOPMENT DIRECTOR FOUND A SIGNIFICANT VARIATION IN ELEVATIONS AT THE NORTHWEST AND SOUTHWEST PROPERTY CORNERS AND APPROVED THE USE OF ALTERNATIVE POINTS (94.7 AND 95.3)

	INCH TO DECIMAL CONVERSION												
	Ö	1"	2"	3"	4"	ั้	6	7"	ව"	ġ	10"	11"	
	0	.0833	.1667	.2500	.3333	.4167	.5000	.5833	.6667	.7500	.8333	.916	
1/8	.0104	.0938	.1771	.2604	.3438	.4271	.5104	.5938	.6771	.7604	.8438	.927	
1/4	.0208	.1042	.1875	.2708	.3542	.4375	.5208	.6042	.6875	.7708	.8542	.937	
3/8	.0313	.1146	.1979	.2812	.3646	.4479	.5313	.6146	.6979	.7813	.8646	.947	
1/2	.0417	.1250	.2083	.2917	.3750	.4583	.5417	.6250	.7083	.7917	.8750	.958	
5/8	.0521	.1354	.2188	.3021	.3854	.4688	.5521	.6354	.7188	.8021	.8854	.968	
3/4	.0625	.1458	.2292	.3125	.3958	.4792	.5625	.6458	.7292	.8125	.8958	.979.	
7/8	.0729	.1563	.2396	.3229	.4063	.4896	.5729	.6563	.7396	.8229	.9063	.989.	

VICINITY MAP

SYMBOLS

	BUILDING SECTION
	MALL SECTION
	INTERIOR ELEVATION
\bigcirc	DETAIL REFERENCE
	DOOR NUMBER (SEE SCHEDULE)

	FAX: (310) 376 - 6837
UMBER E)	E-MAIL: pa@pehaarch.c Web: www.pehaarch.cor

DATE: 10/3/2018
DRAWN: ATR
JOB NO. 1715
DRAWING TITLE
TITLE SHEET

DRAWING NUMBER

REVISIONS SHEAR WALL

G0.0

	CHRISTOPHER M. VASSALLO
ı	P.O.BOX 3762
	RANCHO PALOS VERDES, CA 90274
	TEL. (310) 544-8689
	SOILS ENGINEER
	NORCAL ENGINEERING
	SCOTT
	10641 HUMBOLT ST.
	LOS ALAMITOS, CA 90720
	TEL. (562) 799-9469
	CIVIL ENGINEER
l	PERU CONSULTANTS, LLP

LAND SURVEYOR

PACIFIC LAND CONSULTANTS, INC.

CHRISTIAN PEREZ CIVIL ENGINEERING 1976 W. 234TH STREET TORRANCE, CA.90501 TEL. (310) 270-0811

ELECTRICAL

LANDSCAPE

SPECIFICATIONS

L2

L3

L3.1

PLANTING PLAN

IRRIGATION PLAN

LANDSCAPE NOTES

LANDSCAPE NOTES

CONSULTANTS

DESCRIPTION

TITLE SHEET

SITE SURVEY

TITLE SHEET

DETAILS

SITE PLAN

ROOF PLAN

ARCHITECTURAL

CIVIL SITE PLAN

DRIVEWAY PROFILES

FIRST FLOOR PLAN

SECOND FLOOR PLAN

EXTERIOR ELEVATIONS

EXTERIOR ELEVATIONS

EROSION CONTROL PLAN

GARAGE/BASEMENT FLOOR PLAN

EXISTING AND PROPOSED STREET PARKING PLAN

GENERAL

CIVIL

A1.2

A2.1

A2.2

A2.4

A3.1

A3.2

STRUCTURAL



FIRE EXTINGUISHER

FINISH GRADE

FLOOR FLOUR. FLOURESENT

FOOTING

GALVANIZED

GROUND

HEADER

HARDWOOD

HIGH STRENGTH

AIR CONDITIONING

INSIDE DIAMETER

INTERIOR

INVERT(ED)

GYP. GYPSUM

HNGR. HANGER

ELECTRICAL PANEL H.V.A.C. HEATING, VENTILATION,

KIT. KITCHEN

HORIZ. HORIZONTAL

HDWD.

HDWE.

GALVANIZED IRON

FLASH. FLASHING

FIRE HOUSE CAB.

FACE OF MASONRY

ANGLE

CENTERLINE

PERPENDICULAR POUND OR NUMBER

AREA DRAIN

APPROXIMATE

BITUMINOUS

BUILDING

BLOCKING

BEAM

CABINET

CAST IRON

CEILING

CLOSET

COLUMN

CONCRETE

CONNECTION

CORRIDOR

CONTINUOUS F.B.

CATCH BASIN

CEILING JOIST

ARCHITECTURAL DN.

BOUNDRY NAILING EA.

DOUNSPOUT

ELECTRICAL

ENCLOSURE

EQUIPTMENT

EXISTING

EXPOSED

FLAT BAR

FLOOR DRAIN

EXPANSION

EMERGENCY

DRAWRE

LAMINATED

LONG LEG HORIZONTAL REQD.

LOCKER

MAXIMUM

MEMBRANE

MANHOLE

MOUNTED

N.T.S.

PLYWD.

MANUFACTURER

MASONRY OPENING

NATURAL GRADE

NOT TO SCALE

OBSCURE

ON CENTER

OPENING

OPPOSITE

PLYWOOD

PARTITION

OUTSIDE DIAMETER

PLASTIC LAMINATE

POUNDS PER SQUARE INCHTHRU.

MEDICINE CABINET

DATUM WORK POINT

MINDOM (SEE SCHEDULE)

MATCH LINE


ENERGY CODE 2016 CAL GREEN BUILDING STANDARD CODE, \$ 2016 CRC

√ LARRY PEHA

ISSUE/REVISION

10/29/18 PLANNING

SUBMITTAL 2/17/19 PLANNING COMMENT

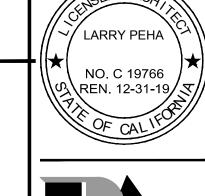





PEHA & ASSOCIATES ARCHITECTURE


Larry Peha, A.I.A

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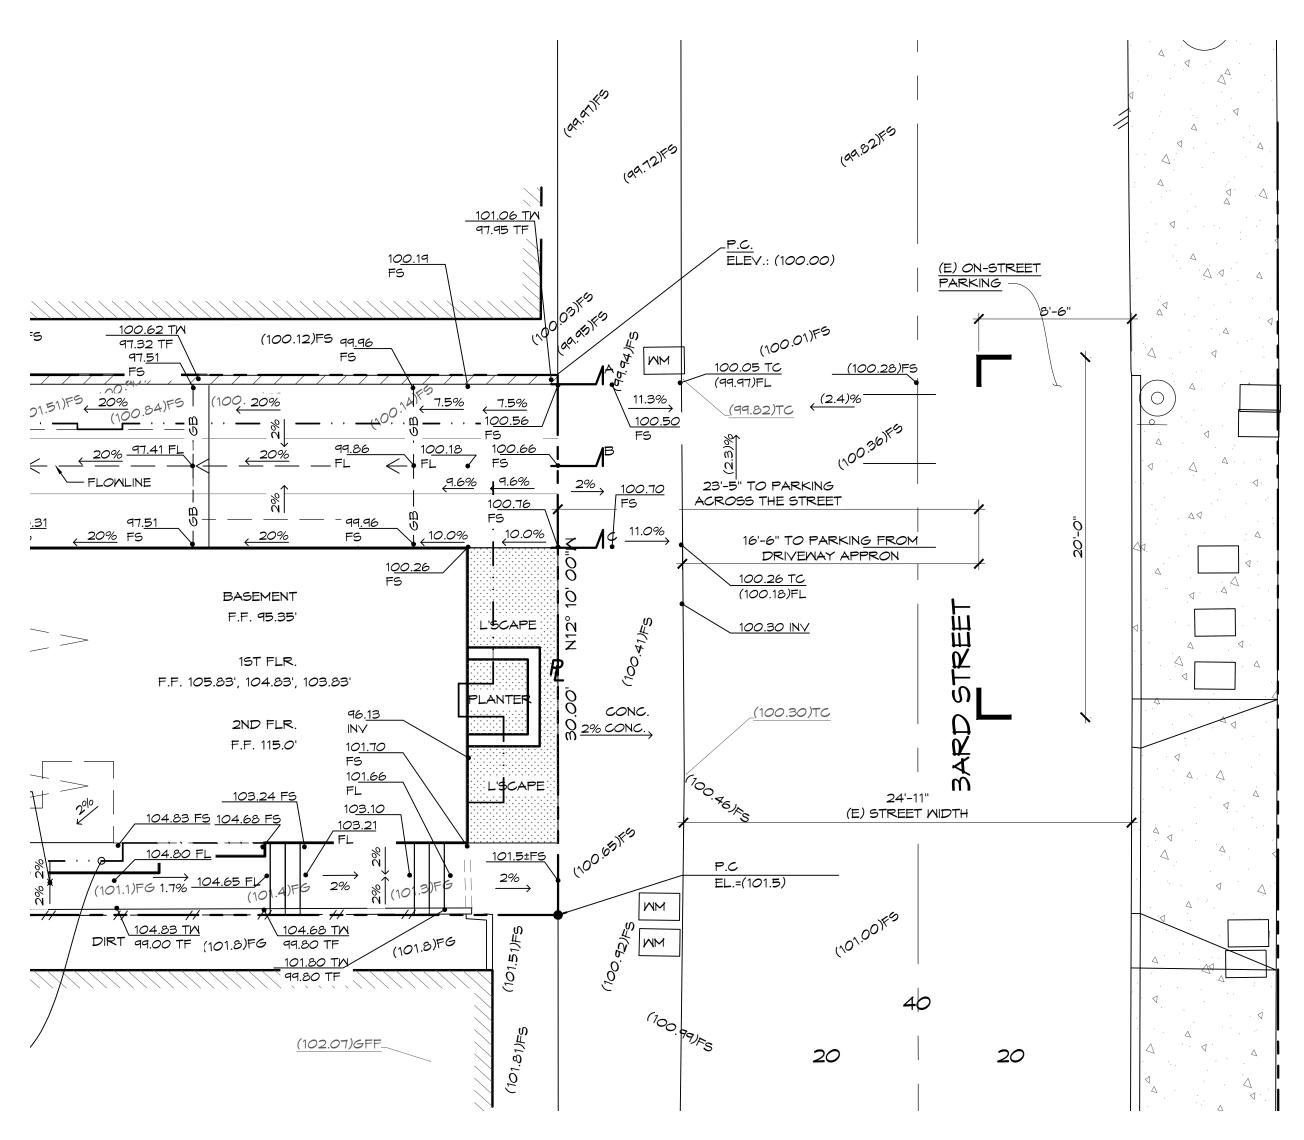


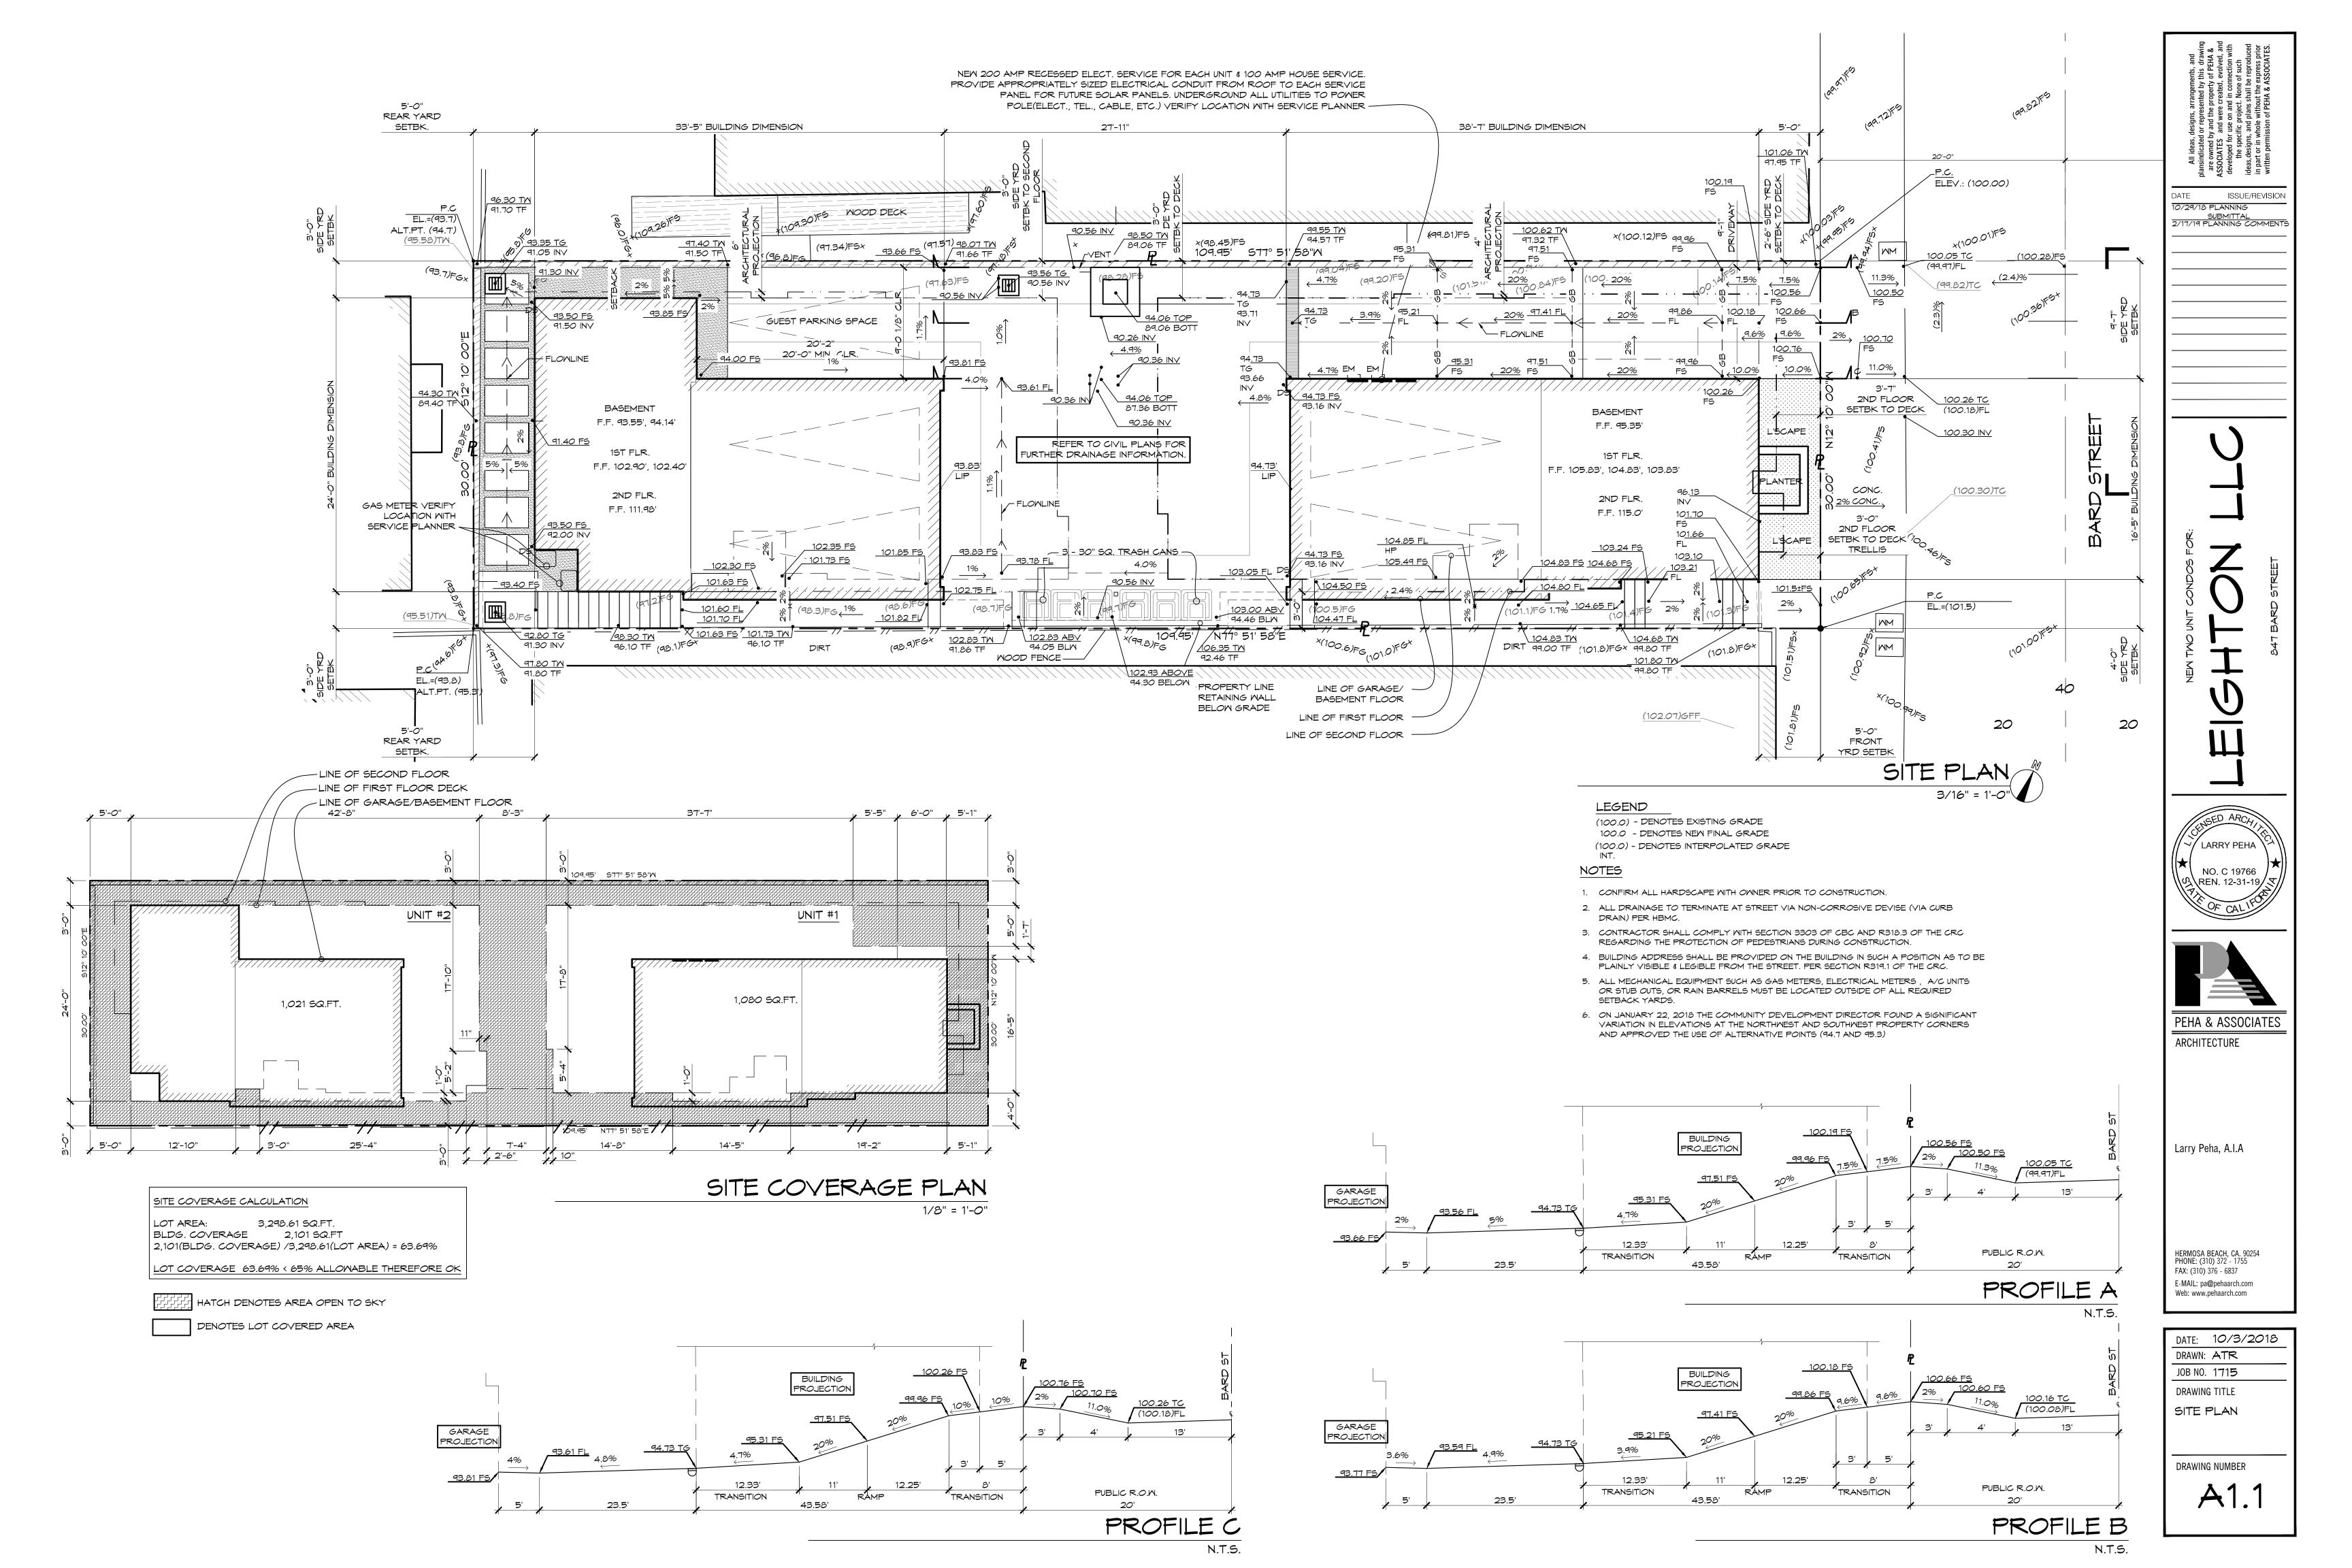

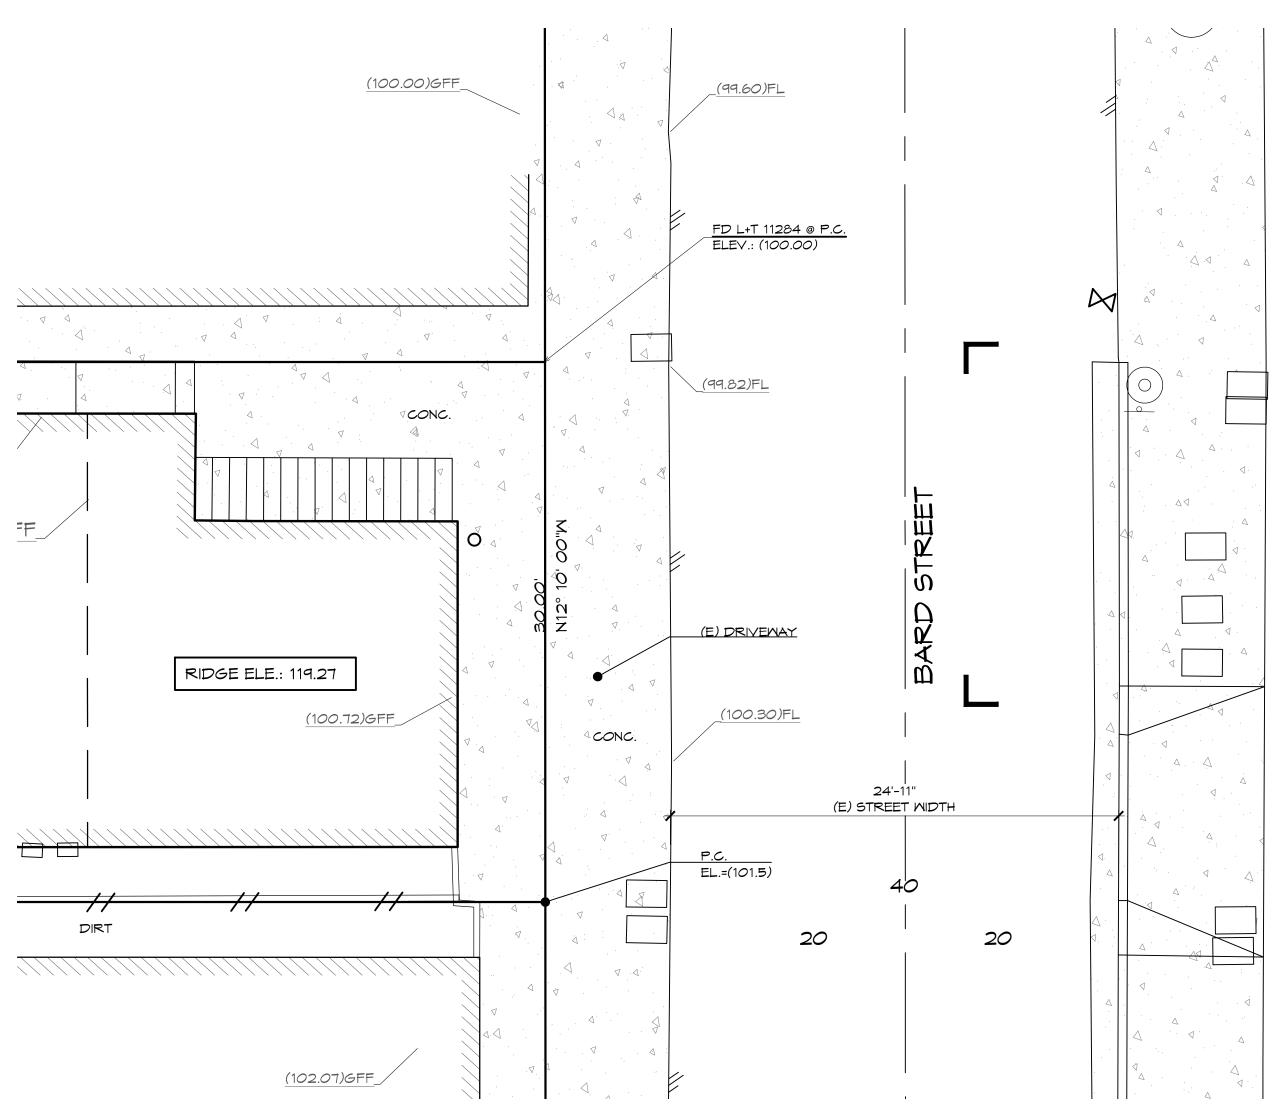

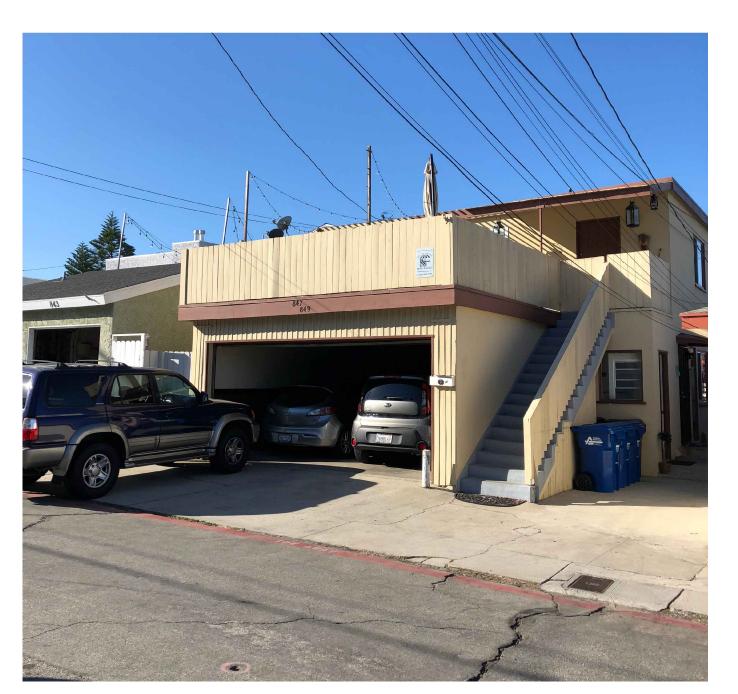

EXISTING STREET PARKING



PROPOSED ON STREET PARKING 3/16" = 1'-0"

LEGEND


(100.0) - DENOTES EXISTING GRADE 100.0 - DENOTES NEW FINAL GRADE (100.0) - DENOTES INTERPOLATED GRADE



ISSUE/REVISION

10/29/18 PLANNING SUBMITTAL
2/17/19 PLANNING COMMENTS

DATE: 10/3/2018
DRAWN: ATR
JOB NO. 1715
DRAWING TITLE
EXISTING AND
PROPOSED
STREET PARKING
DRAWING NUMBER
Δ1 つ
~ 1.2

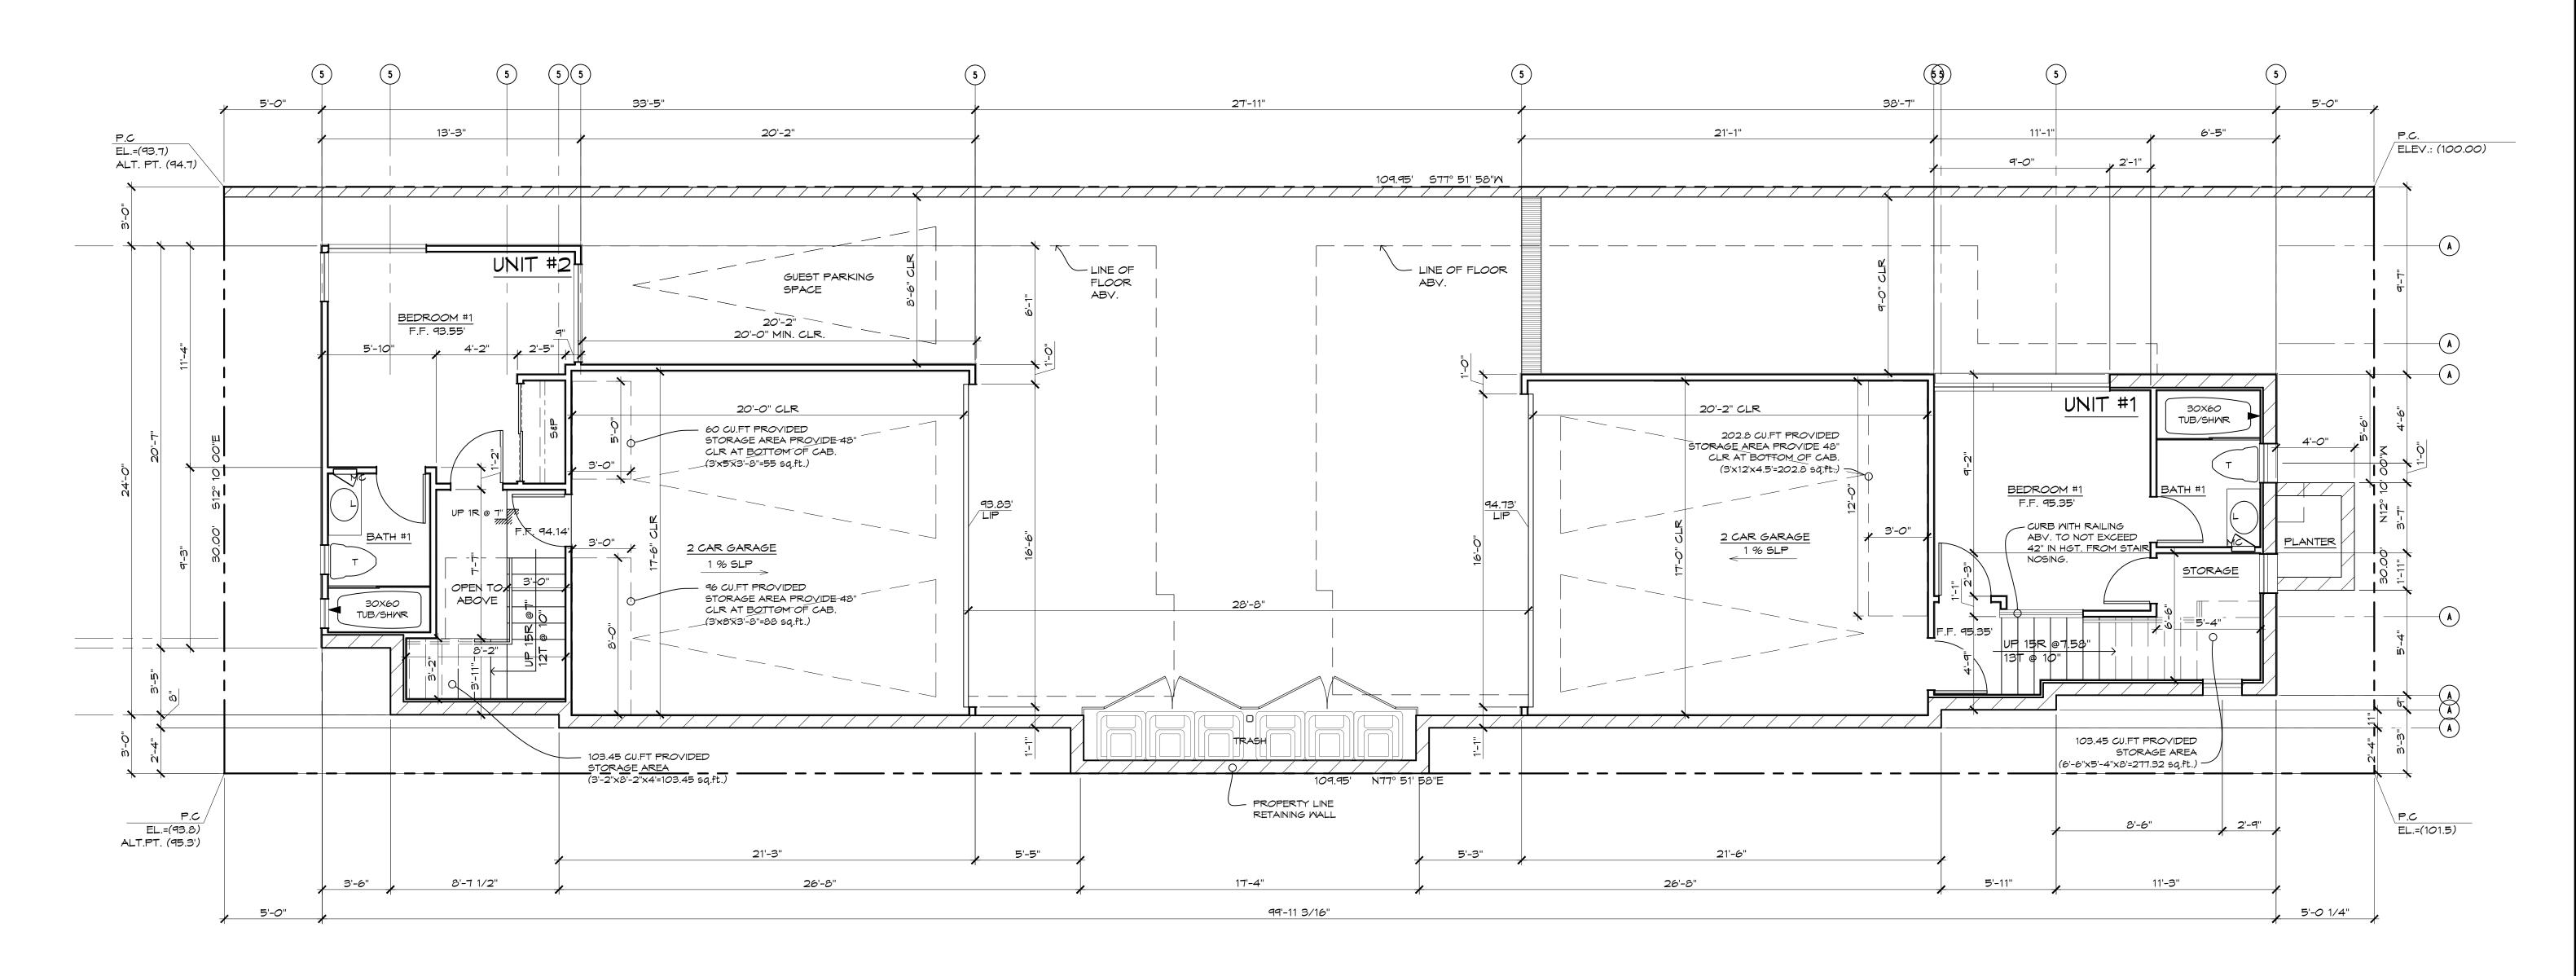

GARAGE / BASEMENT FLOOR PLAN

1/4" = 1'-0"

2 X 4 STUD WALL
8" P.I.P. CONC. WALL

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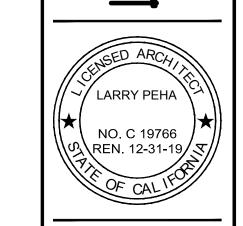
10/29/18 PLANNING

SUBMITTAL

2/17/19 PLANNING COMMENTS

NEW TWO UNIT CONDOS FOR:

TOTAL SAT BARD STREET





PEHA & ASSOCIATES

ARCHITECTURE

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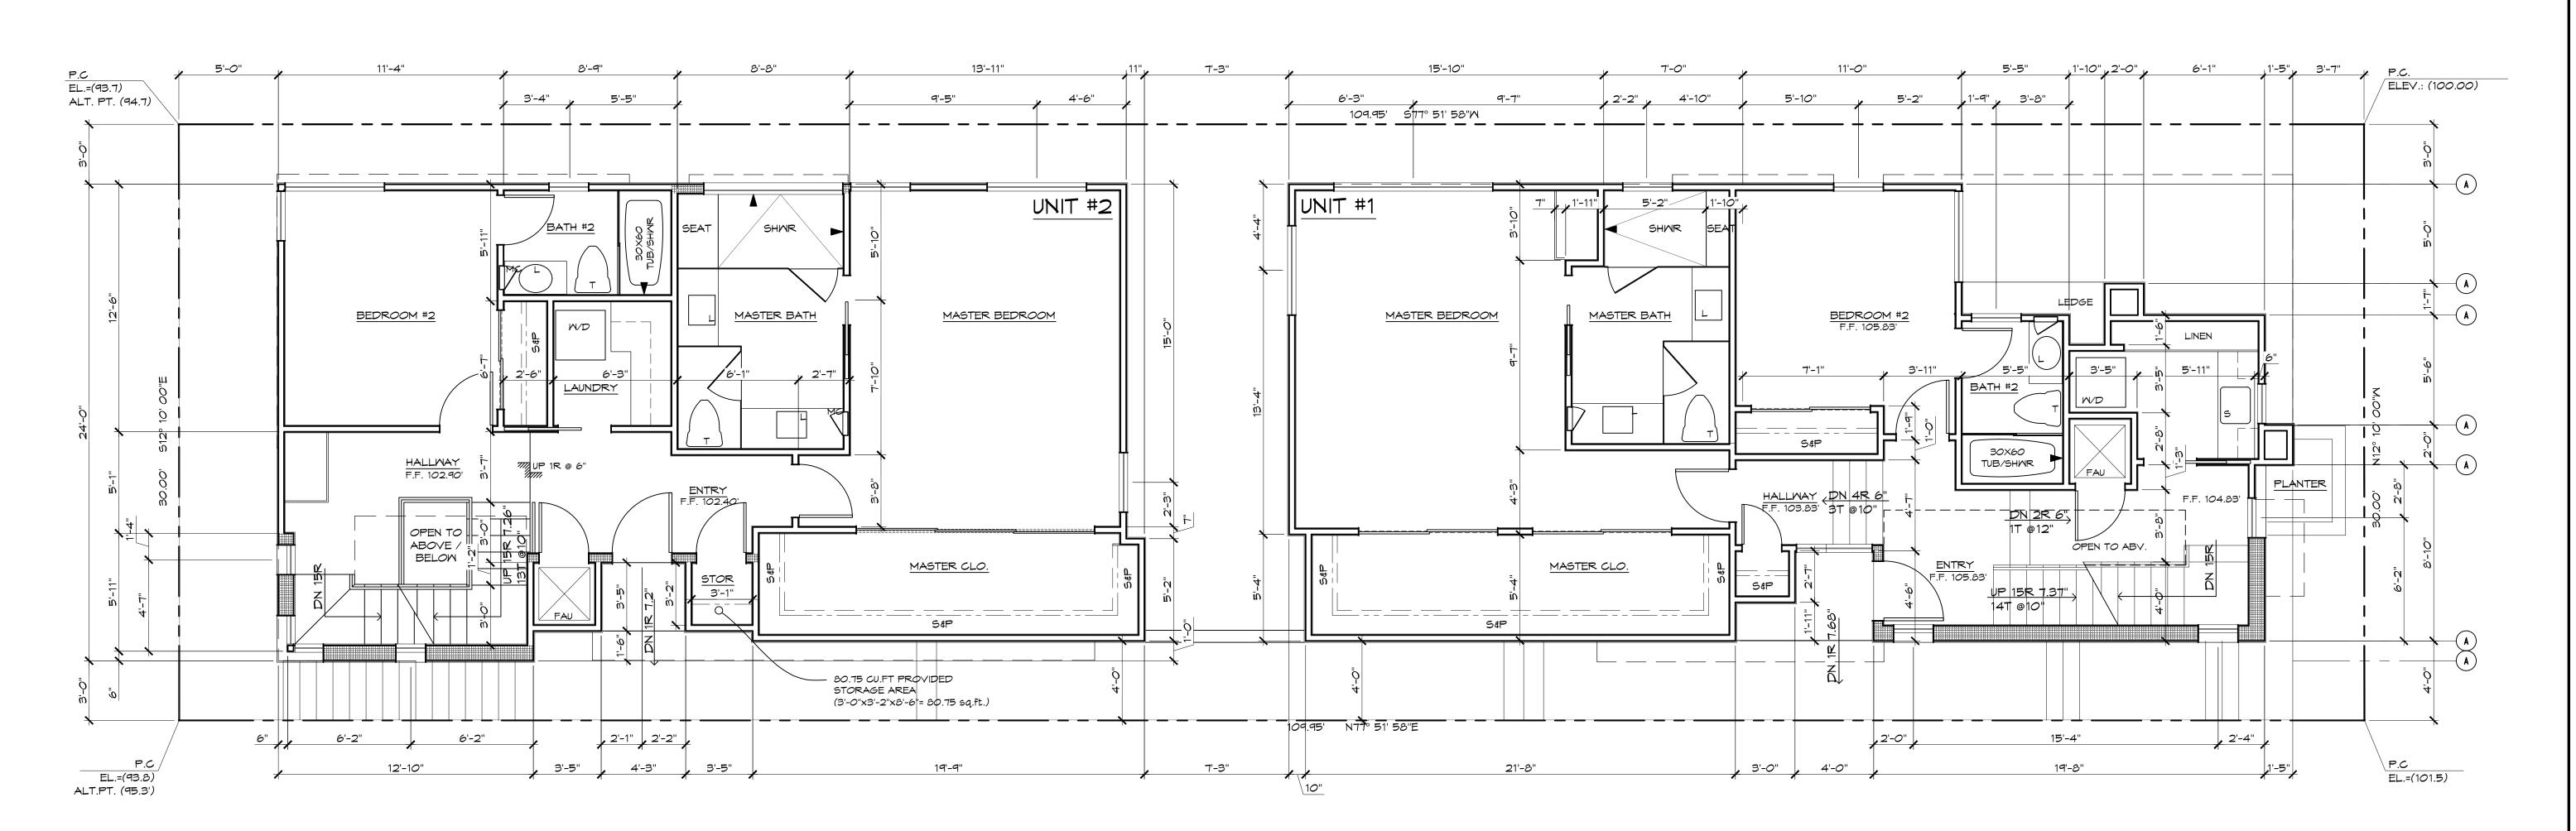
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DRAWING TITLE


GARAGE

BASEMENT PLAN

DRAWING NUMBER



	FIRST FLOOR	PLAN
	•	1/4" = 1'-0"
LEGEND	_	
2 X 4 STUD WALL		
2 X 6 STUD WALL		
2 X 10 STUD MALL		

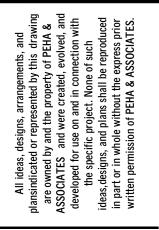


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NEW TWO UNIT CONDOS FOR:





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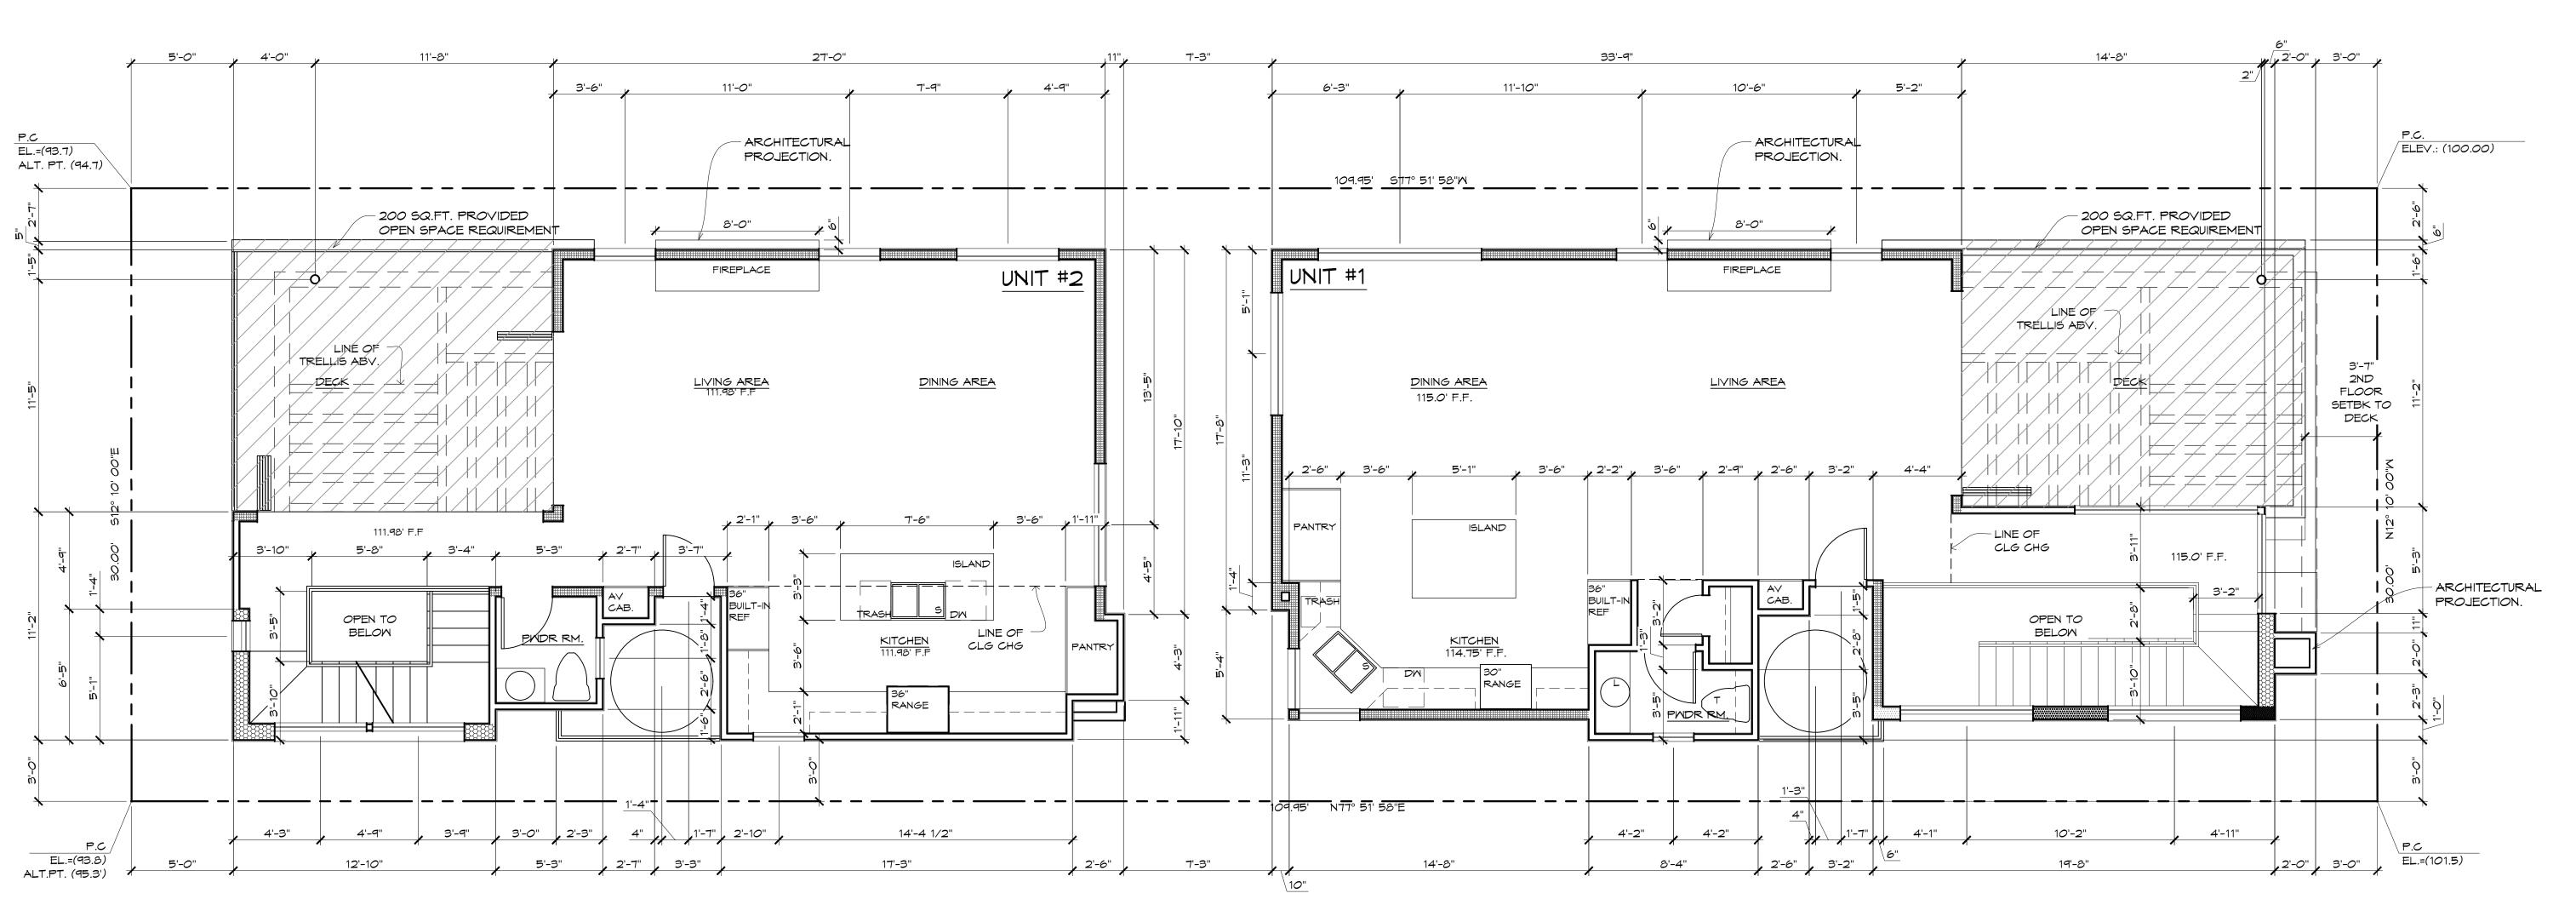
DATE: 10/3/2018

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DRAWING TITLE

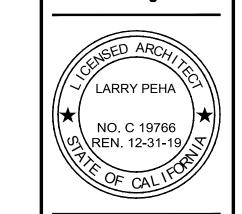FIRST FLOOR
PLAN




OPEN SPACE CALCULATION:

TOWARD OPEN SPACE.

TOTAL AREA:

COVERED AREA:

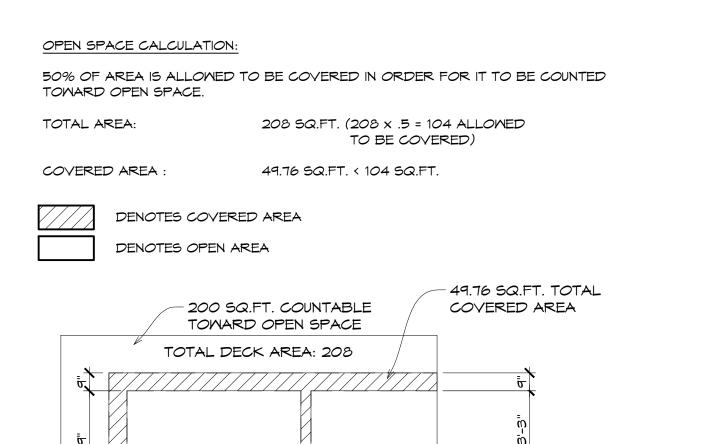


10 1/2"

1'-0 1/2"

1'-0 1/2"

1'-0 1/2"

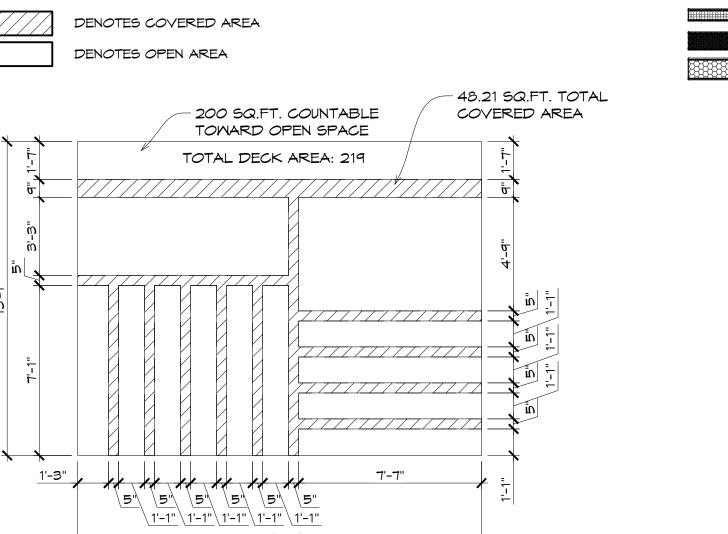

219 SQ.FT. (219 x .5 = 109.5 ALLOWED

TO BE COVERED)

50% OF AREA IS ALLOWED TO BE COVERED IN ORDER FOR IT TO BE COUNTED

16'-10"

48.215Q.FT. < 109.5 SQ.FT.

SECOND FLOOR PLAN

1/4" = 1'-0"

2 X 4 STUD MALL

2 X 6 STUD MALL

2 X 8 STUD MALL

2 X 8 STUD MALL

2 X 10 STUD MALL

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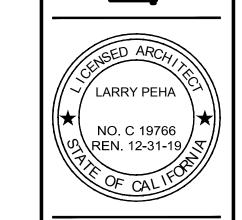
10/29/18 PLANNING

SUBMITTAL

2/17/19 PLANNING COMMENTS

NEW TWO UNIT CONDOS FOR:

TOTAL OF THE CONDOS FOR:





PEHA & ASSOCIATES

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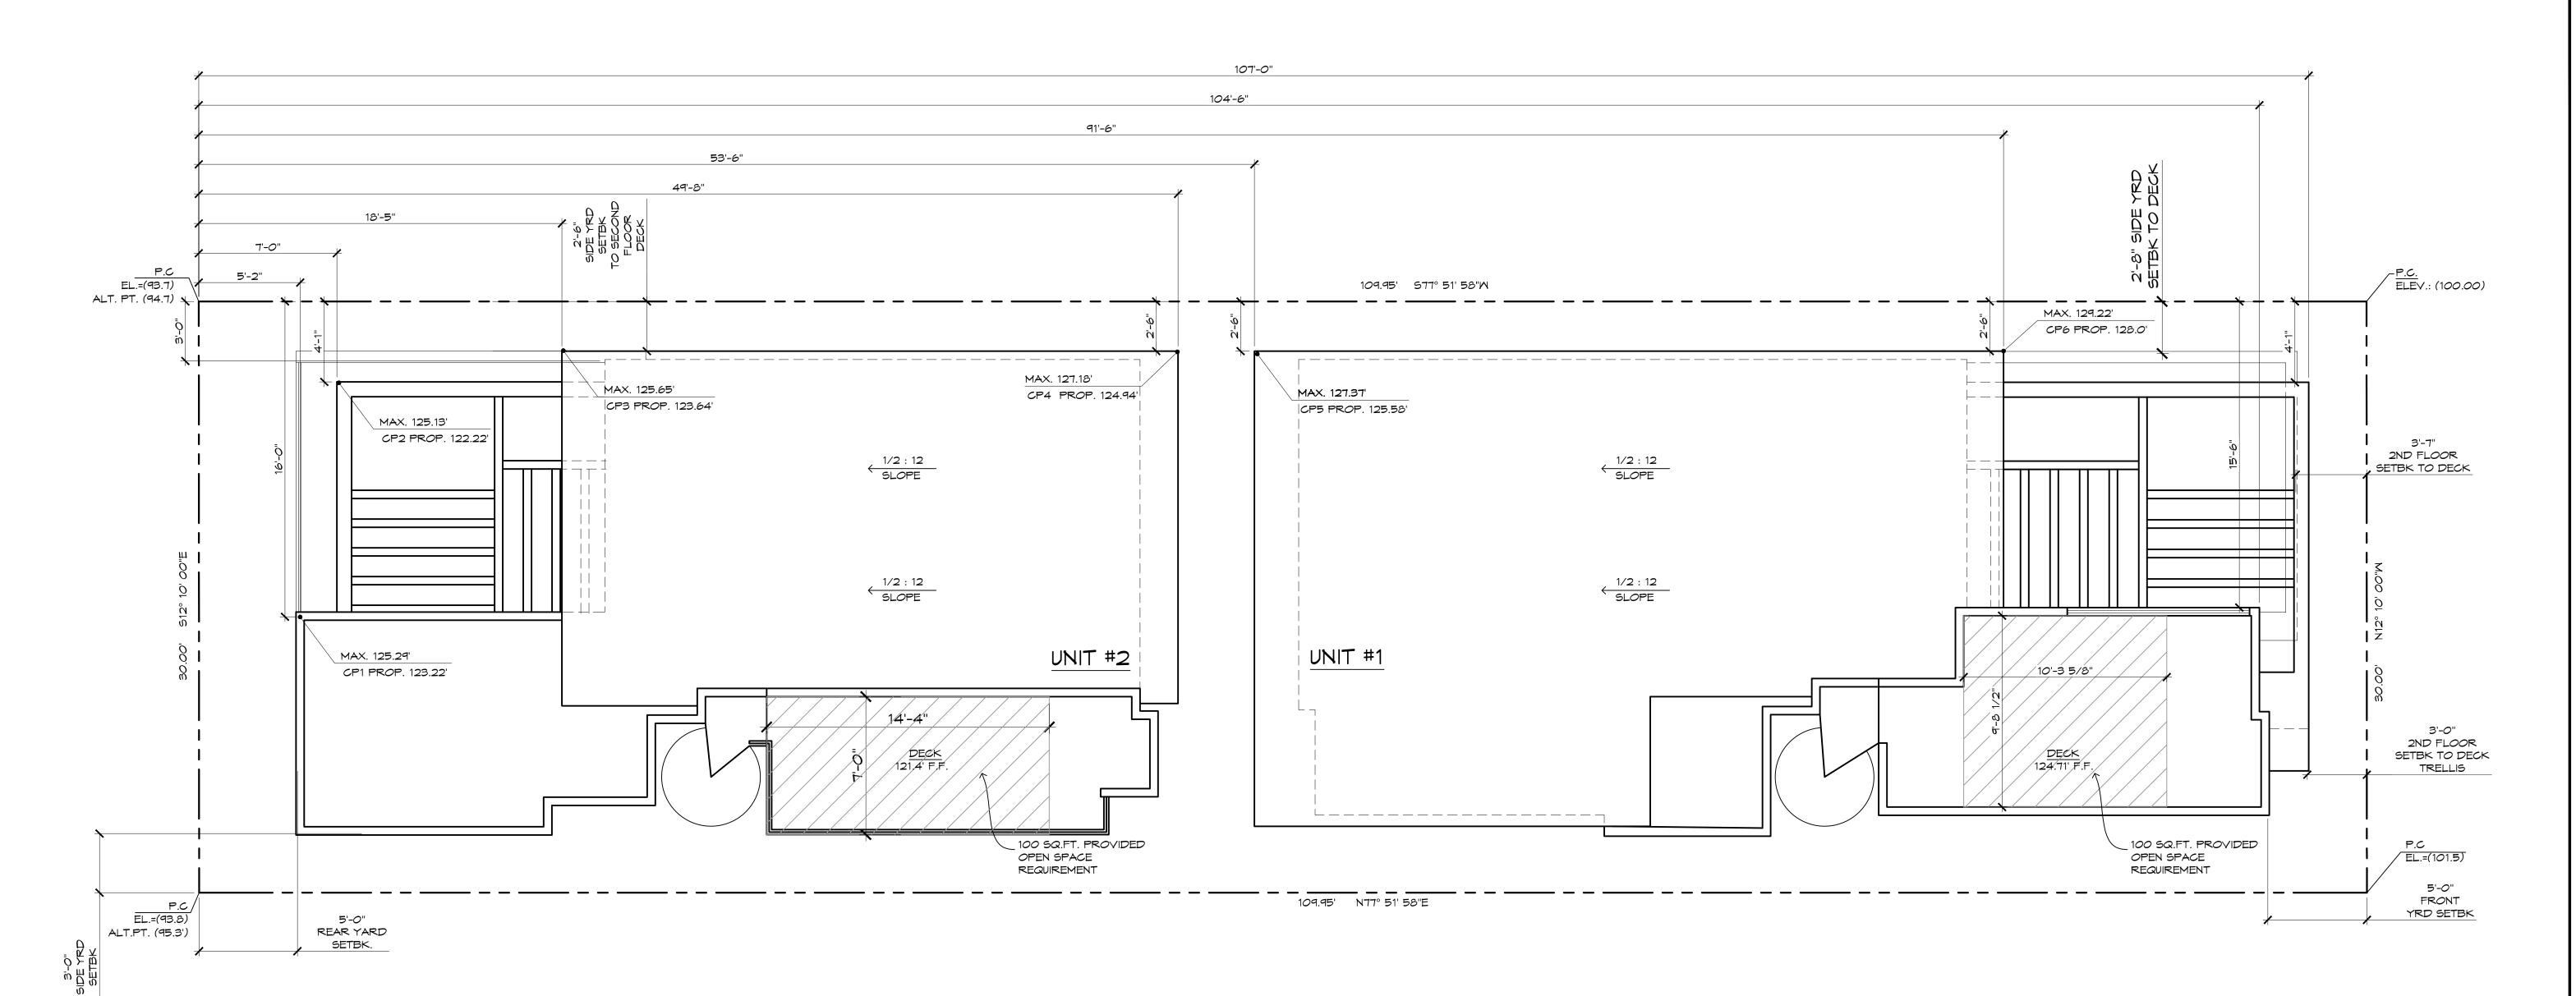
DRAWN: ATR

JOB NO. 1715

DRAWING TITLE

SECOND FLOOR
PLAN

DRAWING NUMBER



HEIGHT CALCULATION

Elev. Pt. A	94.7		Elev. Pt. A	94.7		Elev. Pt. A	94.7		Elev. Pt. A	94.7	
Elev. Pt. B	100		Elev. Pt. B	100		Elev. Pt. B	100		Elev. Pt. B	100	
Length A-B	109.95		Length A-B	109.95		Length A-B	109.95		Length A-B	109.95	
Length A-AB'	5.1667		Length A-AB'	7		Length A-AB'	53.5		Length A-AB'	91.5	
	Elev. AB':	94.9490542		Elev. AB':	95.0374261		Elev. AB':	97.2788995		Elev. AB':	99.1106412
Elev. Pt. C	95.3		Elev. Pt. C	95.3		Elev. Pt. C	95.3		Elev. Pt. C	95.3	
Elev. Pt. D	101.5		Elev. Pt. D	101.5		Elev. Pt. D	101.5		Elev. Pt. D	101.5	
Length C-D	109.95		Length C-D	109.95		Length C-D	109.95		Length C-D	109.95	
Length C-CD'	5.1667		Length C-CD'	7		Length C-CD'	53.5		Length C-CD'	91.5	
	Elev. CD':	95.5913464		Elev. CD':	95.6947249		Elev.CD':	98.3168258		Elev. CD':	100.459618
Length AB'-CD'	30		Length AB'-CD'	30		Length AB'-CD'	30		Length AB'-CD'	30	
Length AB'-OP1	16		Length AB'-OP1	4.0833		Length AB'-CP5	2.5		Length AB'-CP6	2.5	
	Elev. OP1	95.2916101		Elev. OP1	95.126891		Elev. CP5	97.3653934		Elev. CP6	99.2230559
Height Limit	30		Height Limit	30		Height Limit	30		Height Limit	30	
Max. Ht. @ CP1:	125.29		Max. Ht. @ CP2:	125.13		Max. Ht. @ CP5:	127.37		Max. Ht. @ CP6:	129.22	
Prposd Ht @ OP1:			Prposd Ht @ CP2:			Prposd Ht @ CP5:			Prposd Ht @ CP6:		
		,									
Elev. Pt. A	94.7		Elev. Pt. A	94.7							
Elev. Pt. B	100		Elev. Pt. B	100		Elev. Pt. A	94.7		Elev. Pt. A	94.7	
Length A-B	109.95		Length A-B	109.95		Elev. Pt. B	100		Elev. Pt. B	100	
Length A-AB'	18.4167		Length A-AB'	49.667		Length A-B	109.95		Length A-B	109.95	
	Elev. AB':	95.5877536		Elev. AB':	97.0941346	Length A-AB'	104.5		Length A-AB'	107	
Elev. Pt. C	95.3		Elev. Pt. C	95.3			Elev. AB':	99.7372897		Elev. AB':	99.857799
Elev. Pt. D	101.5		Elev. Pt. D	101.5		Elev. Pt. C	95.3		Elev. Pt. C	95.3	
Length C-D	109.95		Length C-D	109.95		Elev. Pt. D	101.5		Elev. Pt. D	101.5	
Length C-CD'	18.4167		Length C-CD'	49.667		Length C-D	109.95		Length C-D	109.95	
	Elev. CD':	96.3385042		Elev. CD':	98.1006858	Length C-CD'	104.5		Length C-CD'	107	
Length AB'-CD'	30		Length AB'-CD'	30			Elev.CD':	101.192678		Elev. CD':	101.333652
Length AB'-OP1	2.5		Length AB'-CP1	2.5		Length AB'-CD'	30		Length AB'-CD'	30	
	Elev. CP1	95.6503162		Elev. OP1	97.1780139	Length AB'-CP7	15.5		Length AB'-CP8	4.0833	
Height Limit	30		Height Limit	30			Elev. OP7	100.489241		Elev. CP8	100.058677
Max. Ht. @ CP3:	125.65		Max. Ht. @ CP4:	127.18		Height Limit	30		Height Limit	30	
Prposd Ht @ CP3:			Prposd Ht @ CP4:			Max. Ht. @ CP7:	130.49		Max. Ht. @ CP8:	130.06	
						Proposd Ht @ CP7:			Prposd Ht @ CP8		




NOTE:

1. DIMENSIONS ON THIS PLAN ARE FOR LOCATING CRITICAL PTS. U.N.O.

2. ON JANUARY 22, 2018 THE COMMUNITY DEVELOPMENT DIRECTOR FOUND A SIGNIFICANT VARIATION IN ELEVATIONS AT THE NORTHWEST AND SOUTHWEST PROPERTY CORNERS AND APPROVED THE USE OF ALTERNATIVE POINTS (94.7 AND 95.3)

ISSUE/REVISION 10/29/18 PLANNING SUBMITTAL
2/17/19 PLANNING COMMENTS

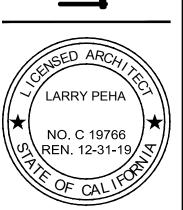




PEHA & ASSOCIATES ARCHITECTURE

Larry Peha, A.I.A

HERMOSA BEACH, CA. 90254 PHONE: (310) 372 - 1755 FAX: (310) 376 - 6837 E-MAIL: pa@pehaarch.com Web: www.pehaarch.com

DATE: 10/3/2018 DRAWN: ATR JOB NO. 1715 DRAWING TITLE ROOF PLAN

DRAWING NUMBER

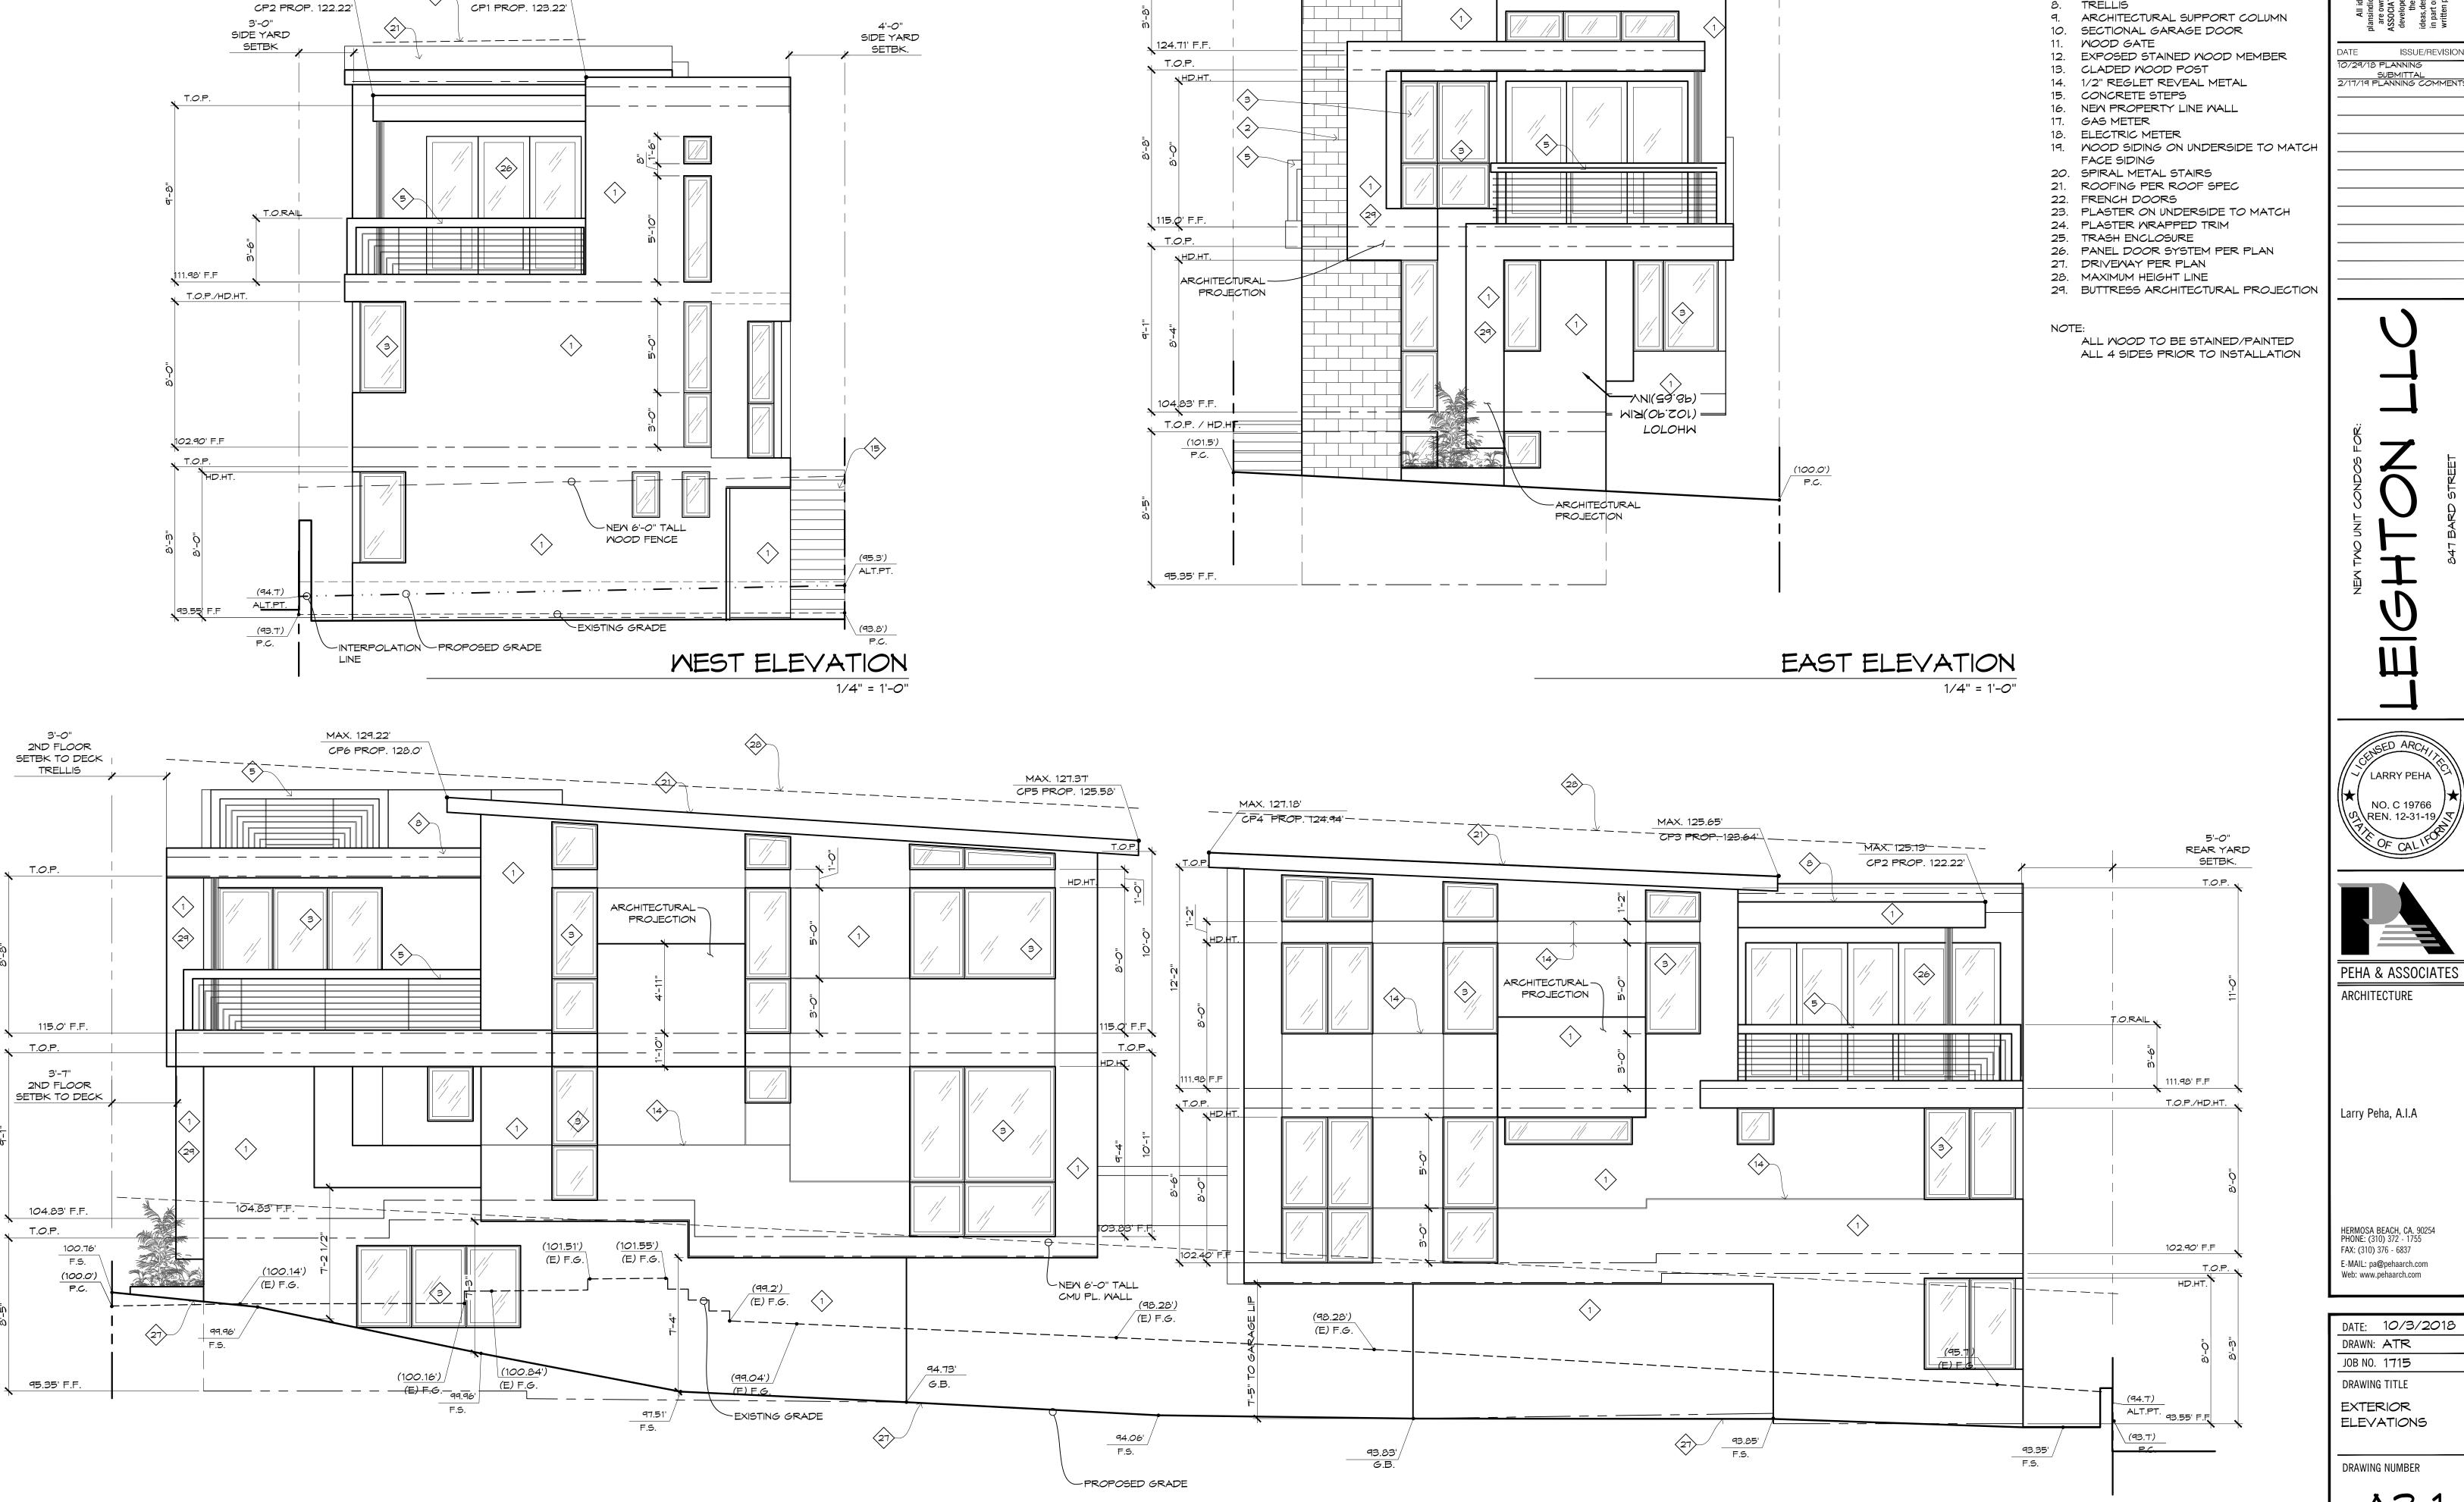

SIDE YARD

T.O. WALL

SETBK.

MAX. 125.13'

MAX. 125.29'

ELEVATION KEYNOTES

EXTERIOR PLASTER FINISH SMOOTH

STONE VENEER PER PLAN

GLAZING SYSTEM PER PLAN

PANEL DOOR SYSTEM RAILING PER PLAN


GLASS RAILING ENTRY DOOR TRELLIS

3'-0"

SIDE YARD

SETBK

ISSUE/REVISION

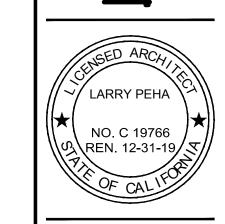



ARCHITECTURE

Larry Peha, A.I.A


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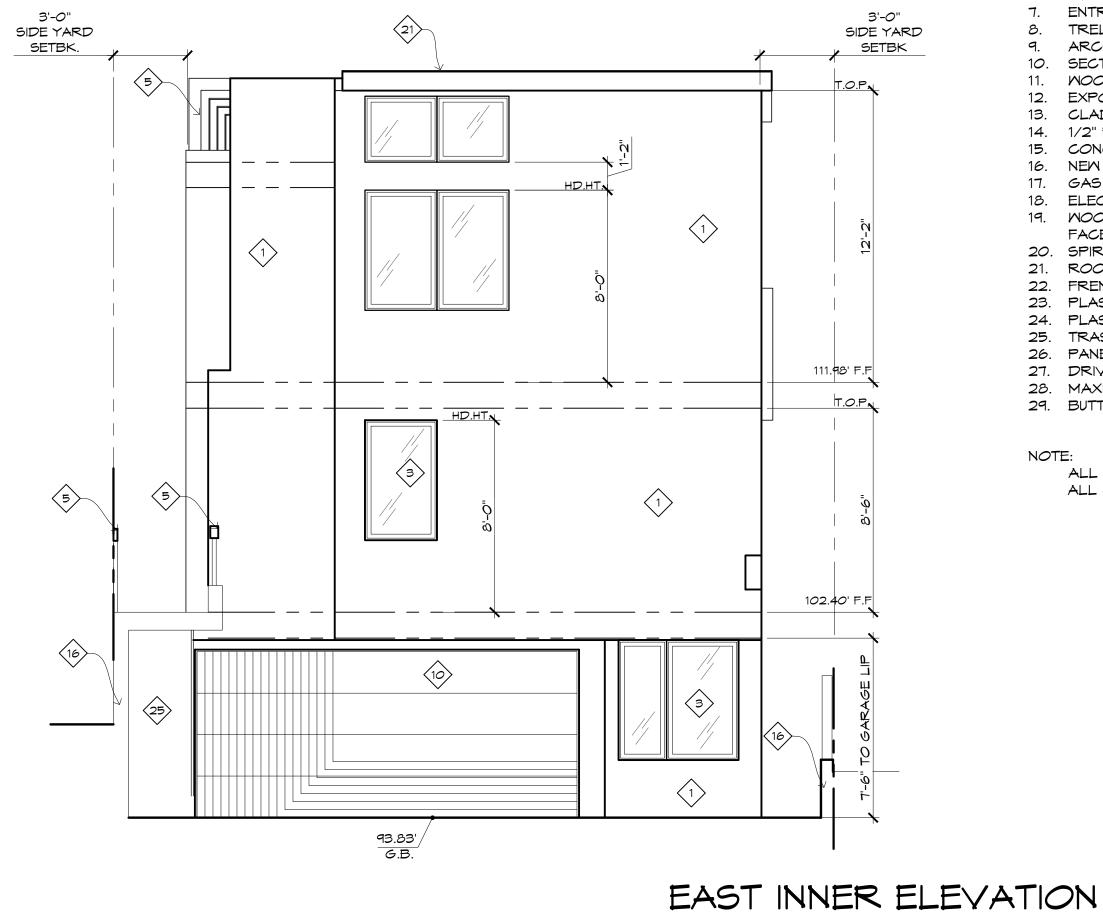
DATE: 10/3/2018 DRAWN: ATR JOB NO. 1715 DRAWING TITLE EXTERIOR **ELEVATIONS**


A3.


NORTH ELEVATION

1/4" = 1'-0"



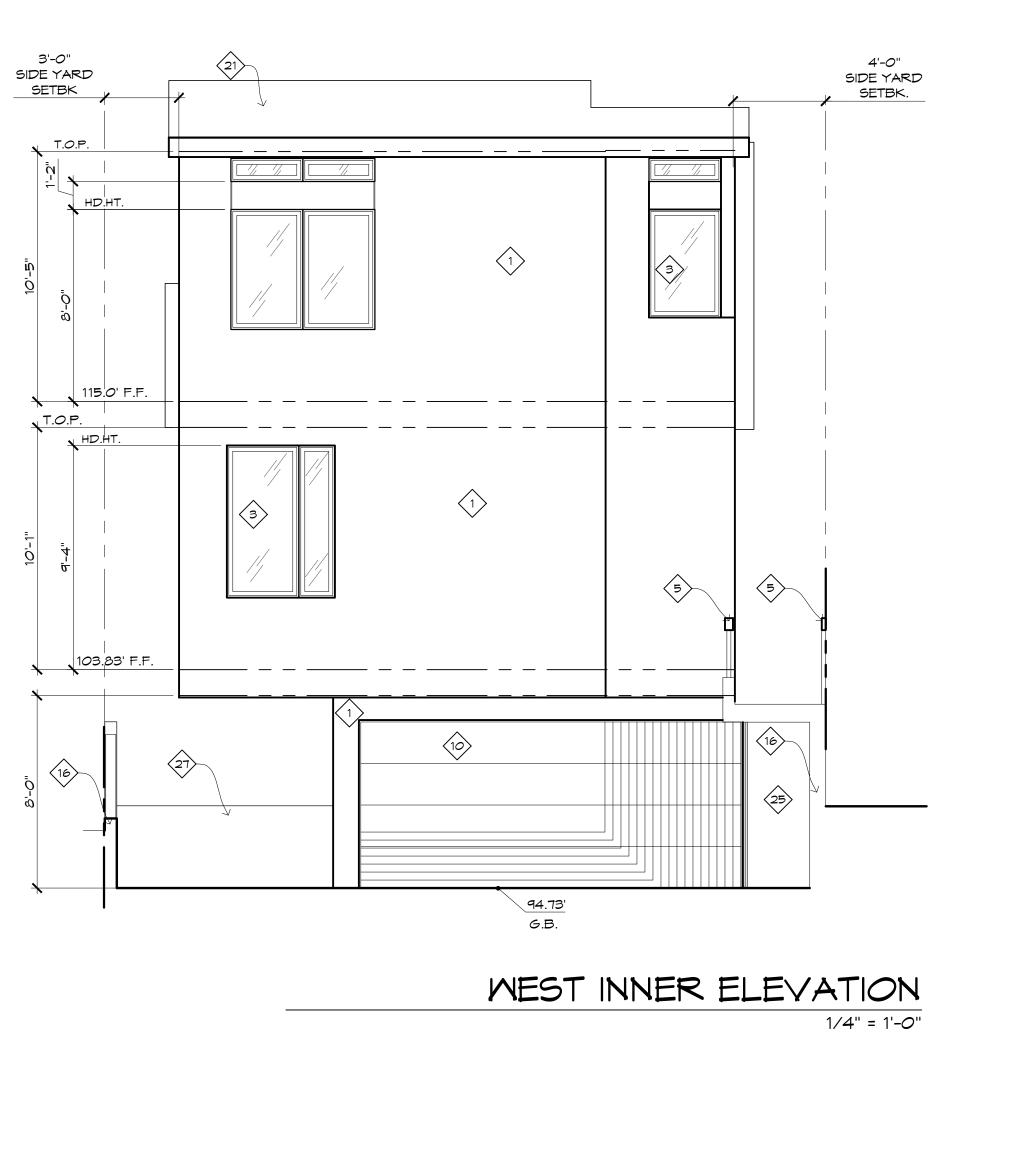

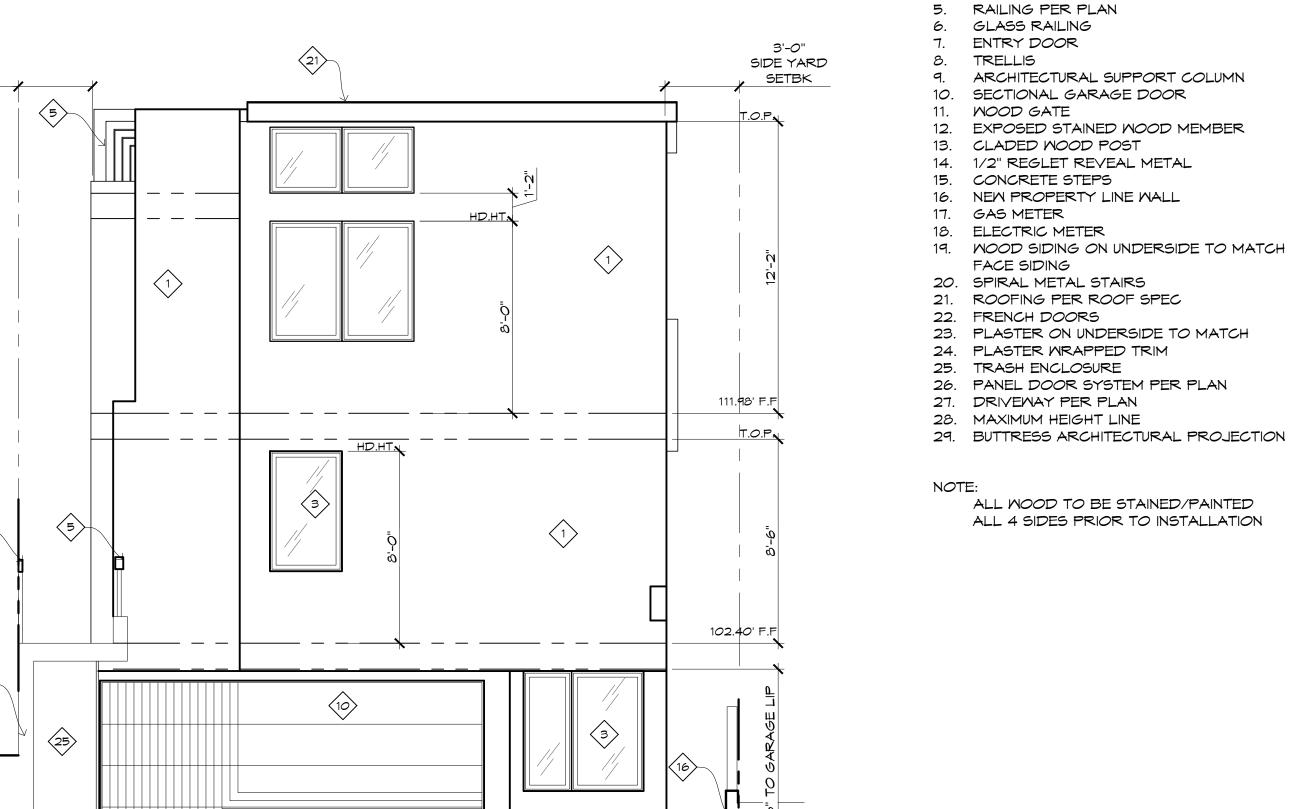

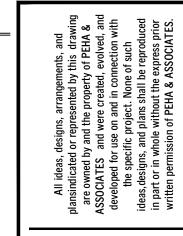

ISSUE/REVISION 10/29/18 PLANNING SUBMITTAL
2/17/19 PLANNING COMMENTS

ALL WOOD TO BE STAINED/PAINTED ALL 4 SIDES PRIOR TO INSTALLATION

1/4" = 1'-0"

1/4" = 1'-0"


ELEVATION KEYNOTES

GLAZING SYSTEM PER PLAN

2. STONE VENEER PER PLAN

PANEL DOOR SYSTEM

EXTERIOR PLASTER FINISH SMOOTH

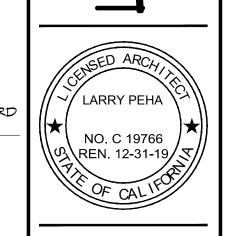




PEHA & ASSOCIATES ARCHITECTURE


Larry Peha, A.I.A


HERMOSA BEACH, CA. 90254 PHONE: (310) 372 - 1755 FAX: (310) 376 - 6837 E-MAIL: pa@pehaarch.com Web: www.pehaarch.com

DATE: 10/3/2018 DRAWN: ATR JOB NO. 1715 DRAWING TITLE EXTERIOR

DRAWING NUMBER

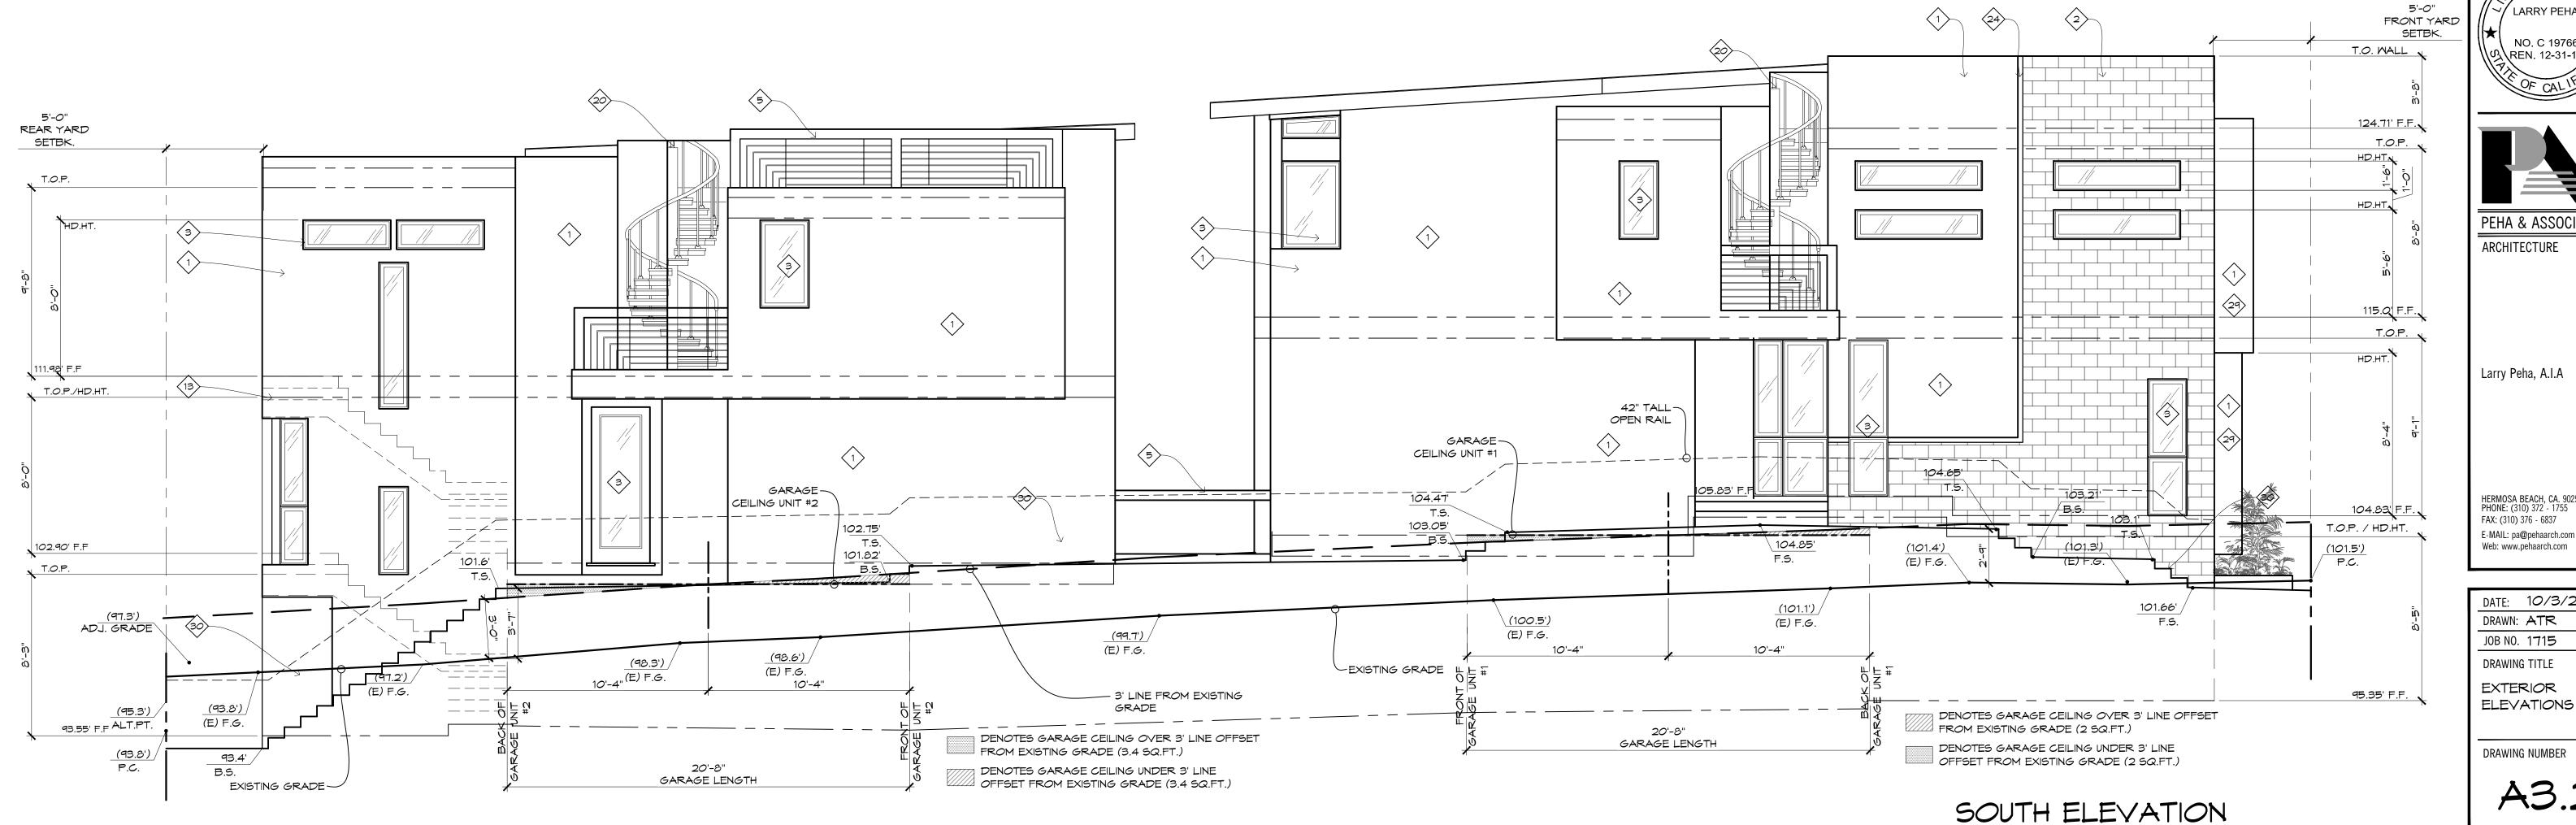

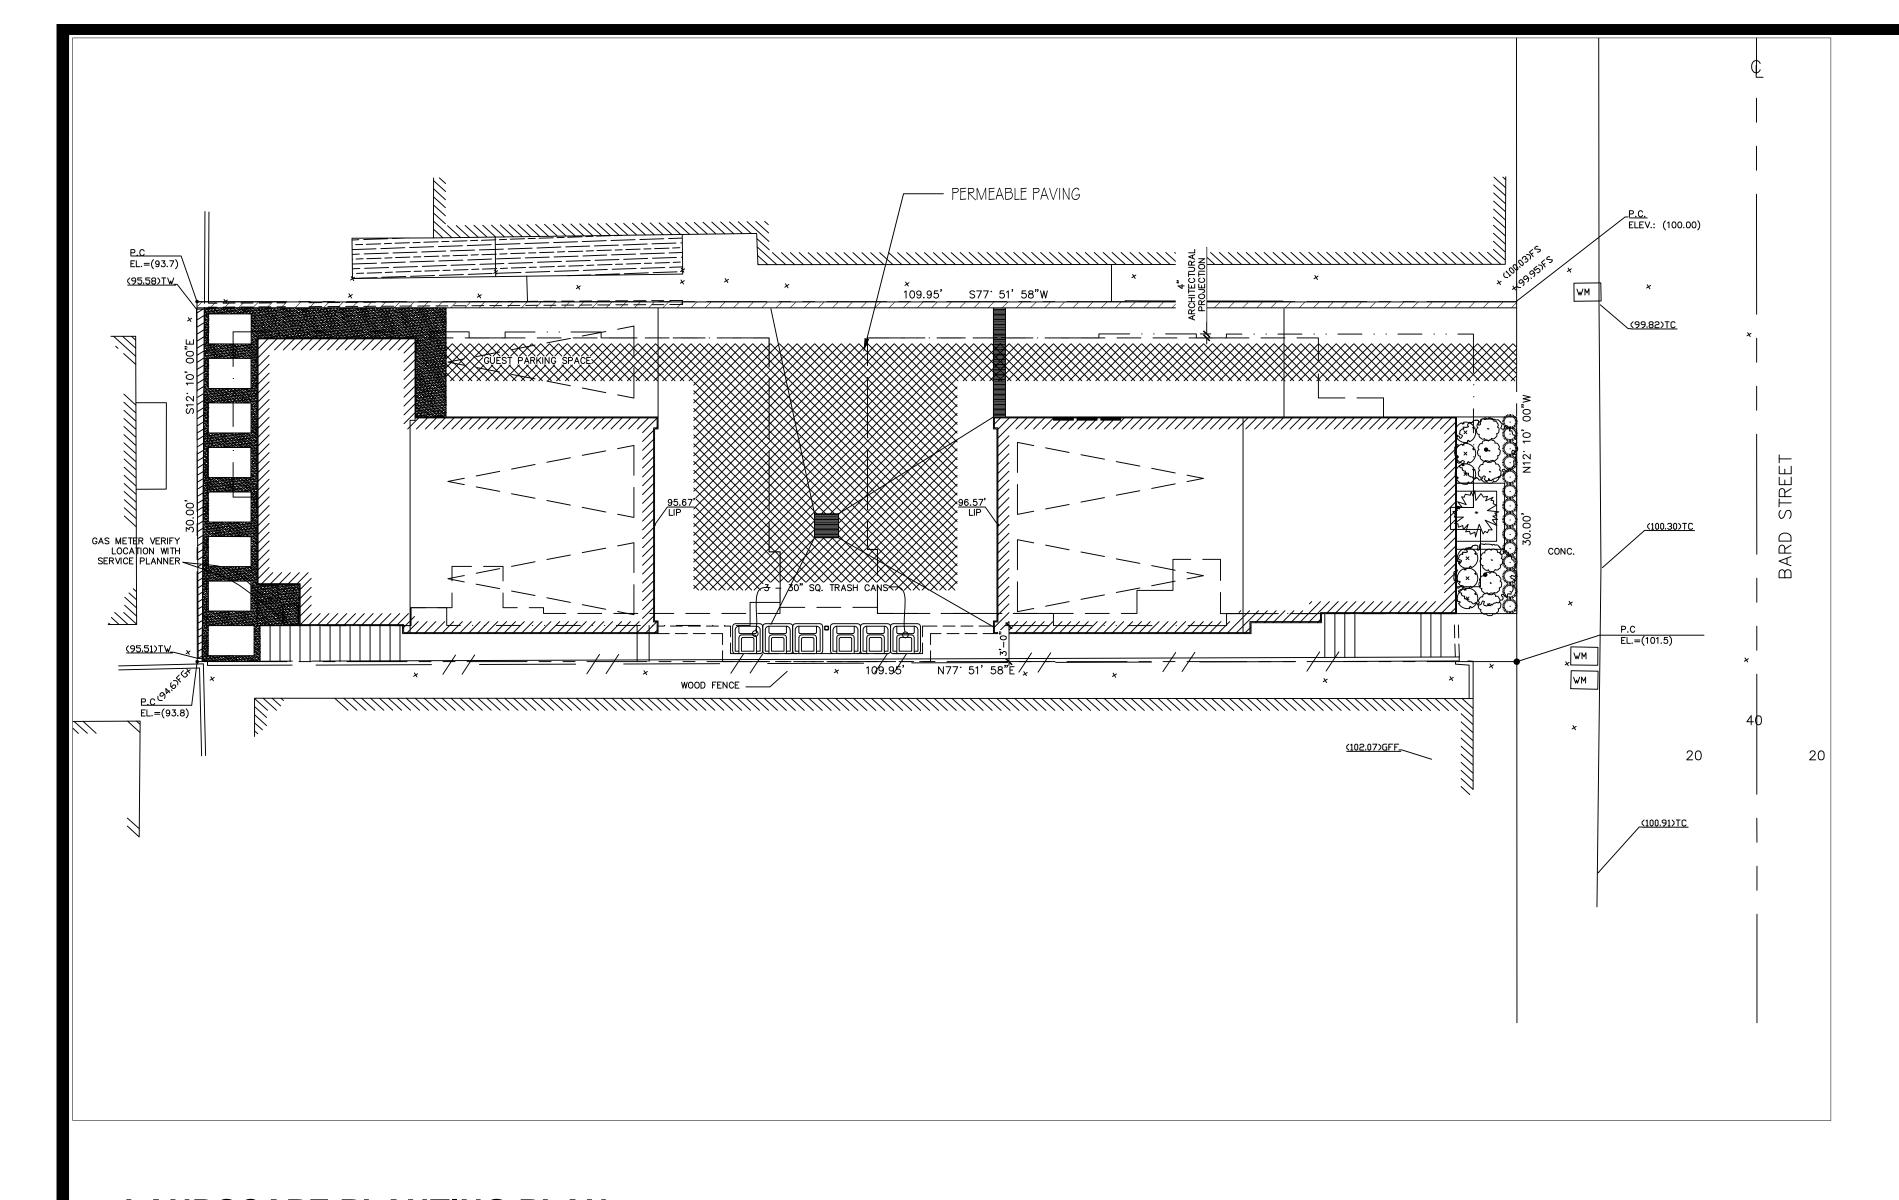

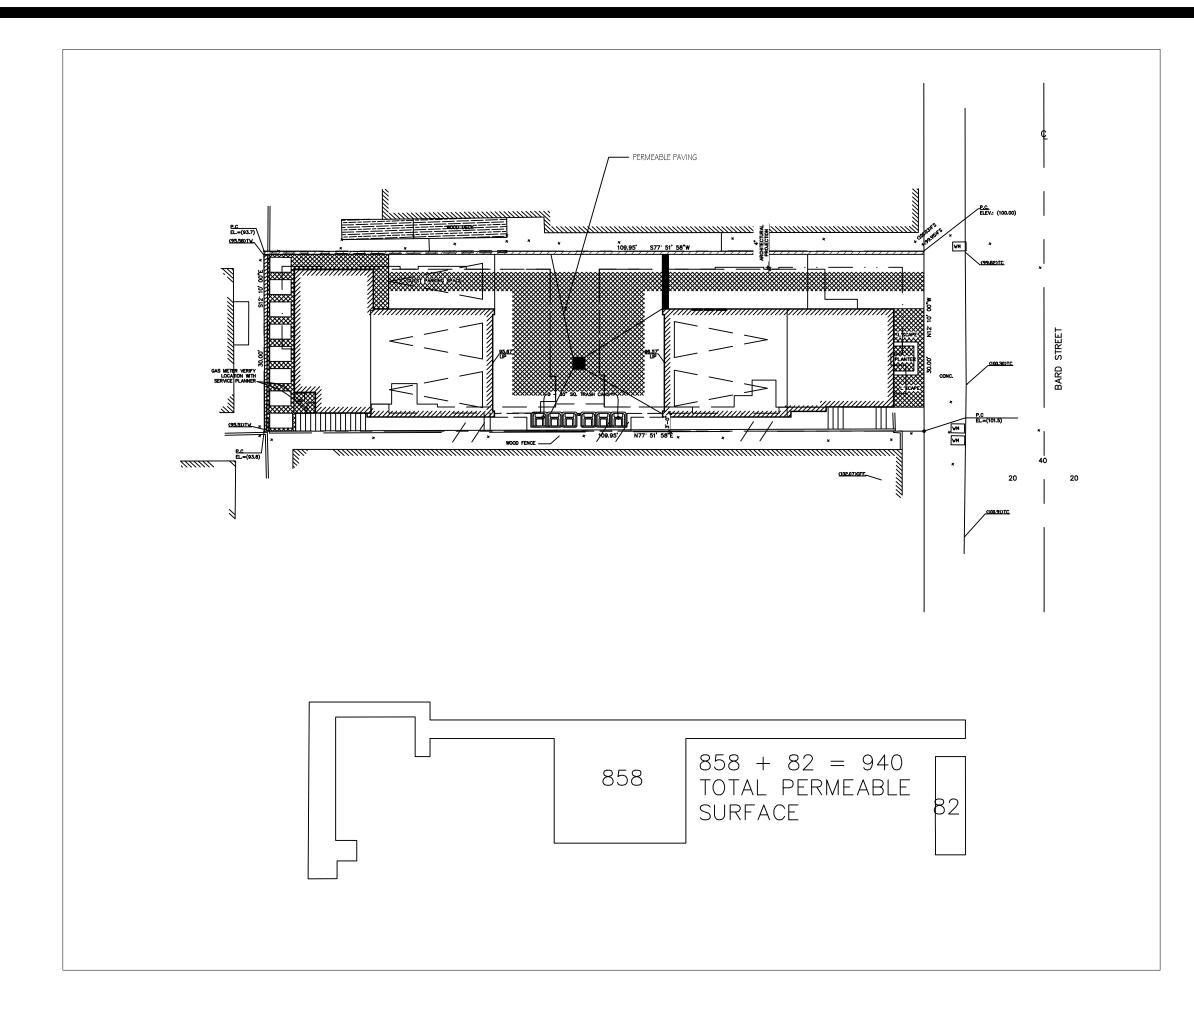

PERMEABLE AREA

1/16" = 1'-0"

PERMEABLE / LANDSCAPE
PLANTED AREAS

LANDSCAPE PLANTING PLAN

1/8" = 1'-0"

	PLANT LEGEND											
	PICTURE OF PLANTS	SYMBOL	VEGETATION TYPE	BOTANICAL NAME	COMMON NAME	REGIONAL EVALUATIONS WATER NEEDS	SIZE	DIAMETER (MATURED)	HEIGHT (MATURED)	QTY	NOTES	
		Con and a series of the series	TREE	CERCIS OCCIDENTALIS 'FOREST PANSY'	FOREST PANSY REDBUD	LOW	24"	15'	20'	2	REPLACEMENT TREES PER PLANNERS NOTES	
/	© Joginder Nursery		SHRUB	ALOE ARBORESCENS	CANDELABRA ALOE	LOW	15 GAL	48"	8'	1		
		X	SHRUB	WESTRINGEA FRUTICOSA WYNABIE GEM	COASTAL ROSEMARY	LOW	5 GAL	36"	42"	6		
			PERENIAL	ANIGOZANTHOS 'HARMONY'	HARMONY KANGAROO PAW	LOW	5 GAL	24"	24"	5		
			GROUND COVER	SENECIO MANDRAELISCAE	BLUE CHALKSTICKS	LOW	4"	12"	9"	14	PLANT 12" OC	

AREA CALCULATION

Lot Square Footage =	3,298 sq.ft	
Building Footprint =	1,325 sq.ft	
Hardscape Area =	1,033 sq.ft	
Landscape / Permeable Area =	940 sq.ft	
Permeable Area =	940 sq.ft	

STORMWATER AND URBAN RUNOFF POLLUTION CONTROL REGULATIONS SECTION 8.44.095

E la consequence of law large of Day

F. Incorporation of Low Impact Development Program Requirements into Project Plans.

I. New development and redevelopment projects are required to control pollutants and runoff volume from the project site by minimizing the impervious surface area through effective site design and use of water permeable surfaces (e.g., permeable paving or landscaping) to the extent it is technically feasible on not less than fifty (50) percent of exterior surface areas excluding building footprints, and controlling runoff through infiltration, bioretention, and/or rainfall harvest and use, in accordance with the standards set forth in the Municipal NPDES Permit

Infiltration System Not

1. The proposed permeable surface is less hand 50% of the exterior surface, an infiltration system will be provided per HBMC 8.44.095 (F)

Irrigation Notes:

I. An automatic irrigation system using either evapotranspiration or soil moisture sensor data, with rain shut-off sensor, shall be pursuant to HBMC 8.60.060.(D)

Planting Notes

I. All construction debris is to be removed prior to planting.

2. All exposed areas to be covered with 2" of fine bark mulch



Landscaping Co. Inc.

Centeno's

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LEIGHTON LLC 847 BARD STREET HFRMOSA BFACH CA 90254


Revision

Date

09-8-18

10-26-18

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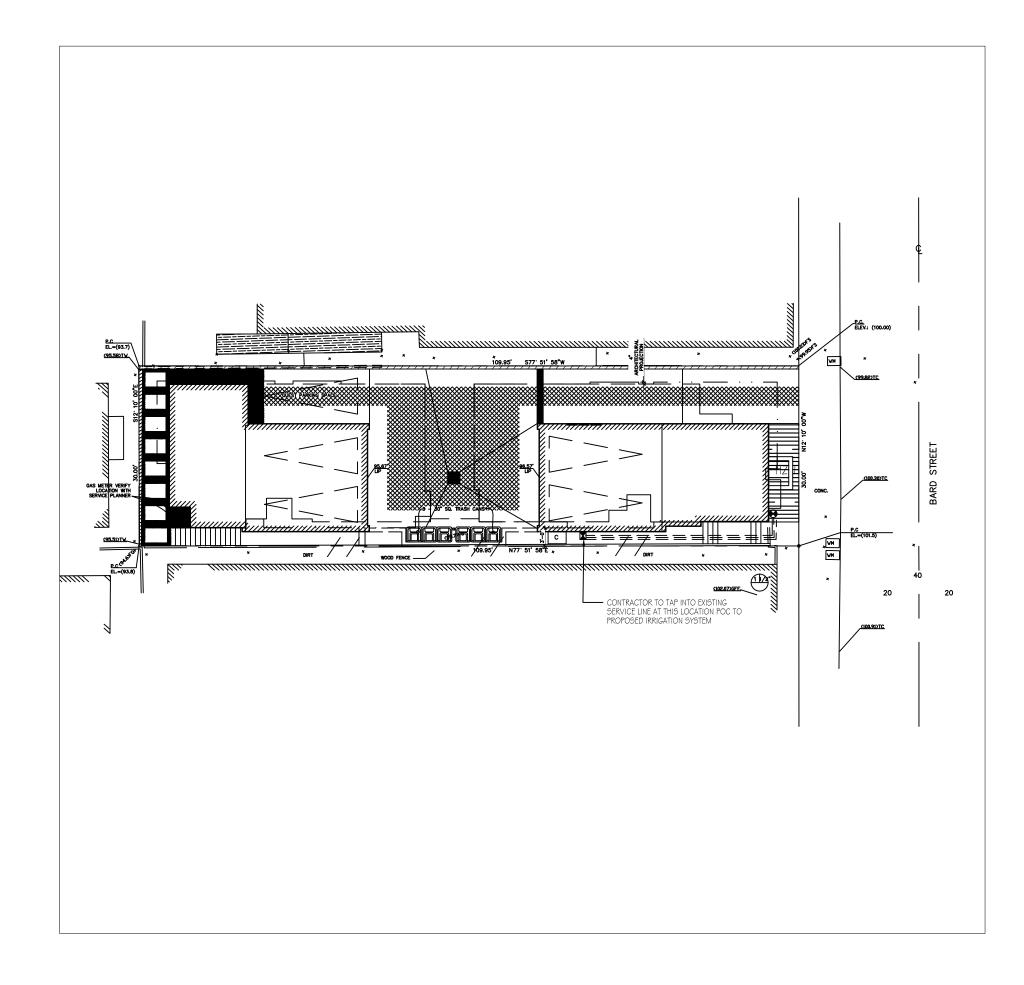


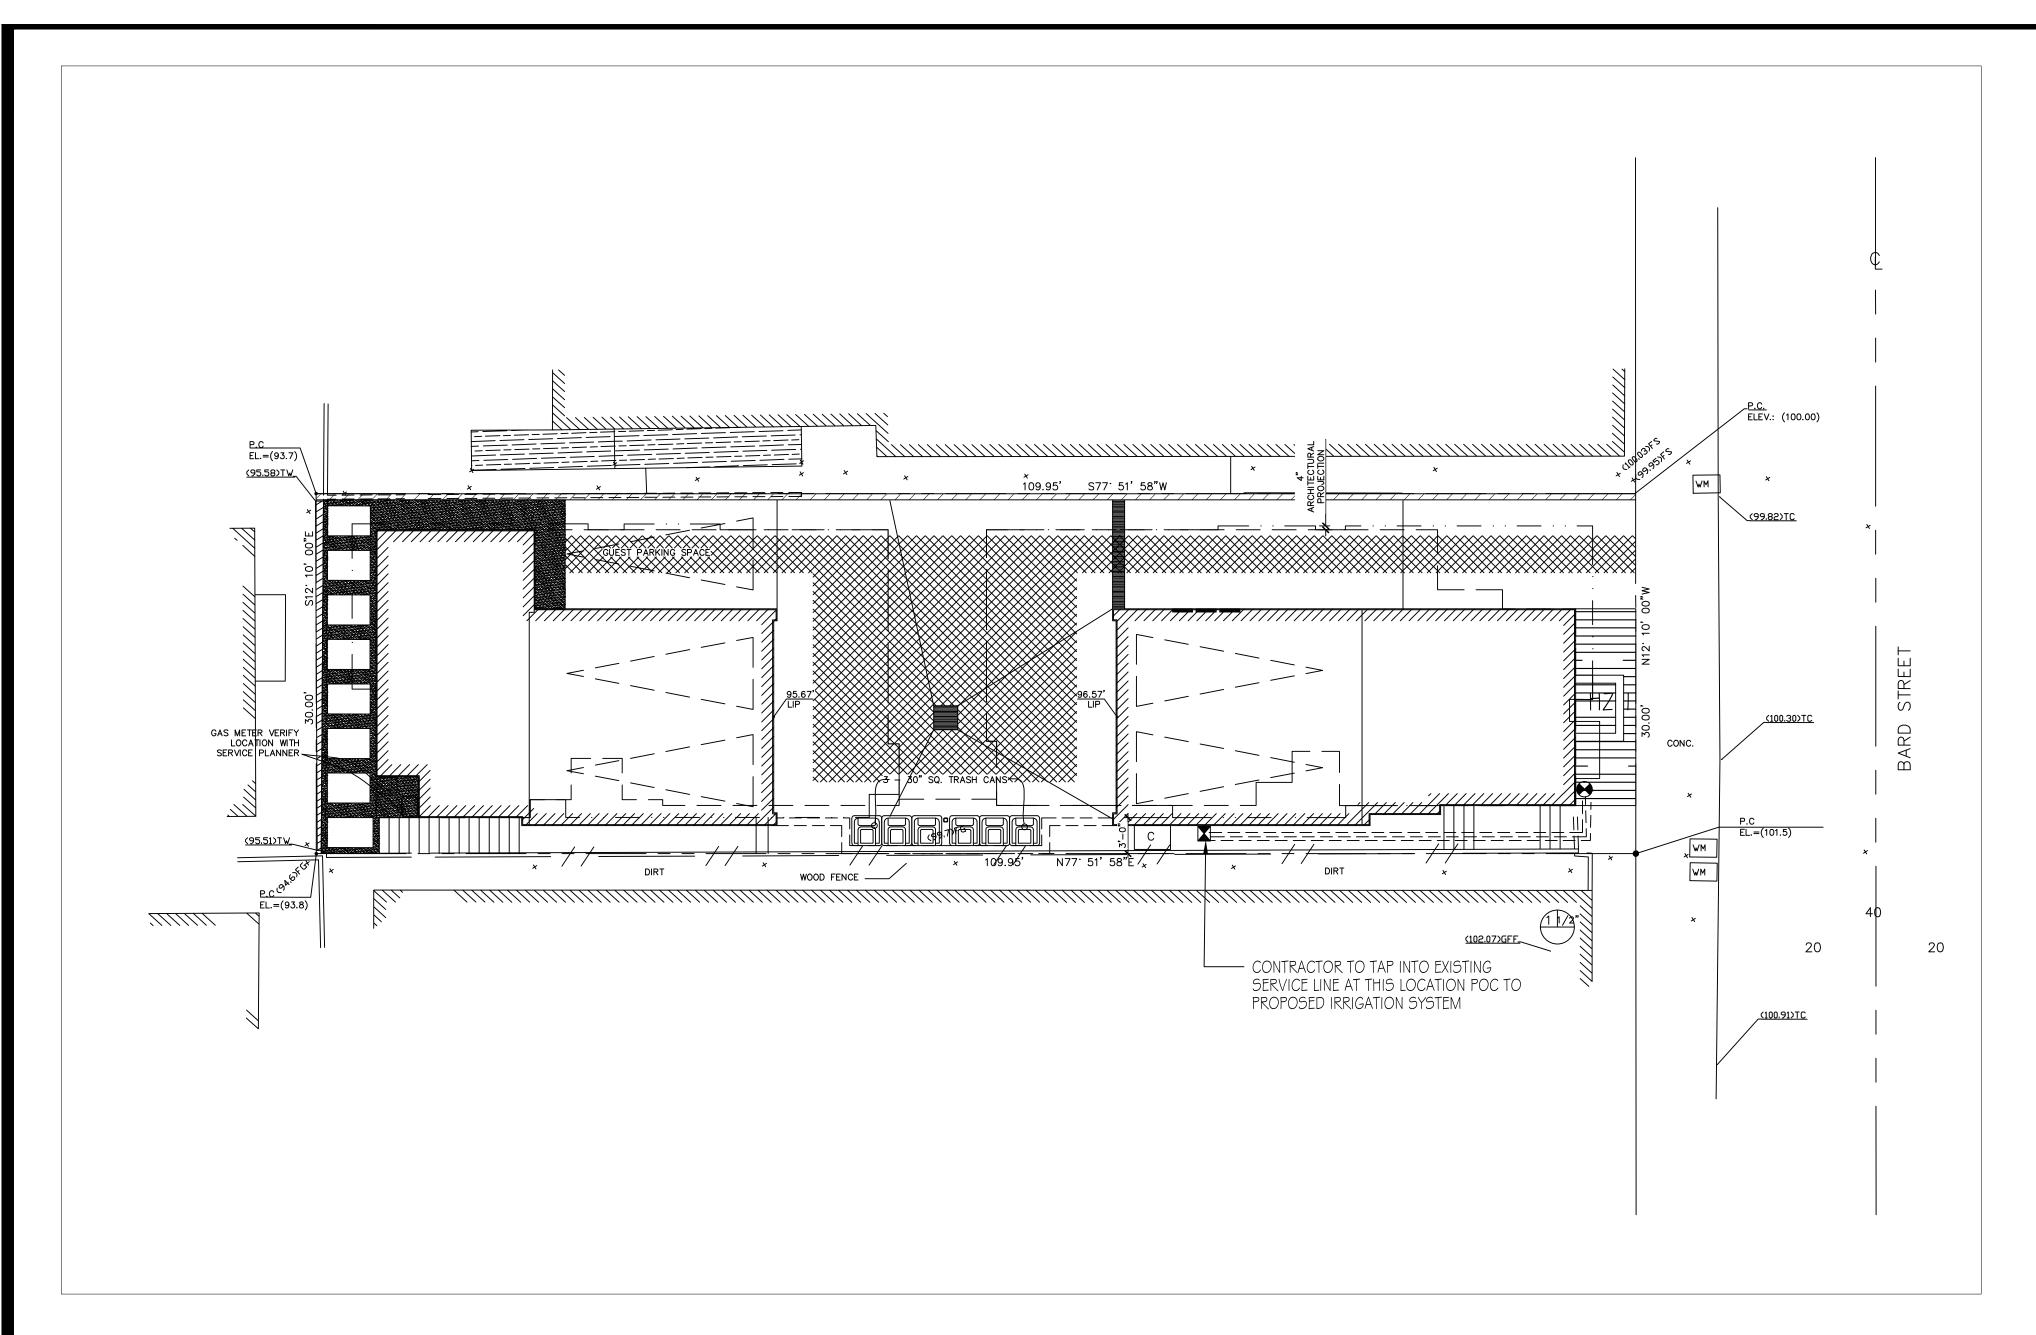LANDSCAPE IRRIGATION PLAN

1/8" = 1'-0"

SYMBOL	MANUFACTURER MODEL	RADIUS	GPM	PSI	PRECIP. RATE	COMMENTS
	/ DESCRIPTION					
	NETAFIM TECHLINE EZ	N/A	.60 GPH	30 PSI	N/A	SEE DETAILS FOR INSTALLATIO
	NIBCO BALL VALVE: T-FB- 600A					INSTALL W/ CARSON 10" ROUN #910
RP	FEBCO 825Y-3" 825-QT-RP					INSTALL PER MANUFACTURE SPECIFICATIONS
	RAINBIRD REMOTE CONTROL ZONE KIT: XCZF-175					
_	HUNTER 4 STATION PRO-C- INDOOR IRRIGATION CONTROLLER					INSTALL PER MANUFACTURER
С	WITH WIRELESS SOLAR SYNC SENSOR: PC-400-I-SOLAR-SYNC-SEN					SPECIFICATIONS TO BE MOUNTE
	3/4" SCHEDULE 40 LATERAL LINE					SOLVENT WELD
	LINE					
	SCHEDULE 40 PIPE AND WIRE SLEEVING					PVC SLEEVE UNDER ALL PAVING TWO PIPE SIZES GREATER THAN THE PIPING WHICH IS TO RUN IN THE SLEEVE. COVER DEPTH SHALL BE THE SAME AS THE MAINLIN OR LATERAL LINE SOLVENT WELD
	1" SCHEDULE 40 IRRIGATION MAINLINE					BE THE SAME AS TH





HYDROZONE AREAS

1/16" = 1'-0"

ES	ESTIMATED TOTAL WATER USE CALCULATIONS (BASED ON Eto=42)							
VALVE #	HYDROZONE	PLANT WATER USE TYPE(S)	(PF) PLANT FACTOR	HA AREA	PF X HA	ΙE	ETWU GAL/YR	
1	1	LOW	.6	82	49	.9	1271	
						SUM	1271	

AREA CALCULATION

Lot Square Footage =	3,298 sq.ft
Building Footprint =	1,325 sq.ft
Hardscape Area =	1,033 sq.ft
Landscape / Permeable Area =	940 sq.ft
Permeable Area =	940 sq.ft

MAWA = Maximum Applied Water Allowance (gallons per year)

MAWA = (42.00 inches) (0.55) [(0.7 x 82 sq ft) + (0.3 x 0) = 1326 gallons per yearETWU = (42.00) (0.55) [(49/0.9) + 0)] = 1271 gallons per year

IRRIGATION PLAN



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LEIGHTON LLC 847 BARD STREET IERMOSA BEACH, CA 90254

Date By

09-8-18

10-26-18

03-25-19

05-26-19

Date: 07-28-18

Scale: AS NOTED

Drawn by: JC

Sheet:

L-2

1. THIS IRRIGATION DESIGN IS DIAGRAMMATIC. ALL PIPING, VALVES, ETC. SHOWN WITHIN PAVED AREAS ARE FOR DESIGN CLARIFICATION ONLY. INSTALL ALL COMPONENTS IN PLANTING AREAS WHEREVER

POSSIBLE. DUE TO THE SCALE OF THE DRAWINGS IT IS NOT POSSIBLE TO INDICATE ALL OFFSETS, FITTINGS, SLEEVES, ETC., WHICH MAY BE REQUIRED. THE CONTRACTOR SHALL CAREFULLY INVESTIGATE THE STRUCTURAL AND FINISHED CONDITIONS AFFECTING ALL OF HIS WORK AND PLAN HIS WORK ACCORDINGLY, FURNISHING SUCH FITTINGS, ETCH AS MAY BE REQUIRED TO MEET SUCH CONDITIONS.

2. THE CONTRACTOR SHALL NOT WILLFULLY INSTALL THE IRRIGATION SYSTEM AS SHOWN ON THE DRAWINGS WHEN IT IS OBVIOUS IN THE FIELD THAT UNKNOWN OBSTRUCTIONS GRADE DIFFERENCES OR DIFFERENCES IN THE AREA DIMENSIONS EXIST THAT MIGHT NOT HAVE BEEN ADDRESSED IN THE DESIGN OF THE IRRIGATION SYSTEM.

3.SET ALL VALVES AND QUICK COUPLERS NEXT TO WALKS OR PAVED SURFACES IN LOCATIONS WITH NO ADJACENT PAVING, COORDINATE FINAL LOCATION WITH OWNER.

4. CONTROLLER LOCATION IS DIAGRAMMATIC. OBTAIN FINAL LOCATION APPROVAL FROM THE OWNER PRIOR TO INSTALLATION.

5. PENDING 120VAC ELECTRICAL POWER SOURCE AT CONTROLLER LOCATION IS NOT A PART OF THE IRRIGATION SYSTEM. COORDINATE POWER REQUIREMENTS WITH GENERAL CONTRACTOR AND/OR OWNFR.

6. IT IS THE RESPONSIBILITY OF THE IRRIGATION CONTRACTOR TO BE FAMILIAR WITH THE EXISTING SITE CONDITIONS, UTILITIES GRADE DIFFERENCES, LOCATION OF WALLS, ETC. THE IRRIGATION CONTRACTOR SHALL REPAIR OR REPLACE ALL ITEMS DAMAGED BY HIS WORK. HE SHALL COORDINATE HIS WORK WITH OTHER CONTRACTORS FOR THE LOCATION AND INSTALLATION OF PIPE SLEEVES AND LATERALS UNDER ROADWAYS AND PAVING, ETC.

7. ALL SPRINKLER EQUIPMENT NOT OTHERWISE DETAILED OR SPECIFIED SHALL BE INSTALLED AS PER MANUFACTURER'S RECOMMENDATIONS AND SPECIFICATIONS.

8. IT IS THE CONTRACTOR'S RESPONSIBILITY TO ENSURE THAT THE NEW SYSTEM HAS THE CORRECT PSI IN ORDER FOR ALL THE VALVES TO OPERATE AS PER PLAN.

8.56. 060 Water Conservation and Drought Management Plan.

This Chapter establishes a water conservation and drought management plan consisting of both permanent regulations designed to reduce water usage and increase the efficiency of water use on an ongoing basis, and three increasingly restrictive levels of drought response actions to be implemented in times of drought

8.56. 070 Water Conservation Requirements.

The following water conservation requirements shall apply to all persons:

A. Landscaping.

1. Watering hours and duration. No lawn or landscaped area shall be irrigated or watered by any means between the hours of 9:00 a.m. and 6:00 p.m. on any day. Above-ground spray irrigation or watering shall not exceed fifteen (15) minutes per irrigation station or area. This provision shall not apply to drip irrigation systems, use of a hand-held bucket or similar container, use of a hand-held hose equipped with a positive action quick-release shutoff valve or nozzle, irrigation necessary to establish newly planted low water usage plants, or water expended for limited periods of time necessary for irrigation system maintenance or leak

2. Over-watering: No lawn or landscaped area shall be irrigated or watered to the point where excess water ponds, sprays or runs off the lawn or landscaped area onto any walkways, sidewalks, driveways, streets,

3. Irrigation during rainfall: No lawn or landscaped area shall be irrigated or watered during rainfall or within 24 hours after measurable rainfall.

4. Landscape maintenance: All lawns and landscaping shall be regularly maintained to reduce water use by such methods as aerating, thatching and mulching.

5. Landscape irrigation system maintenance: Landscape irrigation systems shall be regularly inspected, maintained and repaired to eliminate leaks, remove obstructions to water emission devices and eliminate

B. Pools and spas. New pools and spas shall be equipped with a cover. Not later than July 1, 2012, all existing pools and spas shall be constructed, installed or equipped with a cover. Pools and spas shall be

covered overnight and daily when use is concluded. C. Water fountains and decorative water features. No person shall operate a fountain or other decorative

water feature that does not recycle or re-circulate the water utilized by the device. D. Cleaning. No person shall use water to wash or clean any sidewalks, walkways, patios, driveways, alleys, parking or similar areas, whether paved or unpaved; however, use of water brooms or pressure washers or similar low flow technology, or water recycling systems to clean these surfaces, is permitted. In no case shall such water run off the property or drain onto any walkways, sidewalks, streets, alleys or storm drains. E. Car washing. No person shall use water to wash or clean any motorized or un-motorized vehicle, including, but not limited to, an automobile, truck, boat, van, bus, motorcycle, trailer or similar vehicle, except by use of a bucket or similar container or a hand-held hose equipped with a positive action

quick-release shutoff valve or nozzle. This subsection shall not apply to any commercial car washing facility that uses a water recycling system to capture or reuse water.

F. Waste and leaks. No person shall:

1. Cause, permit or allow water to leak from any exterior or interior pipe, hose or plumbing fixture. 2. Cause, permit or allow water to flow from any source on private or public property onto walkways, sidewalks, streets, alleys or storm drains, except as a result of rainfall or pumping excessive groundwater infiltration, such as by means of a sump pump.

3. The use of water for cleaning, washing and other uses shall be performed in an efficient manner to reduce waste and total water use.

Chapter 8.56 Water Conservation and Drought Management Plan

8.56. 010 Title.

This Chapter shall be known as the "City of Hermosa Beach Water Conservation and Drought Management Plan Ordinance."

8.56. 020 Findings

A. A reliable supply of potable water is essential to the public health, safety and welfare of the people and

economy of the State, the southern California region and City of Hermosa Beach. B. The State of California, southern California region and the City of Hermosa Beach suffer from periodic water shortages, and a growing population, climate change, environmental concerns, periodic energy

shortages, and other factors make the region highly susceptible to water supply reliability issues. C. An active water conservation program with conservation measures applicable to all sources and uses of

water is essential to ensure a reliable supply of water for drinking, sanitation and fire protection, and to protect the public health, safety and welfare. D. A Water Conservation and Drought Management Plan is necessary to properly manage water supplies and mitigate the effects of water shortages within the City by reducing water consumption by residents,

businesses and visitors, while minimizing the hardship caused to the general public to the greatest extent E. Recycled water (including water reclaimed by the West Basin Municipal Water District, graywater to the extent allowed by law and capture of rainwater) is a valuable resource that can be used to offset imported

8.56. 030 Purpose and Intent

A. The purposes of this Chapter are to increase the conservation and efficient use of potable water, maximize the use of recycled water, and provide a drought management plan. The plan will reduce water consumption and extend available water supplies, minimize the effects and hardship of water shortages on the City and the general public to the greatest extent possible, and maximize the socioeconomic and environmental benefits associated therewith.

B. This Ordinance is intended solely to further the conservation of water. It is not intended to implement or supersede any federal, state, or local statute, Ordinance or regulation relating to protection of water quality or control of drainage or runoff.

C. This Ordinance does not modify, terminate or otherwise affect the water services or water rates of any

8.56. 040 Definitions.

The terms in this Chapter relating to various uses of property shall be as defined in Title 17 (Zoning) and shall be broadly construed to achieve the purposes of this Chapter. In addition:

"Approval Authority" means the City Manager or his/her designee.

and other water supplies and shall therefore be regulated under this Chapter.

"Commercial" means commercial, industrial, or any other nonresidential business or use. "Discretionary planning entitlement" means a land use permit or approval granted by the planning

commission necessary to proceed with development. "Existing" as used in this Chapter means, as applicable:

A. An existing building means a building that was constructed or had received all required approvals to commence construction on or prior to April 1, 2010.

B. An existing establishment means a business establishment that was in operation on or prior to April 1,

G. All commercial establishments

1. Single pass cooling systems. Single-pass cooling systems shall not be installed in new commercial buildings. When single pass cooling systems in existing businesses are replaced, single pass cooling system shall not be installed as a replacement.

2. Toilets. New commercial establishments shall install and use only water-efficient toilets. All existing

commercial establishments shall install and use only water-efficient toilets by January 1, 2014. H. Eating and drinking establishments. The following provisions shall also apply to all restaurants, cafes,

snack shops, bars, other eating and drinking establishments, and food catering businesses:

1. All establishments shall only provide drinking water to customers upon request.

2. All establishments shall install and use low-flow pre-rinse dishwashing spray nozzles by July 1, 2011. 3. All establishments shall use low-flow technologies for washing and cleaning floors and surfaces, such as

using a hand-held bucket or similar container and mop, water brooms or pressure washers. 4. New establishments shall install and use water-efficient dishwashing machines or systems. When

dishwashing machines in existing businesses are replaced, water-efficient dishwashing machines or systems shall be installed. All existing establishments shall install and use only water-efficient dishwashing machines or systems by January 1, 2014.

I. Hotels and motels. The following provisions shall apply to all hotels, motels, hostels, bed and breakfast and similar temporary accommodation establishments:

1. All establishments shall provide customers the option of choosing not to have towels and linens laundered daily and shall prominently display notice of this option in each bathroom and sleeping room using clear and easily understood language.

2. All establishments that provide on-premises facilities for laundering towels or linens shall comply with Subsection J of this Section.

3. All establishments that provide food services shall comply with Subsection H of this Section. J. Laundry businesses. New commercial laundry businesses shall install and use water recycling systems. When washing machines in existing businesses are replaced, water-efficient laundry washing or water recycling systems shall be installed. All existing laundry businesses shall install and use only water-efficient laundry washing machines or water recycling systems by January 1, 2014.

K. Commercial car wash facilities. New commercial conveyor-type car wash facilities shall install water recycling systems. All existing conveyor car wash systems shall install and operate only water recycling systems by January 1, 2012. All existing commercial car wash operations, including those accessory to another use, shall use high pressure, low volume wash systems, bucket or similar container, and/or a hand-held hose equipped with a positive action quick-release shutoff valve or nozzle, or similar low-flow device by January 1, 2012.

L. Exceptions. The provisions of this Section are not applicable to uses of water that are necessary to protect public health and safety or for essential governmental services when such uses of water cannot be reduced, such as for fire-fighting and other similar emergency services.

8.56. 080 Drought Response Level 1 – Drought Alert Condition.

A. The City Council may by Resolution declare a Drought Alert condition and implement the Level 1 conservation measures set forth in this Section on the grounds that, due to water supply cutbacks caused by drought or reduction in supplies for other reasons, an overall consumer demand reduction of up to ten (10) percent is required in order to have sufficient water supplies available to meet anticipated demands.

B. Except as otherwise stated in this Chapter, during a Level 1 Drought Alert condition all persons using water shall comply with the following additional conservation measures:

1. Watering days and duration. Limit lawn and landscape watering or irrigation to no more than three (3) days per week. Above-ground spray irrigation shall be limited to no more than fifteen (15) minutes per watering station or area; this limitation shall not apply to the use of recycled water to maintain public parks and facilities. The City Council may by Resolution establish a schedule of permissible watering days. This provision shall not apply to commercial nurseries, drip irrigation systems, use of a hand-held bucket or similar container and/or a hand-held hose equipped with a positive action quick-release shutoff valve or

"Irrigation system" or "landscape irrigation system" means an irrigation system with pipes, hoses, spray heads, or sprinkling devices that is operated through an automated system.

"New" means as applicable:

A. "New building" means a building that is constructed, or receives all required approvals to commence construction, after April 1, 2010.

B. "New establishment," "new business" or "new facility" mean a business establishment that initiates operation, or receives all required approvals to initiate operation, after April 1, 2010.

"Person" means any natural person or persons, corporation, public or private entity, governmental agency or institution, or any other user of water within the City.

"Positive action quick-release shutoff valve or nozzle" means a hand-held sprayer or similar device that quickly, automatically and absolutely stops the flow of water when the user stops exerting pressure.

Water-efficient devices emit not more than three (3) gallons of water per minute. "Pre-rinse dishwashing spray nozzle" means a hand-held device that uses a spray of water to remove food and grease from dishware, utensils and pans before placing them in the dishwasher that emits not more than 1.6 gallons of water per minute.

"Pressure washer" means a water conserving cleaning device that emits not more than three (3) gallons of

"Recycled water" or "recycling system" means the capture, reclamation and reuse of non-potable water for

"Single pass cooling system" means equipment where water is circulated only once to cool equipment before the water is disposed.

"Water broom" means a water conserving sweeping device with spray jets that emit not more than three (3) gallons of water per minute.

"Water-efficient" means a water conserving fixture, device or system that complies with the water conservation standards of the most current edition of the California Plumbing Code or, if no standard applies, is EPA WaterSense labeled or its equivalent. In no case shall the fixture, device or system use more water than is indicated by the standard stated in this section.

"Water-efficient irrigation systems" means systems using water conserving devices, including but not limited to weather based controllers, drip/micro-irrigation systems with emitters that emit not more than two (2) gallons of water per hour, and stream rotor sprinklers that meet a seventy (70) percent or greater efficiency

"Water-efficient dishwashing machines or systems" mean devices that use not more than one (1) gallon of

"Water-efficient laundry washing machines" means machines have a water factor of 6.0 or less, wherein

water factor means the number of gallons of water used per cycle, divided by the tub volume. "Water-efficient toilet" means toilets using not more than 1.6 gallons per flush or urinals using not more than

one (1) gallon per flush.

"Water recycling system" means a system that reclaims and reuses non-potable water.

8.56. 050 Applicability.

This Chapter is applicable to every person, commercial business, or other water user in the use of any water within the City. The City Council may by Resolution exempt pilot programs or special programs of limited scope undertaken by the City or undertaken in conjunction with the City's water providers.

8.56. 060 Water Conservation and Drought Management Plan.

This Chapter establishes a water conservation and drought management plan consisting of both permanent regulations designed to reduce water usage and increase the efficiency of water use on an ongoing basis, and three increasingly restrictive levels of drought response actions to be implemented in times of drought conditions.

8.56. 090 Drought Response Level 2 – Drought Critical Condition

A. The City Council may by Resolution declare a Drought Critical condition and implement the Level 2 conservation measures set forth in this Section on the grounds that, due to water supply cutbacks caused by drought or reduction in supplies for other reasons, an overall consumer demand reduction of ten (10) to twenty (20) percent is required in order to have sufficient water supplies available to meet anticipated

B. During a Drought Critical condition all persons using water shall comply the following additional

1. Watering days and duration. Limit lawn and landscape watering or irrigation to no more than two (2) days per week, provided that the City Council may by Resolution limit lawn and landscape watering or irrigation to no more than one (1) day per week to achieve a reduction of up to twenty (20) percent. Above-ground spray irrigation shall be limited to no more than fifteen (15) minutes per watering station or area; this limitation shall not apply to the use of recycled water to maintain public parks and facilities. The City Council may by Resolution establish a schedule of permissible watering days. This provision shall not apply to commercial nurseries, drip irrigation systems, use of a hand-held bucket or similar container and/or a hand-held hose equipped with a positive action quick-release shutoff valve or nozzle.

8.56. 100 Drought Response Level 3 – Drought Emergency Condition

A. The City Council may by Resolution declare a Drought Emergency condition and implement the Level 3 conservation measures set forth in this section on the grounds that overall consumer demand reduction of more than twenty (20) percent is required because the ordinary demands and requirements of water consumers cannot be satisfied without depleting water supplies to the extent that there would be insufficient water for human consumption, sanitation, and fire protection.

B. During a Drought Emergency condition all persons using water shall comply with Sections 8.56.070 (Water Conservation Requirements) and the following additional mandatory conservation measures: 1. Irrigation and watering prohibition. No lawn or landscaping watering or irrigation shall be allowed. This subsection shall not apply to the following, provided that watering days and watering duration shall comply with Subsection B of Section 8.56.090:

a. Irrigation or watering using recycled water.

b. Irrigation necessary to establish new plantings of low water usage plants or commercial nurseries.

c. Water efficient landscape irrigation systems using water efficient devices, including but not limited to weather based controllers, drip/micro-irrigation systems with emitters that emit no more than two (2) gallons per hour and stream rotor sprinklers that meet a seventy (70) percent or greater efficiency standard. d. Maintenance of trees and shrubs that are watered by using a bucket or other watering container, hand-held hose equipped with positive action quick-release shutoff valve or nozzle, or similar low-volume non-spray

e. Maintenance of existing landscaping necessary for fire protection as specified by the Fire Chief.

f. Maintenance of existing landscaping on slopes exceeding ten (10) percent for erosion control.


g. Maintenance of landscaping within active public parks and playing fields, day care center play areas, and school grounds.

h. Public works projects.

i. Maintenance of plant materials identified to be rare, threatened or endangered or essential to the health of documented rare, threatened or endangered animals.

2. Cleaning surfaces. Water shall not be used to wash, clean or clear any sidewalks, walkways, patios, driveways, alleys, parking or similar areas, whether paved or unpaved; except commercial or industrial establishments may use water broom, pressure washer or similar low flow technology or water recycling systems when necessary to comply with health, safety, water quality or other regulations verified by the approval authority. Pressure washers may be used to clean surfaces in preparation for painting, construction, or occasional seasonal maintenance when other methods are not practical.

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Date Revision 09-8-18 0-26-18 03-25-19 05-26-19

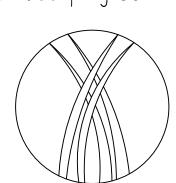Date: 07-28-18 Scale: Drawn by: JC

- 3. Car Washing. Vehicles shall not be washed, except at commercial car wash facilities that recycle water or use high pressure, low volume wash systems. Subject to Subsection E of Section 8.56.070, this provision shall not apply to car washes held as fund raising activities for bona fide community organizations, washing of garbage trucks, or washing of vehicles used to transport food and perishables, and washing of other mobile equipment for which frequent cleaning is essential for the protection of the public health, safety and
- 4. Ornamental Ponds and Lakes. Ornamental ponds or lakes if empty shall not be filled, and if filled shall not be refilled or replenished
- 5. Hotels and Motels: Mandatory Laundry Opt-Out. Hotels, motels, bed and breakfasts and similar establishments shall not provide daily towel and linen laundering service to customers, except upon a specific request.

8.56. 110 Procedures for Declaration and Notification of Drought Response Level and Additional Water

Conservation Measures.

- A. The City Council shall declare a Drought Response Level 1, 2 or 3 by Resolution in the manner required
- B. The City Council shall declare the end to any Drought Response Level by the adoption of a Resolution in the manner required by law and City procedures.

8.56. 120 Exception

- A. An exception to any water conservation requirement of this Chapter may be granted or conditionally granted in accordance with the following requirements.
- 1. Application. Any water user may file an application with the Community Development Department for an exception from one or more water conservation measures on a form provided by the City, including supporting documents and information demonstrating the grounds for the requested exception, accompanied by a fee set by Resolution of the City Council.
- 2. Findings. The approving authority may approve, conditionally approve or deny an application for an exception from water conservation measures. An application for an exception shall be denied unless the approval authority finds, based on the information provided in the application, supporting documents or such additional information as may be requested, all of the following:
- a. That, due to special circumstances applicable to the property or its use, the strict application of this Ordinance would disproportionately impact the property or use when compared to similar types of uses or properties; and
- b. That other water conserving measures to substantially off-set the proposed water use have been or will be employed as a condition of the approval, or the lack of such measures will not materially affect the ability of the City to achieve the purposes of this Chapter; and
- c. That the exception does not constitute a grant of special privilege inconsistent with the limitations upon other residents and businesses.
- 3. Approval authority. The approval authority shall act upon any application no later than ten (10) days after receipt of a complete application, and may approve, conditionally approve, or deny the exception. The applicant requesting the exception shall be promptly notified in writing of any action taken. Unless otherwise specified at the time an exception is approved, the exception shall only apply during the period of the specific circumstances from which an exception is requested.
- 4. Appeals. An applicant may appeal the approval authority's decision, or any conditions placed on the approval, to the City Council within ten (10) days of the date of decision. A written request shall be submitted to the City Clerk stating the grounds for the appeal accompanied by a fee adopted by Resolution of the City Council. The City Council shall review the appeal at the next available meeting that the item may be heard.

8.56. 130 Penalties and Remedies

Violations of the provisions of this Chapter are subject to the administrative penalty provisions of Chapter

7. The use, storage and disposal of all landscape and lawn care products shall comply with all manufacturer's pecifications and applicable laws, and minimize the discharge of pollutants to the environment G. Notwithstanding the requirements of this Section, landscape design and maintenance shall additionally comply with the requirements of Chapters 8.44 and 8.56, Title 17 (Zoning), any other applicable provisions of this code, and the requirements of a development permit, whichever is more restrictive.


8.60. 060 Standards for New Landscape.

- "New landscape" as defined in Section 8.60.040 shall be designed and managed to use the minimum amount of water required to maintain plant health. New landscape shall comply with all of the requirements in Sections 492.6 through 492.15 of the Model Efficient Ordinance and the following, whichever is more restrictive, unless an exception is granted pursuant to Section 8.60.050(D). A. Plant material.
- 1. Plant species and landscape design shall be adapted to the climate, soils, topographical conditions, and shall be able to withstand exposure to localized urban conditions such as pavement heat radiation, vehicle emissions and dust, and urban runoff. Water conserving plant and turf species shall be used.
- 2. Plant species or specifications shall comply with any official list of species, guidelines or regulations adopted by the City to the extent that such lists, guidelines or regulations do not conflict with this Chapter
- 3. 'Plants listed in the current Invasive Plant Inventory for the southwest region by the California Invasive Plant Council or similar source acceptable the Community Development Director are prohibited, except for known non-fruiting, non-invasive, sterile varieties or cultivars. Plants known to be susceptible to disease or pests in this Climate Zone six (6) shall not be used.
- 4. The landscape area of projects proposing exclusively commercial or industrial uses shall be designed using exclusively water conserving plants. Single family residential, multi-family residential, mixed use and institutional use projects shall be designed with not more than twenty (20) percent of the total landscaped area in turf or high water use plants in the Water Use Classification for Landscape Species (WUCOLS). Turf may be used as a bio-swale or bio-filter or for functional purposes such as active recreational areas as determined by the Community Development Director. Public agencies shall be exempt from this requirement.
- 5. Turf shall not be allowed on slopes greater than twenty (20) percent. Where the toe of the slope is adjacent to an impermeable surface, alternatives to turf should be considered on slopes exceeding twenty (20) percent, meaning one (1) foot of vertical elevation change for every five (5) feet of horizontal length. Approved turf areas may be watered at 1.0 of the reference evapotranspiration (ETo).
- 6. Planted areas shall be covered with a minimum of two (2) inches of organic mulch, except in areas covered by groundcovers or within twenty-four (24) inches of the base of a tree, or where a reduced application is indicated. Additional mulch material shall be added from time to time as necessary to maintain the required depth of mulch.
- 7. Species and landscape design shall complement and to the extent feasible in compliance with this Chapter be proportional to the surroundings and streetscape and incorporate deciduous trees to shade west and south exposures. Landscaping shall not interfere with safe sight distances for vehicular traffic, the vision clearance in Section 17.46.060, height restrictions for hedges in 17.46.130, pedestrian or bicycle ways, or overhead utility lines or lighting.
- B. Water features, pools and spas.
- 1. Recirculating water systems shall be used for water features. Where available, recycled water shall be used as a source for decorative water features.
- 2. Pools and spas shall be equipped with a cover and covered overnight and daily when use is concluded.
- C. Grading and runoff. Landscape design shall minimize soil erosion and runoff.
- 1. Grading plans shall avoid disruption of natural drainage patterns to the extent feasible.
- 2. Grading plans shall demonstrate that normal rainfall and irrigation will remain within the property lines and not drain onto impermeable surfaces, walkways, sidewalks, streets, alleys, gutters, or storm drains.
- 3. Plans and construction shall protect against soil compaction within landscape areas.
- 4. Stormwater best management practices to minimize runoff, to increase on-site retention and infiltration, and control pollutants shall be incorporated into project plans. Rain gardens, cisterns, swales, structural soil, permeable pavement, connected landscape areas, and other landscape features and practices that increase onsite rainwater capture, storage and infiltration, emphasizing natural approaches over technology-based approaches that require ongoing maintenance, shall be considered during project design. Plans and practices shall comply with Chapter 8.44.

D. Irrigation systems.

- 1. An automatic irrigation system using either evapotranspiration or soil moisture sensor data, with a rain shut-off sensor, shall be installed. Drip irrigation emitters shall emit no more than two (2) gallons per hour. 2. An average landscape irrigation efficiency of 0.71 shall be used for the purpose of determining Maximum Applied Water Allowance. Irrigation systems shall be designed, maintained, and managed to meet or exceed this efficiency. Landscapes using recycled water are considered Special Landscape Areas, where the ET Adjustment Factor shall not exceed 1.0.
- 3. The irrigation system shall be designed to prevent water waste resulting in runoff, overspray, or similar conditions where irrigation water ponds or flows onto non-irrigated areas, walkways, sidewalks, streets, alleys, gutters, storm drains, adjacent property, or similar untargeted areas. Runoff to other permeable or impermeable surfaces shall not be allowed.
- 4. Narrow or irregularly shaped areas, including turf less than eight (8) feet in width in any direction, shall be irrigated with subsurface irrigation or low volume above-ground irrigation system.
- 5. Overhead irrigation shall not be permitted within two (2) feet of any impermeable surface. Drip, drip line, or other low flow non-spray technology shall be used.
- 6. All sprinklers shall have matched precipitation rates within each valve and circuit. All irrigation systems shall be designed to include optimum distribution uniformity, head to head spacing, and setbacks from sidewalks, pavement and impermeable surfaces.
- 7. All irrigation systems shall provide backflow prevention devices in accordance with the current edition of the California Building/Plumbing Code and check valves at the low end of irrigation lines to prevent unwanted draining of irrigation lines. Pressure regulators may be required if the pressure at the sprinkler head exceeds the manufacturer's recommended optimal operating pressure.
- 8. Reclaimed water and graywater irrigation systems shall be used when reasonably feasible and shall conform to the current edition of the California Building/Plumbing Code, and all other applicable local, state and federal laws.
- E. Irrigation system hydrozones.
- 1. The irrigation system shall conform to the hydrozones of the landscape design plan.
- 2. Each hydrozone shall have plant materials with similar water use, with the exception of hydrozones with plants of mixed water use where the plant factor of the higher water using plant is used for calculations. No hydrozone shall mix high and low water use plants.
- 3. Sprinkler heads and other emission devices shall be appropriate for the plant type within that hydrozone.
- Where feasible, trees shall be placed on separate valves from turf, shrubs and groundcovers. 4. No landscape plan or restriction of any type, including those applicable to common interest developments such as condominiums, shall prohibit or include conditions that have the effect of prohibiting native or water
- conserving plants. F. Landscape and irrigation maintenance.
- 1. All landscape and related elements shall be designed and properly maintained to insure long-term health and shall maintain conformance with the requirements of this Chapter.
- 2. Irrigation scheduling shall be regulated by automatic irrigation controllers. 3. Watering hours and duration shall be scheduled compliant with the requirements of Chapter 8.56.
- 4. A regular maintenance schedule shall include, but not be limited to, routine inspection, adjustment and repair of the irrigation system, aerating and dethatching turf areas, replenishing mulch, fertilizing, pruning, weeding and removing any obstruction to emission devices.
- 5. Repair of all irrigation equipment shall be promptly undertaken, using the originally installed components, or equivalent or enhanced components compatible with the irrigation system.
- 6. Landscape areas shall be permanently maintained and kept free of weeds, debris and litter; plant materials shall be maintained in a healthy growing condition and diseased or dead plant materials shall be replaced, in kind, pursuant to the approved plans within thirty (30) days. Alternatively, diseased or dead plant materials may be replaced with plant materials that have low water needs, as rated in the current edition of the Water Use Classification of Landscape Species.

Centeno's Landscaping Co. Inc.

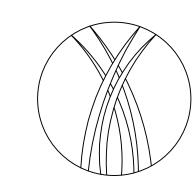

0.310.768.4089 f.310.719.7147 info@centenos-inc.com

HC R

Revision	Date	Ву
	09-8-18	
	10-26-18	
	03-25-19	
	05-26-19	

Date: 07-28-18

Scale: Drawn by: JC

PUBLIC WORKS STANDARD NOTES

GENERAL CONSTRUCTION NOTES:

- 1. CONSTRUCTION WORK HOURS ARE LIMITED TO 8:00 AM TO 6:00 PM, MONDAY THROUGH FRIDAY. WORK PROHIBITED ON SATURDAYS, SUNDAYS AND NATIONAL HOLIDAYS.
- 2. ALL WORK SHALL BE DONE IN ACCORDANCE WITH THESE PLANS, THE LATEST EDITION OF THE STANDARD SPECIFICATIONS FOR PUBLIC WORKS CONSTRUCTION ("GREENBOOK"). AND CITY OF HERMOSA BEACH PUBLIC WORKS STANDARD PLANS
- 3. ALL WORK DONE WITHIN THE PUBLIC RIGHT-OF-WAY SHALL BE DONE BY A LICENSED CONTRACTOR WITH A CLASS A; C-8 OR C-12 LICENSE FOR ALL SIDEWALK, CURB AND GUTTER; C-12 LICENSE FOR ALL STREET PAVEMENT WORK: AND CLASS C-34 LICENSE FOR UTILITY WORK SUCH AS SEWER LATERAL. SEWER CAP AND UNDERGROUND UTILITY WORK IN CONJUNCTION WITH A SINGLE FAMILY RESIDENTIAL STRUCTURE.
- 4. IT SHALL BE THE CONTRACTOR'S RESPONSIBILITY TO OBTAIN ALL NECESSARY PERMITS. PUBLIC WORKS TEMPORARY RIGHT-OF-WAY PERMITS ARE REQUIRED FOR ANY SCAFFOLDING, UTILITY TRENCHING, LUMBER DROPS, CRANES, DUMPSTERS, ETC ON PUBLIC PROPERTY. THE PUBLIC WORKS PERMIT MUST BE ON THE JOB SITE AND AVAILABLE FOR REVIEW BY CITY OFFICIALS AT ALL TIMES. IF ANY WORK HAS BEGUN BEFORE OBTAINING A PERMIT, THE JOB WILL BE STOPPED UNTIL THE PERMIT IS OBTAINED.
- 5. ALL CONTRACTORS WORKING ON PUBLIC WORKS PROJECTS MUST HAVE A CURRENT CITY OF HERMOSA BEACH BUSINESS LICENSE.
- 6. THE CONTRACTOR SHALL CALL IN A LOCATION REQUEST TO UNDERGROUND SERVICE ALERT (USA) AT (800) 227-2600 TWO WORKING DAYS BEFORE PERFORMING ANY DIGGING. SECTION 4216/4217 OF THE GOVERNMENT CODE REQUIRES THAT A DIGALERT IDENTIFICATION NUMBER BE ISSUED BEFORE A "PERMIT TO EXCAVATE" WILL BE VALID.
- 7. ALL EXCAVATIONS SHALL BE BACKFILLED AT THE END OF EACH WORKING DAY AND ROADS OPENED TO VEHICULAR TRAFFIC UNLESS OTHERWISE APPROVED BY THE CITY ENGINEER.
- 8. CONTACT PUBLIC WORKS FOR INSPECTION AT LEAST 24 HOURS IN ADVANCE INSPECTIONS ARE AVAILABLE MONDAY THROUGH FRIDAY, 8:30 A.M. TO 12:00 A.M. AND 1:00 P.M. TO 4:30 P.M.: OFFICE COUNTER ASSISTANCE IS AVAILABLE FROM 7:00 A.M. TO 8:30 A.M. AND 4:30 P.M. TO 6:00
- 9. ALL FORMS AND COMPACTION SHALL BE INSPECTED PRIOR TO ANY CONCRETE POUR OR ASPHALT BEING PLACED.
- 10. ALL SURVEY POINTS AND MONUMENTS SHALL BE PROTECTED IN PLACE OR RE-ESTABLISHED IF THEY ARE REMOVED OR DESTROYED DURING CONSTRUCTION.
- 11. THE CONTRACTOR IS RESPONSIBLE FOR EROSION CONTROL, DUST CONTROL, AND TEMPORARY DRAINAGE CONTROL AT ALL TIMES.
- 12. ALL CONSTRUCTION TO BE IN CONFORMANCE WITH THE REGULATIONS OF CAL-OSHA.

GENERAL NOTES FOR STREET AND STORM DRAIN IMPROVEMENTS:

- 1. ALL STREET CLOSURES REQUIRE A TRAFFIC CONTROL PLAN TO BE REVIEWED AND APPROVED BY THE CITY ENGINEER PRIOR TO CONSTRUCTION. ALL TRAFFIC CONTROL SHALL BE PER THE WORK AREA TRAFFIC CONTROL HANDBOOK (WATCH) MANUAL. STREET CLOSURES APPROVED BY THE CITY ENGINEER WILL REQUIRE A MINIMUM OF 48 HOUR NOTICE TO BE POSTED AND DISTRIBUTED WITH PROPER DOOR-HANGERS TO ALL RESIDENCES ON SAME BLOCK. THE CONTRACTOR SHALL ALSO NOTIFY THE DISPATCH CENTER FOR HERMOSA BEACH POLICE AND FIRE DEPARTMENTS AT (310) 524-2750 OF ANY CLOSURES OR RESTRICTIONS IN ACCESS.
- GRAFFITI IN FRESHLY POURED CONCRETE SHALL BE REMOVED BY WHATEVER MEANS NECESSARY UP TO AND INCLUDING REMOVAL AND REPLACEMENT.
- 3. ANY ASPHALT OR CONCRETE PAVEMENT WITHIN THE PROPERTY LIMITS THAT IS DAMAGED PRIOR TO CONSTRUCTION SHALL BE REMOVED AND REPLACED TO MEET CURRENT CITY STANDARDS.
- 4. ANY PUBLIC PROPERTY DAMAGED DURING CONSTRUCTION SHALL BE REPLACED IN KIND OR BETTER TO THE SATISFACTION OF THE CITY PUBLIC WORKS INSPECTOR. THE CITY SHALL AT ITS DISCRETION, AND IN THE INTEREST OF PUBLIC SAFETY, MAKE ANY REPAIRS DEEMED NECESSARY; THE COST OF WHICH WILL BE DEDUCTED FROM THE DEPOSIT HELD BY THE CITY.
- 5. ALL EXISTING PAVEMENT TO BE REMOVED SHALL BE SAW-CUT OR WHEEL-CUT AND REMOVED TO CLEAN STRAIGHT LINES.
- 6. AT ALL LOCATIONS WHERE NEW PAVEMENT JOINS EXISTING, THE EXISTING PAVEMENT SHALL BE COATED WITH AN ASPHALTIC EMULSION.

GENERAL NOTES FOR SEWER AND UTILITY IMPROVEMENTS:

- SEPARATION OF SEWER AND WATER FACILITIES SHALL BE IN CONFORMANCE WITH LATEST EDITION OF THE STATE OF CALIFORNIA DEPT OF HEALTH SERVICES.
- 2. SEWER LATERALS SHALL BE CONNECTED TO THE SEWER MAIN WITH WYES.
- 3. THE SEWER LINE SHALL BE TESTED PRIOR TO MAKING PERMANENT SERVICE CONNECTIONS.
- 4. BACKFILL OF TRENCHES SHALL BE DONE IN LIFTS OF NO MORE THAN 8-INCHES WITH WATER AND APPROPRIATE COMPACTION TOOLS USED BETWEEN EACH LIFT. ONE SACK SLURRY MIX CAN BE USED IN PLACE OF NATIVE SOIL. AFTER BACKFILLING THE TRENCH, A TEMPORARY ASPHALT PATCH SHALL BE PLACED OVER THE TRENCH AND REMAIN FOR NO MORE THAN TWO WEEKS. THE FINAL PATCH SHALL BE A MINIMUM OF 5" THICK OR 1" THICKER THAN THE EXISTING PAVEMENT. THE CONTRACTOR SHALL FOLLOW THE LATEST HERMOSA BEACH STANDARD PLANS FOR AC AND P.C.C. PAVEMENT.
- 5. THE FINAL PATCH IN ASPHALT STREETS SHALL BE DONE IN TWO LIFTS, A BASE OF 3" MINIMUM 3/4" AGGREGATE AND A TOP LIFT OF 2" OF 3/8" AGGREGATE. ALL EDGES OF THE CUT ASPHALT TO BE TACKED THOROUGHLY AND THE PATCH COMPACTED BY MECHANICAL MEANS TO A HEIGHT SLIGHTLY HIGHER THAN THE EXISTING ASPHALT AND ALL EDGES TO BE TACKLE
- 6. THE FINAL PATCH ON CONCRETE STREETS TO BE CLASS 3500 P.S.I (7 SACK), EXISTING CONCRETE TO BE DRILLED TWO AND ONE HALF INCHES (2 1/2") BELOW THE SURFACE TO A DEPTH OF 6" MINIMUM AND DOWELLED WITH #5 REBAR ON 18" SPACING. FINISH TO MATCH EXISTING OR MEDIUM BROOM.
- 7. ALL UTILITY BOXES ARE TO BE ADJUSTED TO THE NEW GRADE. DAMAGED BOXES SHALL BE REPLACED. KEEP ALL UTILITY BOXES OUT OF DRAINAGE FLOW LINES, CURB RETURNS, DRIVEWAY APPROACH AND WHEEL CHAIR RAMPS, UNLESS APPROVED BY THE CITY ENGINEER.

JOB SAFETY REQUIREMENTS:

- 1. PROPER BARRICADES SHALL BE PLACED AROUND ANY CONSTRUCTION SITE WITHIN THE PUBLIC RIGHT-OF-WAY. THESE BARRICADES SHALL COMPLY WITH THE REQUIREMENTS OF THE WORK AREA TRAFFIC CONTROL HANDBOOK (WATCH) MANUAL.
- 2. ALL CONSTRUCTION FENCING SHALL BE BEHIND THE SIDEWALK AND ALL CONSTRUCTION MATERIAL WITHOUT PERMITS ARE TO BE BEHIND THE FENCE. SIDEWALKS ARE TO BE ACCESSIBLE TO PEDESTRIANS AT ALL TIMES.
- 3. NO CONSTRUCTION EQUIPMENT. CONSTRUCTION MATERIAL. PORTABLE TOILETS. DUMPSTERS. ETC. SHALL BE LEFT ON THE PUBLIC RIGHT-OF-WAY WITHOUT PROPER PERMITS. THESE OBSTRUCTIONS MUST HAVE PROPER BARRICADES WITH FLASHING YELLOW LIGHTS AFTER DARK
- 4. ANY PUBLIC SIDEWALK DAMAGED TO THE POINT OF CAUSING A TRIP HAZARD MUST BE REPAIRED IMMEDIATELY. THE PANEL OF CONCRETE SHALL BE REMOVED AND PATCHED WITH A TEMPORARY ASPHALT PATCH AND MUST BE KEPT IN GOOD REPAIR UNTIL THE PERMANENT SIDEWALK IS CONSTRUCTED.
- 5. ALL VEHICLES THAT INTRUDE INTO A NORMAL TRAFFIC LANE MUST HAVE PROPER SIGNAGE AND BARRICADES AS REQUIRED BY THE (WATCH) MANUAL.
- 6. ALL WORK VEHICLES ARE SUBJECT TO ALL APPLICABLE PARKING RESTRICTIONS.
- 7. FLAGMEN ARE REQUIRED FOR ANY VEHICLES THAT BLOCK THE TRAVEL LANE AND REQUIRE TRAFFIC TO USE THE OPPOSING LANE TO PASS.

WATER QUALITY REQUIREMENTS:

- 1. 1PRECAUTIONS SHALL BE TAKEN TO PREVENT ANY CONSTRUCTION MATERIAL DEBRIS OR RUNOFF FROM ENTERING ANY PUBLIC RIGHT-OF-WAY OR COUNTY STORM DRAIN. ALL SAW CUT RESIDUE MUST BE RETAINED WITH BERMS OR SANDBAGS AND VACUUMED TO PREVENT IT FROM ENTERING INTO ANY STORM DRAIN SYSTEM.
- 2. SANDBAGS ARE REQUIRED FOR EROSION CONTROL DURING THE RAINY SEASON, OCTOBER 15TH THROUGH APRIL 15TH, AND MAY BE REQUIRED AT OTHER TIMES. SANDBAGS ARE REQUIRED AT NEARBY CATCH BASINS DURING CONSTRUCTION. SANDBAGS SHALL BE MAINTAINED AND IN GOOD CONDITION AT ALL
- 3. MAKE SURE BROKEN PAVEMENT DOES NOT COME IN CONTACT WITH RAINFALL OR RUNOFF.
- 4. SHOVEL OR VACUUM SAW-CUT SLURRY AND REMOVE FROM THE SITE. FOR DISPOSAL INFORMATION CONTACT THE L.A. COUNTY DEPARTMENT OF PUBLIC WORKS AT 800-552-5218.
- 5. COVER OR BARRICADE STORM DRAIN OPENINGS DURING SAW-CUTTING.
- 6. DURING CONSTRUCTION:
- PROTECT CATCH BASINS AND MAINTENANCE HOLES WHEN APPLYING SEAL COAT, SLURRY SEAL, FOG
- SEAL, ETC. USE CHECK DAMS, DITCHES OR BERMS TO DIVERT RUNOFF AROUND EXCAVATIONS.
- COLLECT AND RECYCLE EXCESS ABRASIVE GRAVEL OR SAND.
- AVOID OVER-APPLICATION BY WATER TRUCKS FOR DUST CONTROL
- NEVER HOSE DOWN "DIRTY" PAVEMENT OR SURFACES. CLEAN UP ALL SPILLS AND LEAKS USING "DRY" METHODS (WITH ABSORBENT MATERIALS AND /OR RAGES), OR DIG UP AND REMOVE CONTAMINATED SOIL. FOR DISPOSAL INFORMATION CALL (800) 552-5218.
- CATCH DRIPS FROM PAVER WITH DRIP PANS OR ABSORBENT MATERIAL (CLOTH, RAGS, ETC.) PLACED UNDER MACHINE WHEN NOT IN USE.

PROJECT DESCRIPTION:

- DEMOLISH EXISTING HOUSE.
- 2. CONSTRUCT NEW TWO THREE-STORY SINGLE FAMILY RESIDENCE, EACH WITH AN ATTACHED 2-CAR GARAGE.

GRADING NOTES:

- HAUL ROUTE MUST BE APPROVED BY ENGINEERING SERVICES. SEE CITY'S APPROVED ROUTE ON VICINITY MAP HEREON.
- 2. OFFSITE GRADING APPROVAL MUST BE OBTAINED IN WRITING.
- 3. BORROW OR DISPOSAL SITE MUST BE PERMITTED & BONDED (IF WITHIN CITY) AND PERMITTED.

DRAINAGE NOTE

PROVISIONS FOR CONTRIBUTORY DRAINAGE SHALL BE MADE AT ALL TIMES.


PROJECT CUBIC	YARDAGE DATA
TOTAL CUT SOILS:	500 CUBIC YARDS ±
TOTAL FILL SOILS:	O CUBIC YARDS ±
TOTAL EXPORT SOILS:	O CUBIC YARDS ±
TOTAL IMPORT SOILS:	O CUBIC YARDS ±

1. CONTRACTOR IS RESPONSIBLE FOR COMPLETING HIS OWN CUT AND FILL CALCULATIONS. VOLUMES SHOWN ARE FOR OWNERS PLANNING PURPOSES ONLY AND NO GUARANTEE IS EXPRESSED OR IMPLIED REGARDING THEIR ACCURACY.


OWNER'S INFORMATION

GENE CHENG 21143 HAWTHORNE BLVD., TORRANCE CA, 90503 GENE.CHENG@BAWAGPSK.COM

REGIONAL MAP

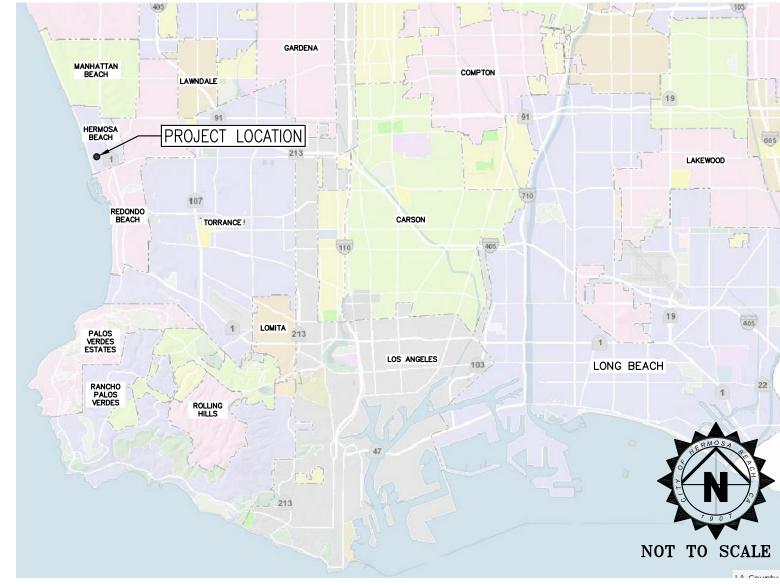

VICINITY MAP

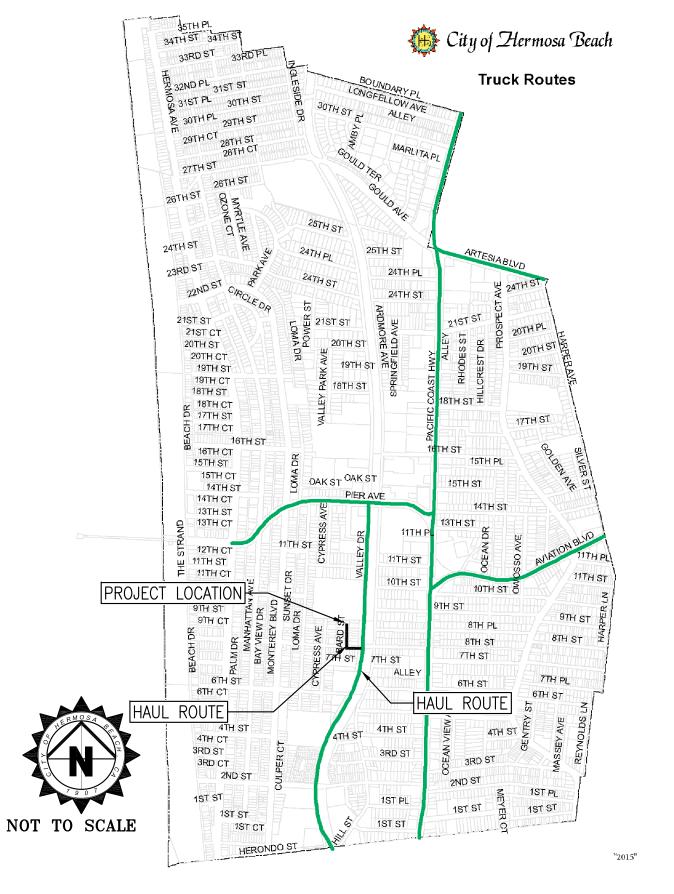

CONSULTANT LIST:

PEHA & ASSOCIATES 67 14TH STREET, HERMOSA BEACH, CA 90254 PH: (310) 376-6837

PACIFIC LAND CONSULTANTS, INC. 28441 HIGHRIDGE RD, SUITE 230 ROLLING HILLS ESTATES, CA,90274 PH: (310) 544-8689

SOIL AND GEOTECHNICAL CONSULTANS NORCAL ENGINEERING 10641 HUMBOLT STREET, LOS ALAMITOS, CA 90720 PH: (562) 799-9469

<u>CIVIL ENGINEER</u> PERU CONSULTANTS, LLP 1976 W 234TH STREET, TORRANCE, CA 90501 PH: (310) 270-0811

DATE

SHEET INDEX

TITLE SHEET C-0SITE PLAN C-1 DETAILS C-2

DRIVEWAY PROFILE AND SECTIONS C-3

EROSION CONTROL PLAN

PROPERTY INFORMATION:

APN: 4187-014-043

LOT# 2, BLOCK#

TRACT NO.: 2002

LATITUDE & LONGITUDE: 33°51'38.5"N, 118°23'42.9"W

PROPERTY TYPE: RESIDENTIAL

LOT SIZE: 3,299 SF

SITE ADDRESS: 847 BARD STREET, HERMOSA BEACH, CA 90254

LID INFORMATION

SOIL INFILTRATION RATE: 88 IN/HR

SOIL TYPE: SILTY SAND

BMP TYPE: INFILTRATION PIT TOTAL DRAINAGE AREA (ACRES): 0.075 ACRES

IMPERVIOUS AREA: 2,359 SF

PERVIOUS AREA: 940 SF PDESIGN: 0.80 IN

CATCHMENT AREA (SF) = IMPERVIOUS AREA (SF)*0.9 + PERVIOUS AREA (SF)*0.1

SWQDV (CF) = CATCHMENT AREA (SF)*PDESIGN*0.083(FT/IN)

CATCHMENT AREA (SF) = 2,217 SFSWQDV (CF) = 147 CF

TREATMENT VOLUME (CUBIC FEET): 7,741 CF

STORM WATER QUALITY DESIGN VOLUME (CUBIC FEET): 147 CF

LEGEND:

	<u> </u>		
	CATCH BASIN WITH FILTER INSERT	<u>ABI</u>	BREVIATIONS
<u>ss</u>	4" DIA. PVC SDR-35 SANITARY SEWER PIPE	BOTT. DS	BOTTOM OF BASIN ELEVATION. DOWNSPOUT
	4" DIA. PVC SCH 40 PERFORATED PIPE	(E) ELE.	EXISTING ELEVATION
GB	GRADE BREAK	EM FF	ELECTRICAL METER FINISH FLOOR
	LIMIT OF NEW PAVING	FL FS	FLOW LINE FINISH SURFACE
•	POINT OF CONNECTION	FG GM GTEPB	FINISH GRADE GAS METER GTE PULLBOX
v	GRASS/LANDSCAPE SURFACE	GB H HP	GRADE BREAK HEIGHT HIGH POINT
а	CONCRETE PAVING SURFACE	INV PC	INVERT ELEVATION PROPERTY CORNER
	GRAVEL SURFACE	P.O.C PP	POINT OF CONNECTION POWER POLE
	PERMEABLE PAVING SURFACE	RIM SD TC	RIM ELEVATION STORM DRAIN TOP OF CURB
79.50 FS	PROPOSED ELEVATION	TF TG TVPB	TOP OF FOOTING TOP OF GRATE
(79.50)FS	EXISTING ELEVATION	TW	TELEVISION PULL BOX TOP OF WALL

BENCH MARK:

TEMPORARY BENCHMARK TO BE MANHOLE RIM ELEVATION.


ELEV. = 98.53 FEET

SEE KEYNOTE (2) ON C-1.



		No.	DESCRIPTION	DATE
			1ST SUBMITTAL	04/30/19
E				
00) DAYS				
ig RNIA				
	Í			



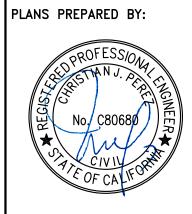

PLANS	PREPARED BY:
REGISTES	No. C80680 NEER No. C80680 REER ATE OF CALIFORNIA

CHRISTIAN J. PEREZ, RCE LICENSE No. 80680

D BY:	CITY OF HERMOSA BEACH PUBLIC WORKS DEPARTMENT
0680 REFR	RECOMMENDED FOR PERMIT ISSUANCE:

04/30/2019

DATE

847 BARD STREET CIVIL PLANS

PRIVATE IMPROVEMENT PLANS


TITLE SHEET


1 OF 5

FILE NUMBER

19036-CIVII

TYPICAL TOP OF TANK

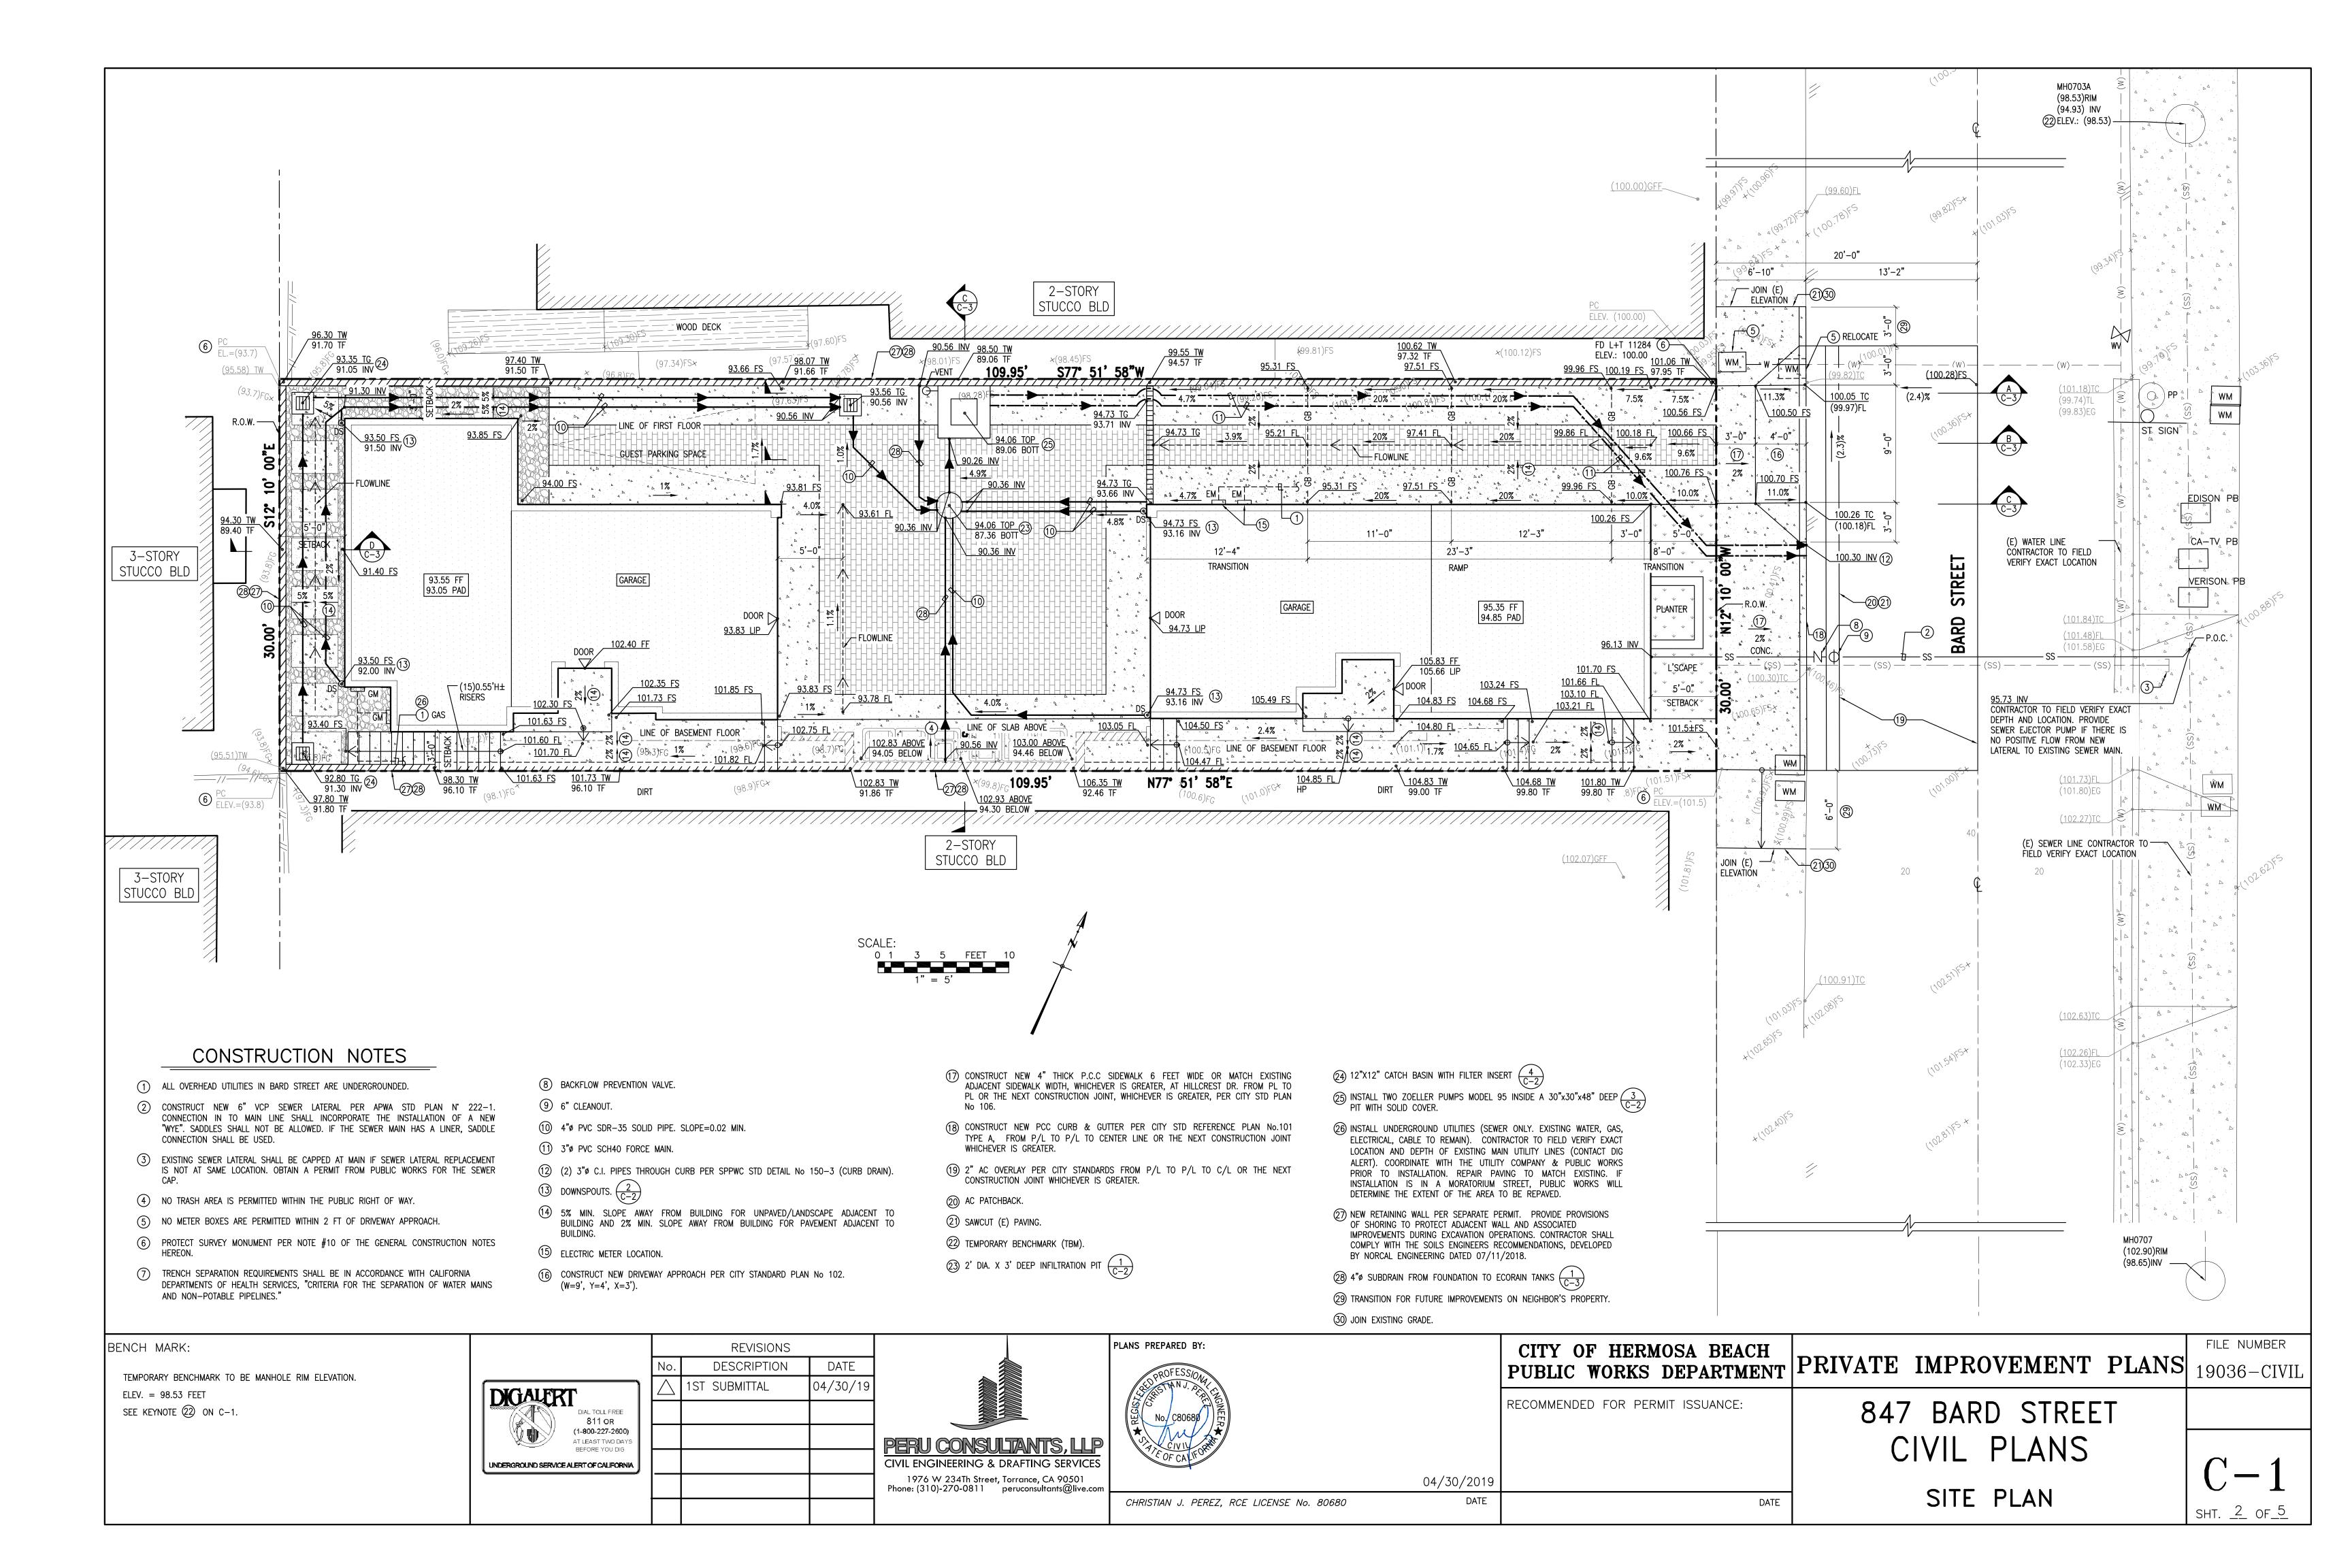

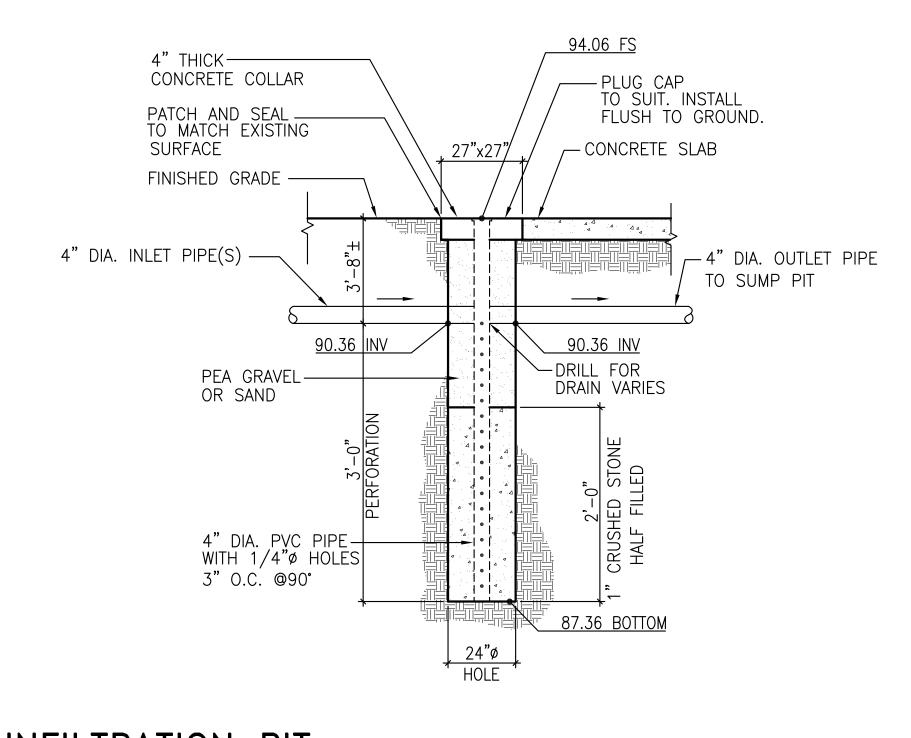

INFILTRATION PIT

— DOWNSPOUT

INVERT ELEVATION


SEE DRAWING C-1


— CONCRETE PAVEMENT

- UNDERGROUND DRAIN PIPE

4 4 4 4 4 4

NOT TO SCALE

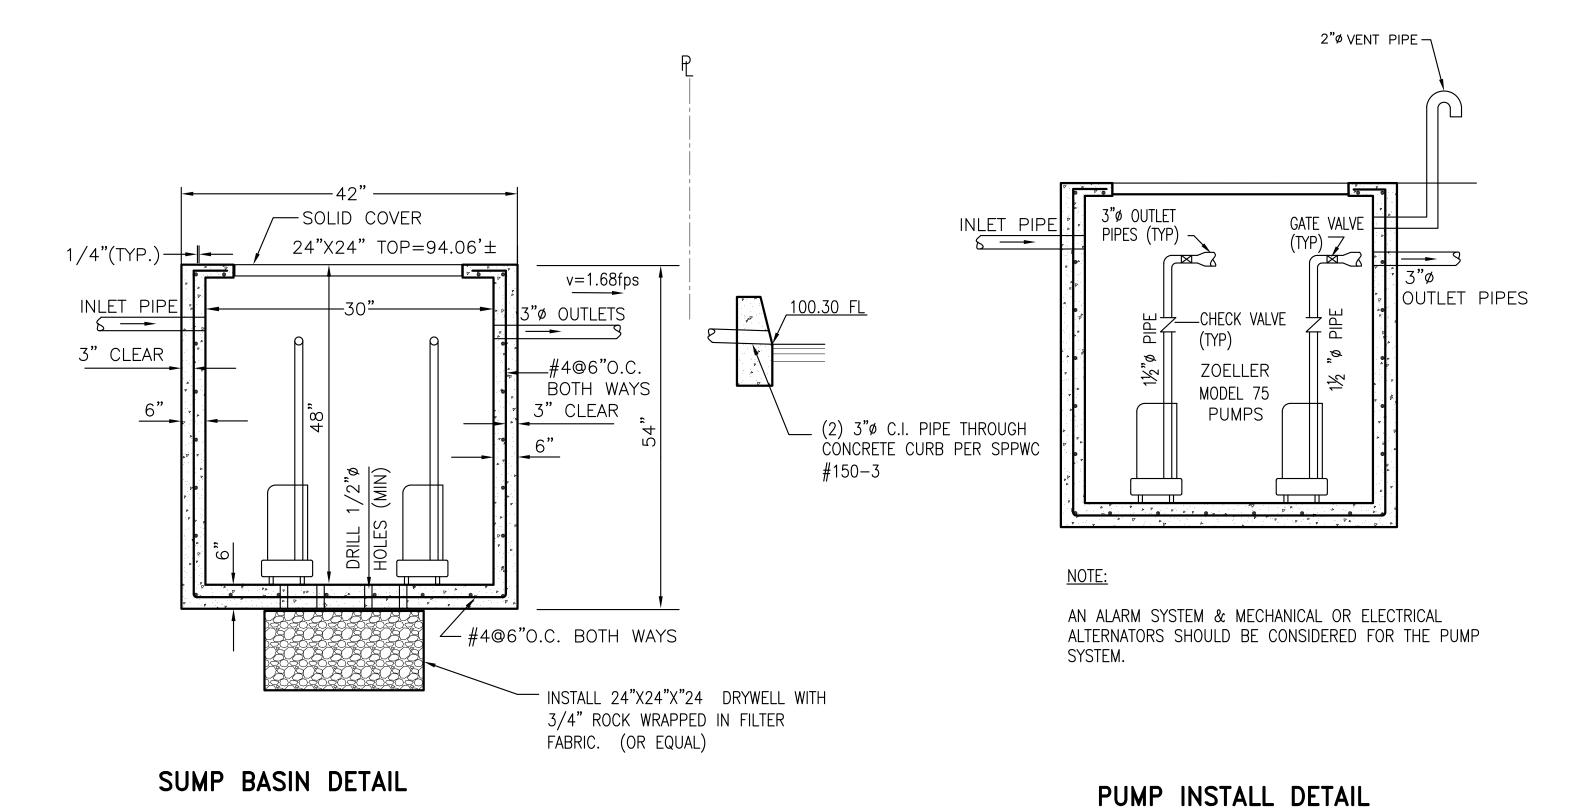

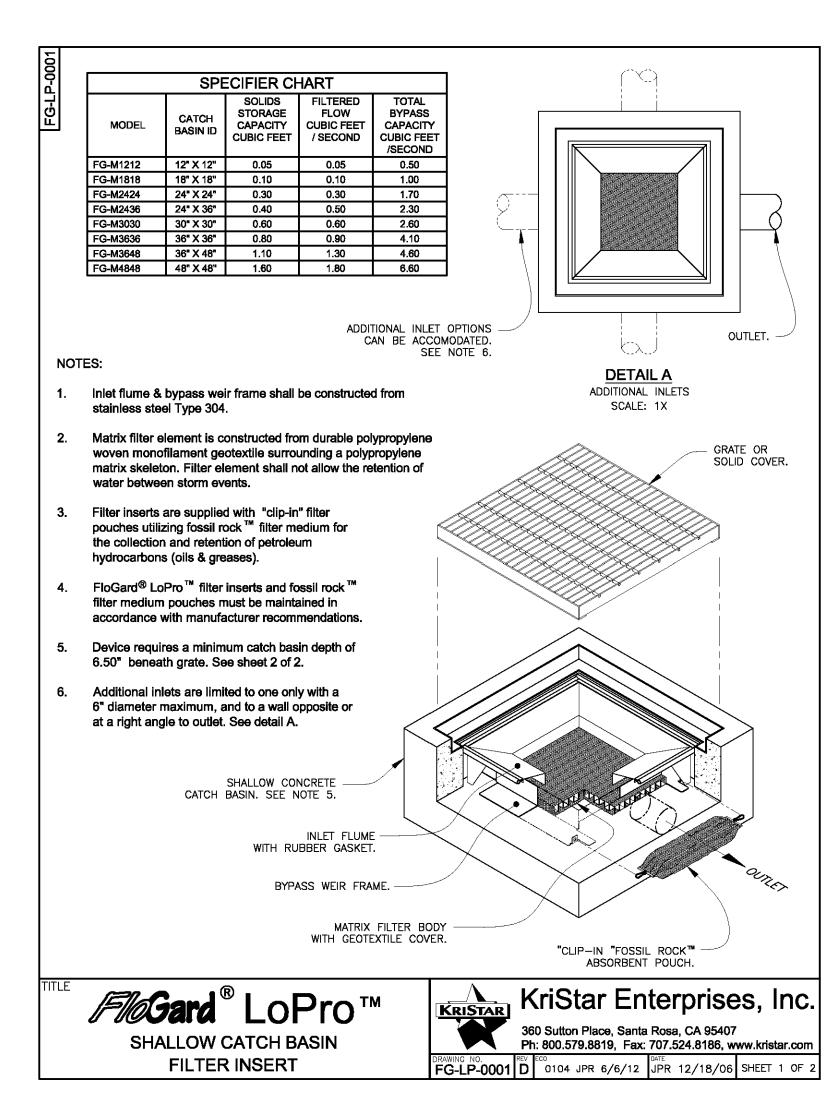

NOTE: 1. USE FG-M1212.

2. INFLOW PIPE TO CATCH BASIN FILTER IS ABOVE FILTER MEDIA TO ENSURE FLOW IS FILTERED PRIOR TO DISCHARGE INTO

DOWNSPOUT NOT TO SCALE

SUMP PUMP DETAIL

NOT TO SCALE

DATE

SHALLOW CATCH BASIN FILTER INSERT

DATE

NOT TO SCALE

FILE NUMBER

BENCH MARK:

TEMPORARY BENCHMARK TO BE MANHOLE RIM ELEVATION. ELEV. = 98.53 FEET SEE KEYNOTE 22 ON C-1.



			REVISIONS	
		No.	DESCRIPTION	DATE
ALER	T		1ST SUBMITTAL	04/30/
	DIAL TOLL FREE 811 OR			
	(1-800-227-2600) AT LEAST TWO DAYS BEFORE YOU DIG			
OUND SERVICE	ALERT OF CALIFORNIA			


19	
	PERU CONSULTANTS, LLP CIVIL ENGINEERING & DRAFTING SERVICES
	1976 W 234Th Street, Torrance, CA 90501 Phone: (310)-270-0811 peruconsultants@live.com
	Peroconsolicins@iive.com


PL	PLANS PREPARED BY:	CITY OF HERMOSA BEACH PUBLIC WORKS DEPARTMENT			
	No. C80680 No. C8	RECOMMENDED FOR PERMIT ISSUANCE:			
	04/30/2019				

CHRISTIAN J. PEREZ, RCE LICENSE No. 80680

BLIC WORKS DEPARTMENT	PRIVATE	IMPROVEMENT	PLANS	19036-CIVIL	
OMMENDED FOR PERMIT ISSUANCE:	847	BARD STREE	T		


CIVIL PLANS DETAILS

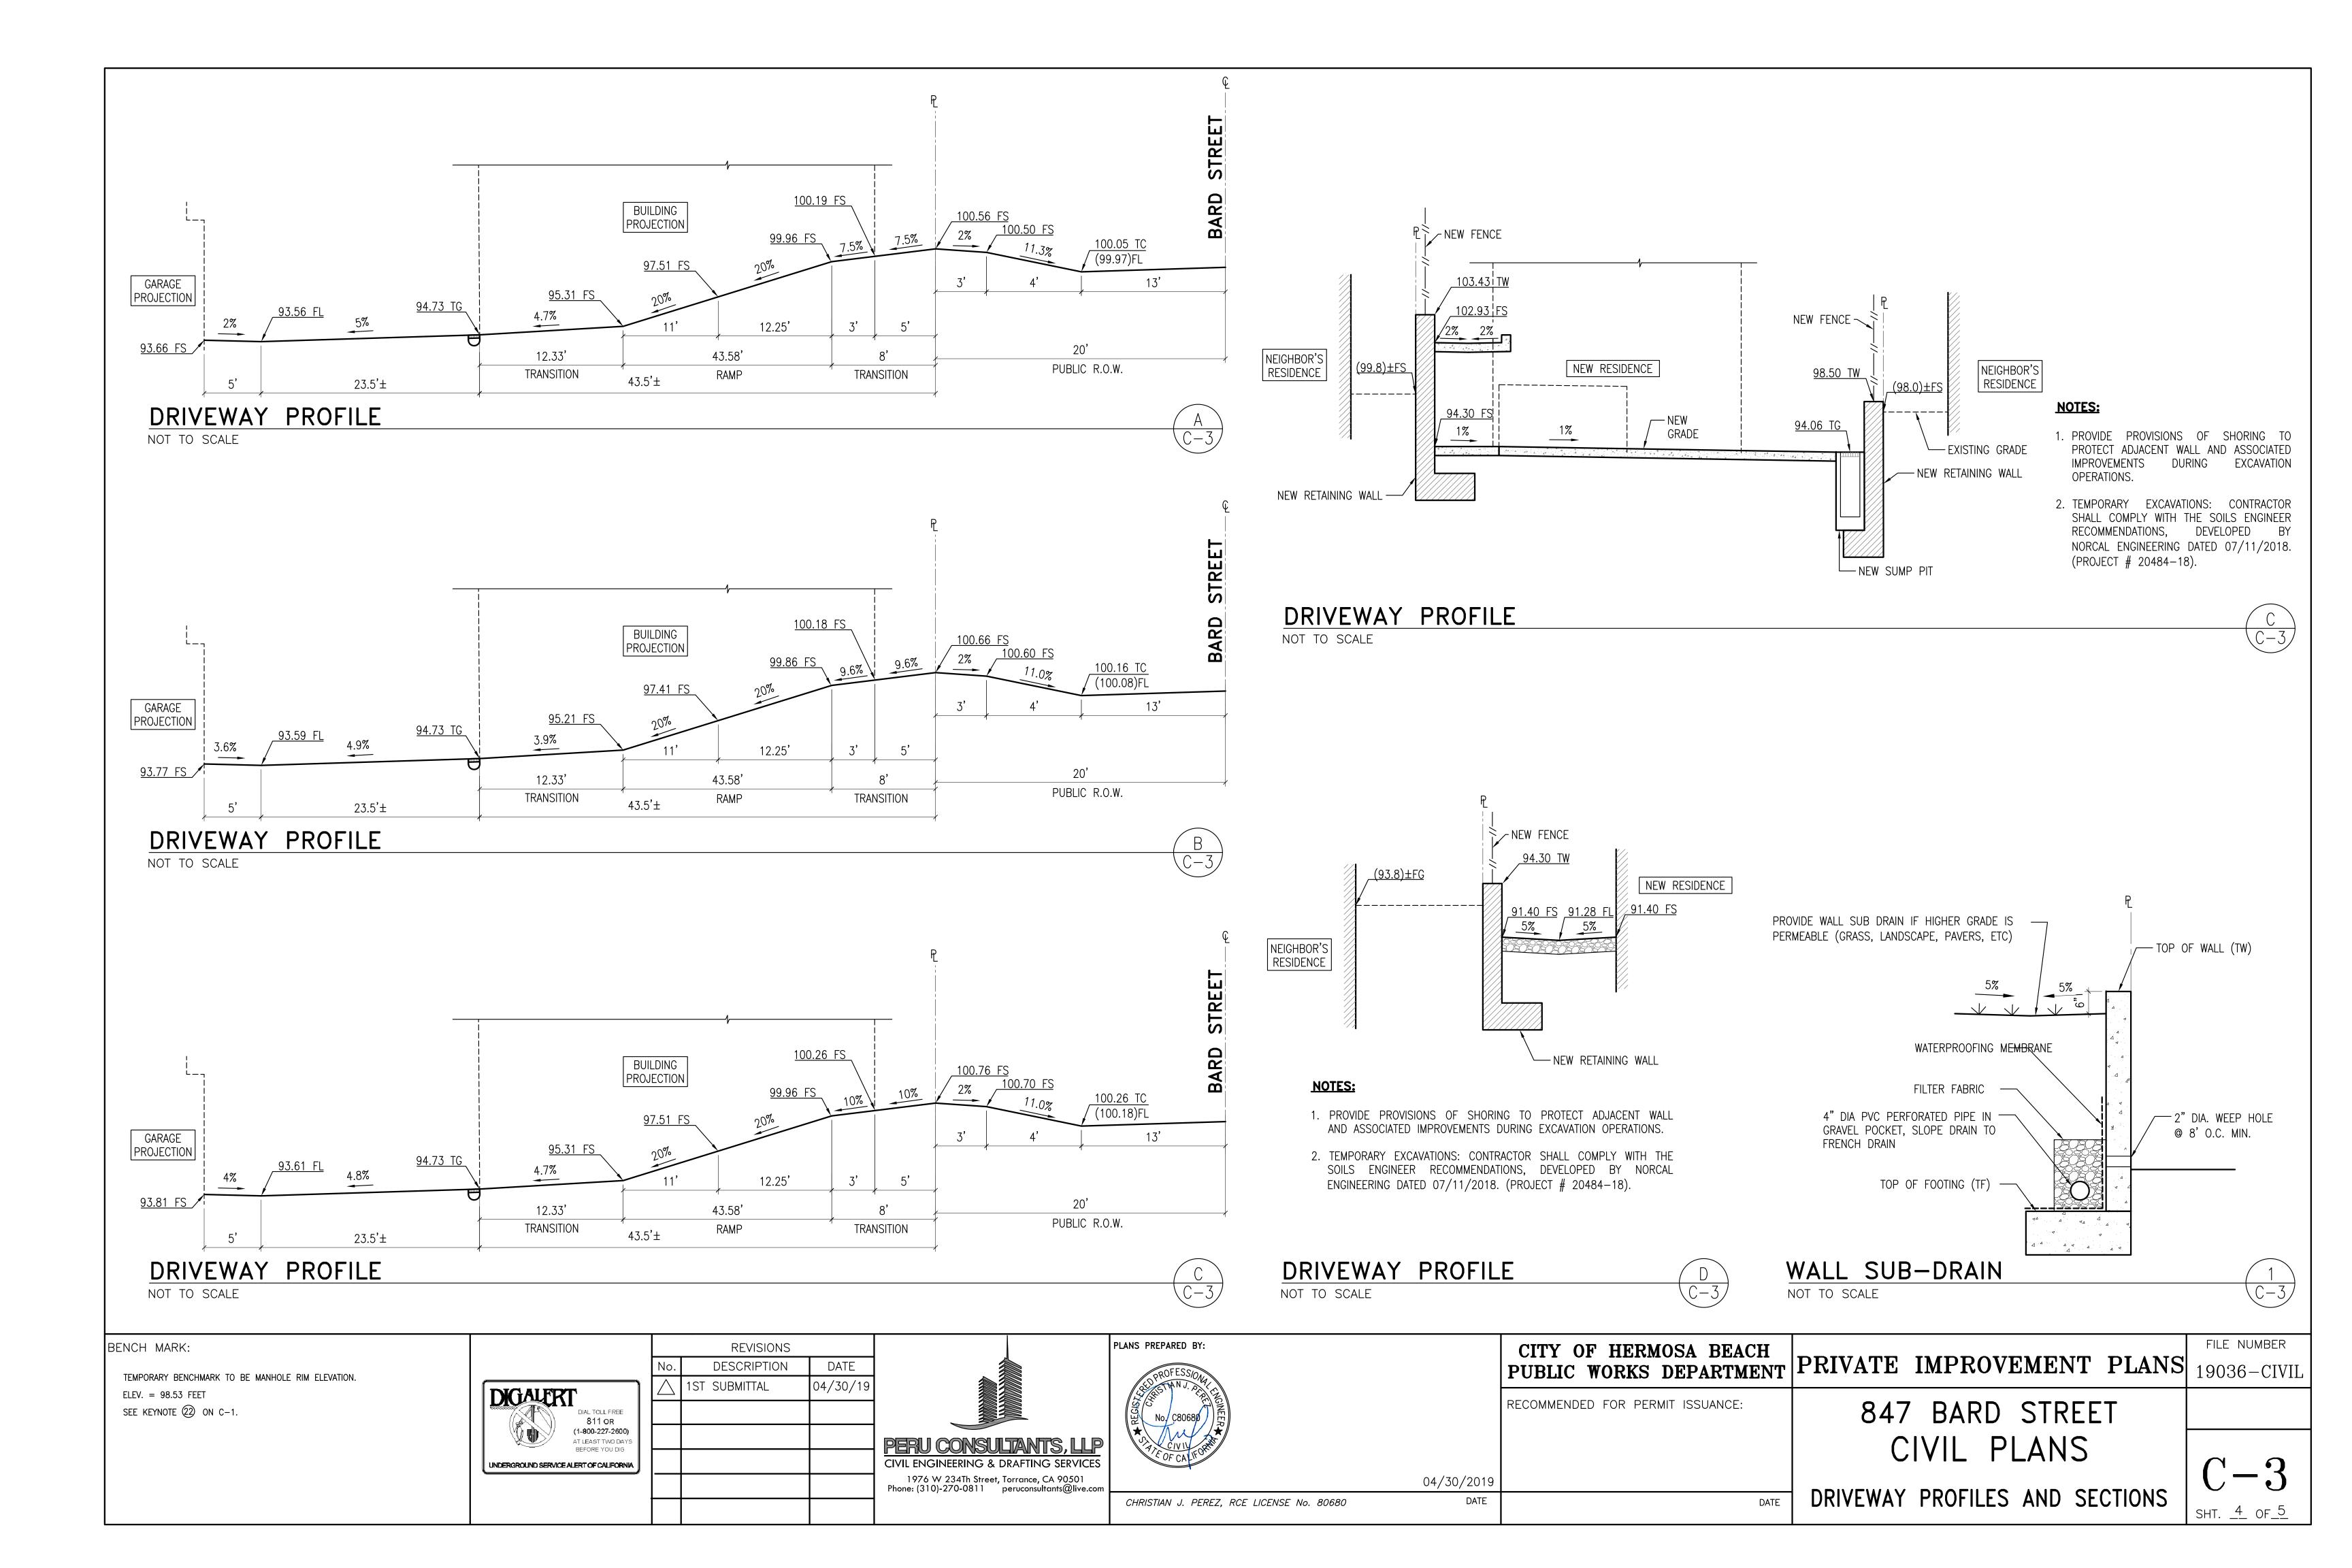


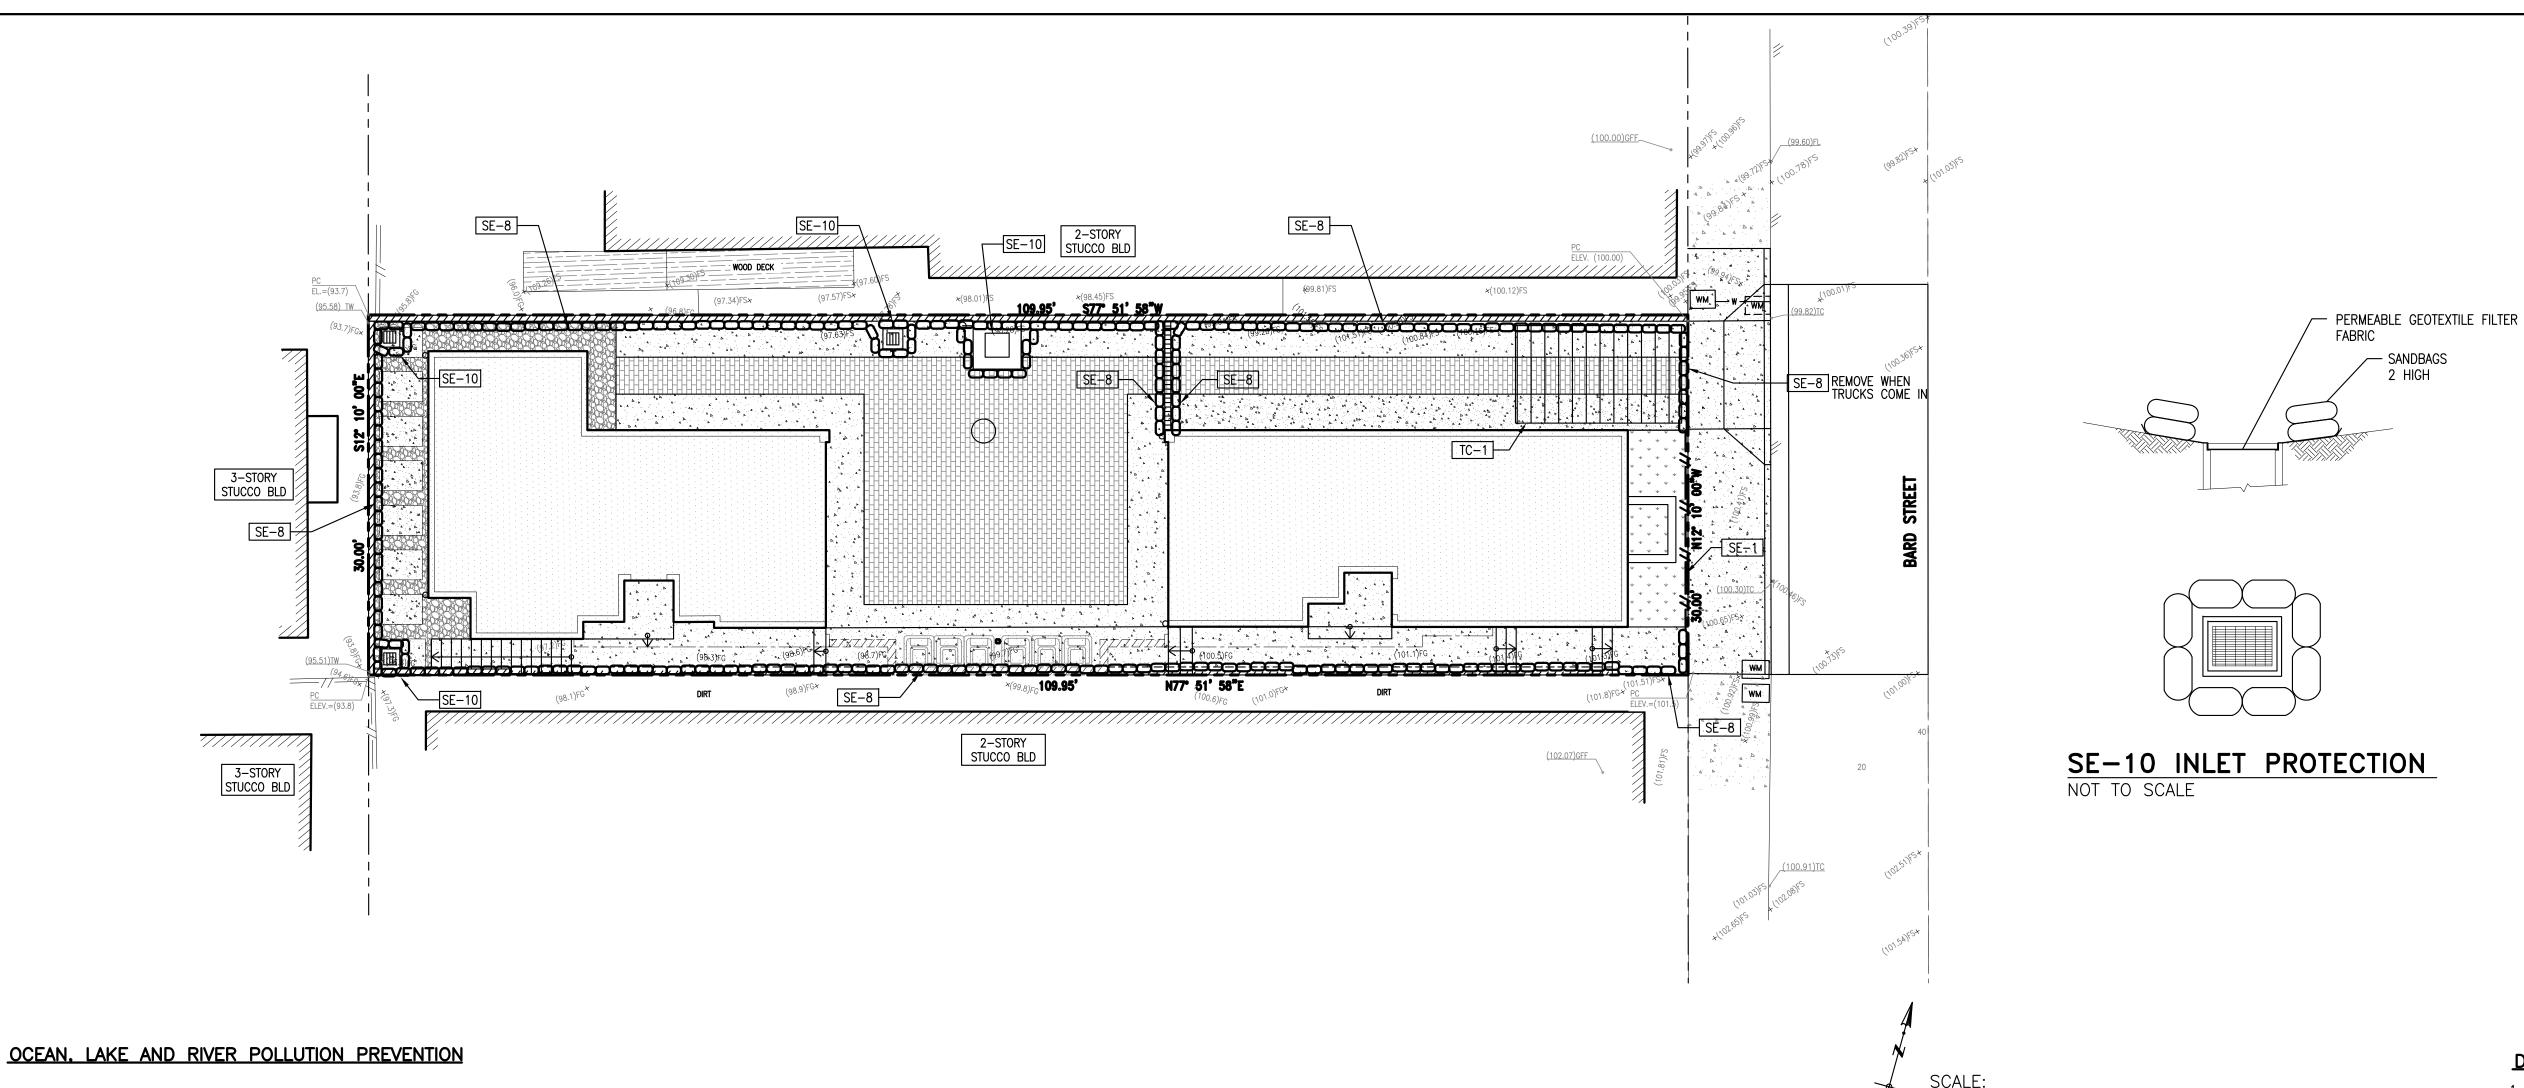

IT IS UP TO US. RAIN WATER OR URBAN RUN OFF MIXES WITH URBAN POLLUTANTS CREATES STORMWATER POLLUTION. THE POLLUTANTS INCLUDE: OIL AND OTHER AUTOMOTIVE FLUIDS, PAINT AND CONSTRUCTION DEBRIS, YARD AND PET WASTES, PESTICIDES AND LITTER. THE FOLLOWING BEST MANAGEMENT PRACTICES (BMP'S) WILL INSURE A CLEANER OCEAN AND CITY.

- 1. GENERAL BUSINESS PRACTICES
- A. KEEP MATERIALS OUT OF THE RAIN. STORE THEM UNDER COVER, WITH TEMPORARY ROOFS OR PLASTIC SHEETS, PROTECTED FROM
- RAINFALL, RUNOFF AND THE WIND. B. SCHEDULE EXCAVATION AND GRADING WORK FOR DRY WEATHER.
- C. DEVELOP AND IMPLEMENT EROSION AND SEDIMENT CONTROL PLANS FOR EMBANKMENTS.
- 2. EQUIPMENT MAINTENANCE
- A. MAINTAIN ALL VEHICLES AND HEAVY EQUIPMENT. INSPECT FREQUENTLY FOR LEAKS.
- B. CONDUCT ALL VEHICLE/EQUIPMENT MAINTENANCE AND REFUELING AT ONE LOCATION AWAY FROM STORM DRAINS. C. PERFORM MAJOR EQUIPMENT/VEHICLE REPAIRS AND WASHING WHERE IT IS PERMITTED.
- D. DO NOT USE DIESEL OIL TO LUBRICATE OR CLEAN EQUIPMENT OR PARTS.
- 3. ASPHALT AND CONCRETE REMOVAL
- A. AFTER BREAKING UP PAVING, BE SURE TO REMOVE ALL CHUNKS AND PIECES. RECYCLE THEM AT A CRUSHING COMPANY. USE
- THE REFERRAL NUMBERS LISTED BELOW. B. DISPOSE OF SMALL AMOUNTS OF DRY CONCRETE IN THE TRASH.
- C. MAKE SURE BROKEN PAVEMENT DOES NOT COME IN CONTACT WITH RAINFALL OR RUNOFF.
- D. SHOVEL OR VACUUM SAW-CUT SLURRY AND REMOVE FROM THE SITE. FOR DISPOSAL INFORMATION CONTACT THE
- L.A. COUNTY DEPARTMENT OF PUBLIC WORKS AT 800-552-5218. E. COVER OR BARRICADE STORM DRAIN OPENINGS DURING SAW-CUTTING.
- 4. ASPHALT AND CONCRETE DISPOSAL OPTIONS
- A. USE A CRUSHING COMPANY LIKE THOSE LISTED BELOW TO RECYCLE CEMENT, ASPHALT AND PORCELAIN RATHER THAN TAKING THEM
- BLUE DIAMOND, SOUTH GATE, 800-300-6120
- COPP CRUSHING, ANAHEIM, TEMECULA, CHINO AND SANTA FE SPRINGS, 310-802-2141
- RJ NOBLE, SANTA ANA, 714-637-1550
- 5. DURING CONSTRUCTION A. COVER CATCH BASINS AND MAINTENANCE HOLES WHEN APPLYING SEAL COAT, SLURRY SEAL, FOG SEAL, ETC.
- B. USE CHECK DAMS, DITCHES OR BERMS TO DIVERT RUNOFF AROUND EXCAVATIONS. C. NEVER WASH MATERIALS FROM EXPOSED AGGREGATE CONCRETE, ASPHALT, OR SIMILAR TREATMENTS INTO A STREET,
- D. GUTTER OR STORM DRAIN. COLLECT AND RECYCLE, OR LEGALLY DISPOSE OF. E. COLLECT AND RECYCLE EXCESS ABRASIVE GRAVEL OR SAND.
- F. AVOID OVER-APPLICATION BY WATER TRUCKS FOR DUST CONTROL.
- 6. SPILLS
- A. NEVER HOSE DOWN "DIRTY" PAVEMENT OR SURFACES. CLEAN UP ALL SPILLS AND LEAKS USING "DRY" METHODS (WITH ABSORBENT MATERIALS AND/OR RAGS), OR DIG UP AND REMOVE CONTAMINATED SOIL. FOR DISPOSAL INFORMATION, CALL (800)
- B. CATCH DRIPS FROM PAVER WITH DRIP PANS OR ABSORBENT MATERIAL (CLOTH, RAGS, ETC.) PLACED UNDER MACHINE WHEN NOT IN

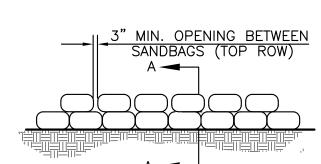


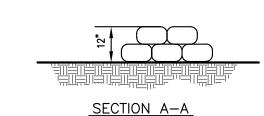

SE-8 SANDBAG BARRIER NOT TO SCALE

MATERIAL STORAGE:

- 1. DIRT AND OTHER CONSTRUCTION RELATED MATERIALS PLACED IN THE STREET OR ON OTHER IMPERVIOUS SURFACES MUST BE CONTAINED WITH SANDBAGS OR OTHER MEASURES TO PREVENT TRANSPORT TO THE STORMDRAIN SYSTEM.
- 2. ANY CONSTRUCTION MATERIAL STORED OR STOCKPILED ON-SITE SHALL BE PROTECTED FROM BEING TRANSPORTED BY THE FORCE OF WIND OR WATER.

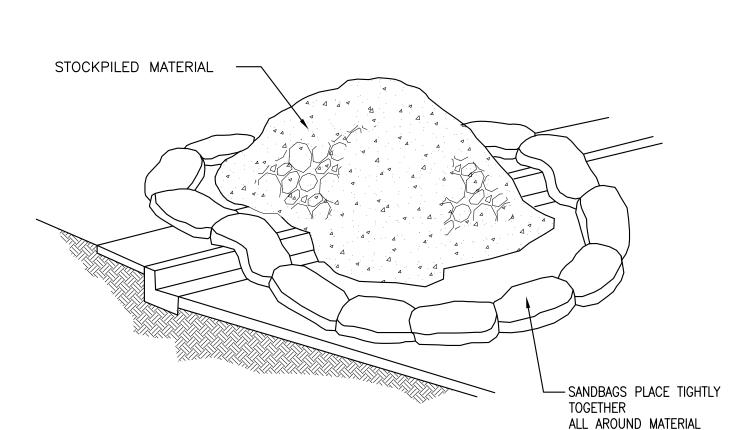

0 4 8 FEET 16

1/8" = 1'-0"

WM-3 STOCKPILE MANAGEMENT NOT TO SCALE

BMP SELECTION AND LEGEND:

BMP'S SPECIFIED ON THIS PLAN REFERENCE THE NOVEMBER 2009 EDITION OF CASQA "CALIFORNIA STORMWATER HANDBOOK". IT IS THE RESPONSIBILITY OF THE CONTRACTOR TO OBTAIN BMP DETAILS AVAILABLE AT WWW.CAQA.ORG.

THE FOLLOWING BMP'S ARE NOT SHOWN IN SPECIFIC LOCATIONS ON THIS PLAN AND ARE APPLICABLE TO THE PROJECT. THE CONTRACTOR SHALL INCORPORATE THESE BMP'S INTO THE PROJECT SCOPE:

PROJECT SCHEDULE

PRESERVATION OF EXISTING VEGETATION

PAVING AND GRINDING

WATER CONSERVATION

DISCHARGE REPORTING

POTABLE WATER/IRRIGATION

VEHICLE CLEANING

VEHICLE FUELING

VEHICLE MAINTENANCE WIND EROSION CONTROL

THE FOLLOWING BMP'S ARE SPECIFIED ON THIS PLAN:

SANDBAG BARRIER

INLET PROTECTION

STABILIZED CONSTRUCTION ENTRANCE/EXIT

THE FOLLOWING BMP'S SHALL BE USED IN THE CONTRACTOR STAGING AREA:

MATERIAL STORAGE

MATERIAL USAGE

STORAGE MANAGEMENT

SPILL PREVENTION KIT

SOLID WASTE (TRASH)

CONCRETE WASTE (WASHOUT)

DEWATERING NOTES:

1. UTILIZE APPROPRIATE DEWATERING SYSTEMS AND TECHNIQUES TO MAINTAIN THE EXCAVATED AREA SUFFICIENTLY DRY FROM GROUNDWATER AND/OR SURFACE RUNOFF SO AS NOT TO ADVERSELY AFFECT CONSTRUCTION PROCEDURÉS OR CAUSE EXCESSIVE DISTURBANCE OF UNDERLYING NATURAL GROUND.

SEPTIC/SANITARY FACILITIES

- 2. PROVIDE AND STORE AUXILIARY DEWATERING EQUIPMENT ON THE SITE IN THE EVENT OF BREAKDOWN. PROVIDE NON-WOVEN FILTER FABRIC WHERE REQUIRED FOR UNDERDRAIN SYSTEMS. THE NON-WOVEN FILTER FABRIC SHALL BE SPECIFICALLY DESIGNED FOR SUBSURFACE DRAINAGE APPLICATIONS.
- 3. WATER FROM THE TRENCHES AND EXCAVATIONS SHALL BE DISPOSED OF IN SUCH A MANNER AS TO AVOID PUBLIC NUISANCE, INJURY TO PUBLIC HEALTH OR THE ENVIRONMENT, DAMAGE OR PUBLIC OR PRIVATE PROPERTY, OR DAMAGE TO PUBLIC OR PRIVATE PROPERTY, OR DAMAGE TO THE WORK COMPLETED OR IN PROGRESS. DO NOT DISCHARGE WATER INTO ANY SANITARY SEWER SYSTEM. SILTATION BARRIERS SHALL BE UTILIZED AS NECESSARY.
- 4. WATER FROM TRENCHES AND EXCAVATIONS SHALL NOT BE DISCHARGED DIRECTLY TO STORM DRAIN SYSTEMS. PROPER TREATMENT TO A SEDIMENTATION AREA IS TO TAKE PLACE PRIOR TO DISCHARGE TO ANY DRAINAGE SYSTEMS.
- 5. THE CONTRACTOR SHALL REPAIR ANY DAMAGE RESULTING FROM THE FAILURE OF THE DEWATERING OPERATIONS OR FROM FAILURE TO MAINTAIN ALL THE AREAS OF WORK IN SUITABLE DRY CONDITION.
- 6. PRECAUTIONS SHALL BE TAKEN TO PROTECT NEW WORK FROM FLOODING DURING STORMS OR FROM OTHER CAUSES. GRADING IN THE AREAS SURROUNDING ALL EXCAVATIONS SHALL BE PROPERLY SLOPED TO PREVENT WATER FROM RUNNING INTO THE EXCAVATED AREA OR TO ADJACENT PROPERTIES. WHERE REQUIRED, TEMPORARY DITCHES SHALL BE PROVIDED FOR DRAINAGE. UPON COMPLETION OF THE WORK AND WHEN DIRECTED, ALL AREAS SHALL BE RESTORED IN A SATISFACTORY MANNER AND AS
- 7. ALL PIPELINES OR STRUCTURES NOT STABLE AGAINST UPLIFT DURING CONSTRUCTION OR PRIOR TO COMPLETION SHALL BE THOROUGHLY BRACED OR OTHERWISE PROTECTED.
- 8. DO NOT EXCAVATE UNTIL THE DEWATERING SYSTEM IS OPERATIONAL AND THE EXCAVATION MAY PROCEED WITHOUT DISTURBANCE TO THE FINAL SUBGRADE.
- 9. UNLESS OTHERWISE SPECIFIED, CONTINUE DEWATERING UNINTERRUPTED UNTIL THE STRUCTURES, PIPES, AND APPURTENANCES TO BE BUILT HAVE BEEN PROPERLY INSTALLED. WHERE SUBGRADE MATERIALS ARE UNABLE TO MEET THE SUBGRADE DENSITY REQUIREMENTS DUE TO IMPROPER DEWATERING TECHNIQUES, REMOVE AND REPLACE THE MATERIALS AS DIRECTED BY THE INSPECTOR.

BENCH MARK: TEMPORARY BENCHMARK TO BE MANHOLE RIM ELEVATION.		REVISIONS No. DESCRIPTION DATE 1ST SUBMITTAL 04/30/19		PLANS PREPARED BY: PROFESSIONAL REPARED BY:		CITY OF HERMOSA BEACH PUBLIC WORKS DEPARTMENT	PRIVATE IMPROVEMENT PLANS	FILE NUMBER 19036—CIVIL
ELEV. = 98.53 FEET SEE KEYNOTE 22 ON C-1.	DIGALERT DIAL TOLL FREE 811 OR (1-800-227-2600) AT LEAST TWO DAYS			No. C80680 NEER		RECOMMENDED FOR PERMIT ISSUANCE:	847 BARD STREET	
	UNDERGROUND SERVICE ALERT OF CALIFORNIA		PERU CONSULTANTS, LLP CIVIL ENGINEERING & DRAFTING SERVICES 1976 W 234Th Street, Torrance, CA 90501 Phone: (310)-270-0811 peruconsultants@live.com	OF CALI	04/30/2019		CIVIL PLANS	C-4
				CHRISTIAN J. PEREZ, RCE LICENSE No. 80680	DATE	DATE	EROSION CONTROL PLAN	SHT. <u>5</u> OF <u>5</u>