

A NEW TWO STORY PLUS BASEMENT SINGLE FAMILY RESIDENCE:



NOTES GENERAL NOTES

- 1. BUILDING COMPLIES WITH 2013 CBC, 2013 CMC, 2013 CPC, 2013 CEC, AND CITY OF HERMOSA BFACH
- 2. AQMD NOTIFICATION IS REQUIRED 10 DAYS BEFORE BEGINNING ANY DEMOLITION WORK. REQUIRED FORM IS AVAILABLE AT THE COMMUNITY DEVELOPMENT DEPARTMENT. PROVIDE PROOF OF NOTIFICATION (MAIL WITH RETURN RECEIPT) 10 DAYS BEFOREBUILDING PERMIT IS ISSUED, OR COMPLETE ASBESTOSNOTIFICATION WAIVER.
- 3. ALL BUILDING FEATURES PROJECTING INTO REQUIRED SETBACKS ARE INDICATED ON SITE/PLOT PLAN.
- 4. SOILS REPORT SHALL BE PROVIDED TO THE BUILDING DEPARTMENT FOR ALL CUTS, FILLS, AND EARTHWORK AS REQUIRED BY CBC SECTION 1804.
- 5. STUMPS AND ROOTS SHALL BE REMOVED TO A DEPTH OF 12" IN THE AREA OCCUPIED BY THE BUII DING
- 6. INSTALLATION OF INTERIOR AND EXTERIOR WALL AND CEILING COVERINGS SHALL CONFORM TO CHAPTER 25 UBC. 7. ALL WATER CLOSETS TO FLUSH WITH 1.6 GALLON MAX. AND ALL NEW PLUMBING FIXTURES
- SHALL BE CERTIFIED LOW FLOW FIXTURES. 8. ALL HOSE BIBS MUST BE PROTECTED BY BACK FLOW PREVENTION AND HAVE AN ANTI-SIPHON
- DEVICE. 9. PROVIDE APPROVED BACKWATER VALVE FOR ALL PLUMBING FIXTURES LOCATED BELOW THE ELEVATION OF THE NEXT UPSTREAM MANHOLE COVER. FIXTURES ABOVE SUCH ELEVATION SHALL NOT DISCHARGE THROUGH THE BACKWATER VALVE. PROVIDE CAST IRON WASTE
- PIPE RISERS. 10. ALL WINDOW COVERINGS REQUIRED BY CFIR. FORM SHALL BE POSTED PRIOR TO FINAL
- INSPECTION. 11. WRITTEN APPROVAL FROM THE SOUTH COAST AIR QUALITY MANAGEMENT DISTRICT
- (SCAQMD). (714)396:2000 PER RULE 1403 FOR THE PROPER DISPOSAL OF ASBESTOS. 12. ONLY LOS ÁNGELÉS COUNTY HEALTH DEPARTMENT APPROVED DEVICES MAY BE UTILIZED
- FOR LANDSCAPE IRRIGATION BACK FLOW PREVENTION DEVICES. 13. ALL SITE DRAINAGE SHALL BE TERMINATED AT PUBLIC WAY VIA NON-EROSIVE DEVICE PER
- HBMC 14. PROVIDE DRIP PAN OR SIMILAR DEVICE FOR LAUNDRY ROOM, WATER HEATER, AND
- DISHWASHER. 15. PROVIDE SURVEY STAKES PRIOR TO FOUNDATION INSPECTION TO VERIFY LOT LINES. 16. THE ARCHITECT IS NOT RESPONSIBLE FOR SITE GRADING OR DRAINAGE.
- 17. IAPMO APPROVAL REQUIRED FOR ONE PIECE LAVATORY. 18. POST INSULATION COMPLIANCE CARD IN CONSPICUOUS LOCATION IN DWELLING PRIOR TO FINAL INSPECTION.
- 19. IT IS THE GENERAL CONTRACTORS RESPONSIBLITY TO VERIFY THAT THE BUILDING IS WITHIN THE HEIGHT LIMIT PRIOR TO FRAMING THE ROOF RAFTERS. CONTACT THE CIVIL SURVEY CONSULTANTS.
- 20. CONTROL VALVE FOR SHOWERS AND TUB/SHOWERS SHALL BE OF THE PRESSURE BALANCE OR THERMOSTATIC MIXING VALVE TYPE. UPC. SECT. 410.7. 21. VERIFY CLEARANCES WITH OVERHEAD UTILITY LINES FROM ALL PERMANENT AND TEMPORARY STRUCTURE INCLUDING SCAFFOLDING AND OTHER WORKING AREAS DURING CONSTRUCTION. CLEARANCE TO BE 8 FT. HORIZONTAL AND 12 FT. VERTICAL. VERIFY WITH
- SOUTHERN CALIFORNIA EDISON CO. BEFORE COMMENCING CONSTRUCTION. 22. PROVIDE PROTECTION TO PEDESTRIANS PER UBC SECTION 3303 DURING CONSTRUCTION. 23. BUILDING ADDRESS SHALL BE PROVIDED ON THE BUILDING IN SUCH A POSITION AS TO BE
- PLAINLY VISIBLE AND LEGIBLE FROM THE STREET PER CBC SEC. 501. 24. THE STRUCTURE SHALL COMPLY WITH THE SECURITY REQUIREMENTS OF "APPENDIX CHAPTER 10 SECURITY" OF HBMC.
- 25. COOKING EQUIPMENT MUST BE LISTED FOR RESIDENTIAL USE. 26. BUILDING ADDRESS SHALL BE PROVIDED ON THE BUILDING IN SUCH A POSITION AS TO BE PLAINLY VISIBLE AND LEGIBLE FROM THE STREET PER CITY CODE SECTION 502. 27. ALL DOORS PROVIDING DIRECT ACCESS TO THE POOL SHALL BE EQUIPPED WITH A SELF CLOSING. SELF LATCHING DEVICE WITH A RELEASE MECHANISM PLACED NO LOWER THAN 54" AFF. ALL THESE DOORS SHALL BE EQUIPPED WITH EXIT ALARMS. CBC SECTION
- 3109.4.1.8. 28. THE INSTALLATION OF A CONDUIT FROM THE ROOF TO THE SERVICE PANEL SHALL BE REQUIRED TO ASSIST AND ENCOURAGE THE INSTALLATION OF ROOF MOUNTED ENERGY COLLECTION/GENERATION DEVICES FOR NEW RESIDENTIAL CONSTRUCTION OR ADDITIONS OR REMODELS WHERE: (1) THE EXPANSION EXCEEDS 50 PERCENT OF THE EXISTING GROSS FLOOR AREA: OR (2) THE COST OF REMODELING, EXPANSION OR IMPROVEMENT EXCEEDS 50 PERCENT OF THE VALUE OF THE EXISTING STRUCTURE AS DETERMINED BY THE BUILDING OFFICIAL. SAID ELECTRIC SERVICE PANEL SHALL BE OF ADEQUATE SIZE TO PROVIDE CAPACITY FOR THE FUTURE ADDITION OF PHOTOVOLTAIC AND SOLAR THERMAL. OR OTHER EQUIVALENT ALTERNATIVE ENERGY PRODUCING DEVICE(S). SOLAR PANEL INSTALLATIONS
- AND OTHER ROOF ATTACHMENTS SHALL CONFORM TO THE PROVISIONS OF SECTION 15 04 084 29. WHERE A DWELLING UNIT OCCUPIES TWO STORIES, INTERIOR ACCESS SHALL BE PROVIDED BETWEEN STORIES BY AN OPEN UNENCLOSED STAIRWAY. 30. CONDUIT FROM ROOF TO ELECTRIC SERVICE PANEL WILL BE REQUIRED.

EXCAVATION NOTES 1. PROVIDE CONTINUOUS INSPECTION DURING EXCAVATION OF SHORING AND INSTALLATION OF SHORING

- MEMBERS 2. AN EXCAVATION/CONSTRUCTION PERMIT SHALL BE OBTAINED PRIOR TO CONSTRUCTION OF ANY
- IMPROVEMENTS WITHIN PUBLIC RIGHT-OF-WAY. THIS INCLUDES, BUT IS NOT LIMITED TO, STANDARD SIDEWALKS, CURBS, GUTTERS, DRIVEWAY APPROACHES, OR UNDERGROUNDING OF UTILITIES.
- 3. CONTRACTOR TO PROVIDE EVIDENCE OF PERMIT FROM CALIFORNIA STATE DEPARTMENT OF INDUSTRIAL SAFETY FOR EXCAVATION 5'-0" OR DEEPER. CALL 213.736.3041. 4. IT IS THE CONTRACTOR'S RESPONSIBILITY TO CONTACT "DIG ALERT" PRIOR TO ANY EXCAVATION IN THE
- PUBLIC RIGHT-OF-WAY. (800) 227-2600 5. PROVIDE TEMPORARY SHORING OF ADJACENT PROPERTY. QUALIFIED PERSONS REGISTERED WITH
- THE STATE SHALL DESIGN SHORING. 6. A PERMIT IS REQUIRED FROM THE STATE DIVISION OF INDUSTRIAL SAFETY FOR TRENCHES OR
- EXCAVATION 5' (1.52 METERS) OR DEEPER OR BUILDING/STRUCTURE OVER 3 STORIES HIGH, OR BUILDING OVER 36' (11 METERS) HIGH.

PROJECT LOCA

LEGAL DESCR ASSESSOR PA ZONING: SCOPE OF WO

GARAGE (INTERIOR DI BASEMENT LIVING DECKS/BALCONIES 1ST LEVEL LIVING ARE DECKS/ BALCONIES 2ND LEVEL LIVING ARE DECKS/ BALCONIES ROOF DECKS TOTAL LIVING AREA TOTAL DECKS/ BALCO NO. OF BEDROOMS NO. OF BATHROOM

ZONING INFORMAT AREA LOT AREA LOT COVERAGE YARDS FRONT SIDE REAR PARKING AND DRIVEY NUMBER OF SP/ GUEST SPACES PARKING SETBA PARKING STALL TURNING AREA DRIVEWAY MININ DRIVEWAY MAXIN OPEN SPACE ON GRADE DECKS/ BALCON TOTAL

1ST LEVEL F.F. ELEVA LINEAL FEET (LF) OF LF OF PERIMETER <6 % OF PERIMETER <6

A NEW RESIDENCE 3411 THE STRAND HERMOSA BEACH, CA 90254

SYMBOL	LEGEND
8'-0" FLAT CLG. LIVING ROOM 100.00' S.F.E.	 CEILING HEIGHT ROOM NAME SUB-FLOOR ELEVATION
12"	DIFFERENTIAL IN FLOOR ELEVATION, FINISH SURFACE, OR CHANGE IN WALL PLAN
● 100.00' S.F.E	 ELEVATION SUB FLOOR ELEVATION
● 100.00'	 ELEVATION LIGHT WEIGHT CONCRETE FLOOR ELEVATION
B A-00 D	- SHEET NUMBER - ELEVATION DESIGNATION
C	 SLOPED SURFACE SURFACE DESCRIPTION (ARROW POINTS DOWN SLOPE)
	 FLOW LINE (ARROW POINTS DOWN SLOPE) ROOF SLOPE DESCRIPTION
12	- SLOPE RUN
4	- SLOPE RISE
Â	WINDOW LETTER DESIGNATION
1	- DOOR NUMBER DESIGNATION
<u>A</u>	- SKYLIGHT LETTER DESIGNATION
	- NORTH ARROW DESIGNATION
	 REVISION NUMBER EXTENTS OF REVISION
A-00	SECTION NUMBERSHEET NUMBER
DN. 0 R. @ 0"	 TOP/BOTTOM RISER # OF RISERS UP/DOWN

ABBREVIATION

B.O.W.

A.H.	ACTUAL HEIGHT		
A.W.	AWNING WINDOW		
B.O.W.	BOTTOM OF WALL		
C.H.	CRITICAL HEIGHT		
CLG.	CEILING		
CLR.	CLEAR		
COL.	COLUMN		
CONC.	CONCRETE		
C.W.	CASEMENT WINDOW		
DIM.	DIMENSION		
DN.	DOWN		
ELEV.	ELEVATION		
F.A.	FROM ABOVE		
FLR.	FLOOR		
FX.	FIXED		
HORZ.	HORIZONTAL		
HT.	HEIGHT		
LAND.	LANDING		
LT.WT.	LIGHT WEIGHT CONCRETE		
MAX.	MAXIMUM		
MIN.	MINIMUM		
OP.	OPERABLE		
PLINE.	PROPERTY LINE		
REQ.	REQUIRED		
SECT.	SECTION		
S.F.E.	SUB FLOOR ELEVATION		
SHT.	SHEET		
SK.	SKEWED		
SL.	SLOPED		
T.O.W.	TOP OF WALL		

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PROJECT DATA

PROPERTY OWNER

TSNH INVESTMENTS 942 HIGHVIEW AVENUE MANHATTAN BEACH, CA 90266 PHONE 310-963-1711

LEGAL DESCRIPTION LOT 1,

THE DALE TRACT M.B. 21-141 APN 4181-034-001

OCCUPANCY AND ZONING

OCCUPANCY: R3/U ZONING: R1 APN: 4181-034-001 CONSTRUCTION TYPE: TYPE V-B NO. OF UNITS: 1 NO. OF STORIES: 2 + BASEMENT

AUTOMATIC FIRE SPRINKLERS REQ'D FOR ENTIRE BUILDING PER CRC SECT. R313.2

CITY, STATE, NATIONALLY APPLICABLE CODES

2016 CBC, 2016 CMC, 2016 CPC, 2016 CEC, 2016 CRC, 2016 GBS, 2016 CEC, AND THE CITY OF HERMOSA BEACH

AREA CALCULATIONS LOT SIZE

BASEMENT LIVING FIRST FLOOR LIVING SECOND FLOOR LIVING TOTAL LIVING

GARAGE STORAGE

BALCONIES/DECKS (SEE SHEET A.00 FOR MORE INFORMATION)

OPEN SPACE CALCULATIONS

BASEMENT FLOOR	
FIRST FLOOR	
SECOND FLOOR	
ROOF	
TOTAL OPEN SPACE PROVIDED	

LOT COVERAGE CALCULATIONS

MAX. ALLOWABLE LOT COVERAGE =70% X LOT SIZE (2275 S.F.) = 1592.5 S.F. ACTUAL LOT COVERAGE = 1556 S.F.= 68.39%

CONSULTANTS CIVIL SURVEY CONSULTANT DENN ENGINEERS 310.542.9433

3914 DEL AMO BLVD. SUITE 921 TORRANCE, CA. 90503

PROJECT SUMMARY

ATION:	3411 THE STRAND, HERMOSA BEACH, CA. 90254		
IPTION:	LOT 1, THE DALE TRACT		
RCEL NO:	APN: 4181-034-001		
	R-1		
	NEW TWO STORY PLUS BASEMENT RESIDENTIAL BUILDING WITH ATTACHED GARAGE, DEMOLITION OF EXISTING BUILDING		

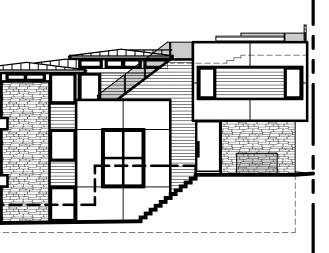
GENERAL BUILDING INFORMATION (NOTE: FOR ADDITION AND REMODEL PROJECTS, PLEASE PROVIDE INFORMATION FOR EXISTING AREA AND ADDED AREA.)

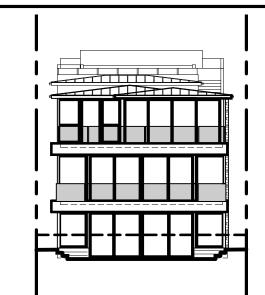
IMENSIONS)	17'-2"x20'-2"	
	1469 S.F.	
	300 S.F.	
A	989 S.F.	
	63 S.F.	
EA	1392 S.F.	
	90 S.F.	
	293 S.F.	
	3850 S.F.	
NY	746 S.F.	
3	5	
S	5 FULL 2 HALF	

TION	REQUIRED	PROVIDED
		2275 S.F.
Ε	MAX 1592.5 S.F. (70% OF LOT)	1556 S.F. (68.39% OF LOT)
	6'-6" (ALL FLOORS)	7'-5"(ALL FLOORS)
	3'-6"	3'-6"
	3'(1st FLOORS) & 1'(FLOORS ABOVE)	3'(1st FLOORS) & 1'(FLOORS ABOVE)
WAYS		
PACES	2	2
S	1	1
ACK		
L DIMENSION	8'-6"x20'-0"	17'-0"x20'-0"
ł	22'	22'-21/2"
IIMUM WIDTH	9'-0"	15'-6"
XIMUM SLOPE	12.5%	8%
	200	300
NIES	100	100
	300	400

BASEMENT QUALIFICATION CALCULATION

VATION	
F PERIMETER	
<6' FROM GRADE TO F.F. ABOVE	
6' TO FF ABOVE	





SHEET INDEX

A.08

G.01	PROJECT INFORMATION
C.01	CIVIL SURVEY
A.00	AREA CALC'S
A.01	SITE PLAN
A.02	BASEMENT FLOOR PLAN
A.03	FIRST FLOOR PLAN
A.04	SECOND FLOOR PLAN
A.05	ROOF PLAN
A.05.1	CRITICAL POINT PLAN
A.06	ELEVATIONS
A.07	ELEVATIONS

SECTION

SHEET NUMBER **G.01**

PROJECT **INFORMATION**

DRAWING

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PROJECT NUMBER 18025 PRINT DATE

REVISION SCHEDULE

DESCRIPTION

8/14/2019 2:34:24 PM

REVISIONS

NUMBER

STAMP

3411 THE STRAND HERMOSA BEACH CALIFORNIA 90254





MANHATTAN BEACH, CA 90266 TEL: 310-318-8089 WWW.TOMARO.COM

2617 NORTH SEPULVEDA BLVD.

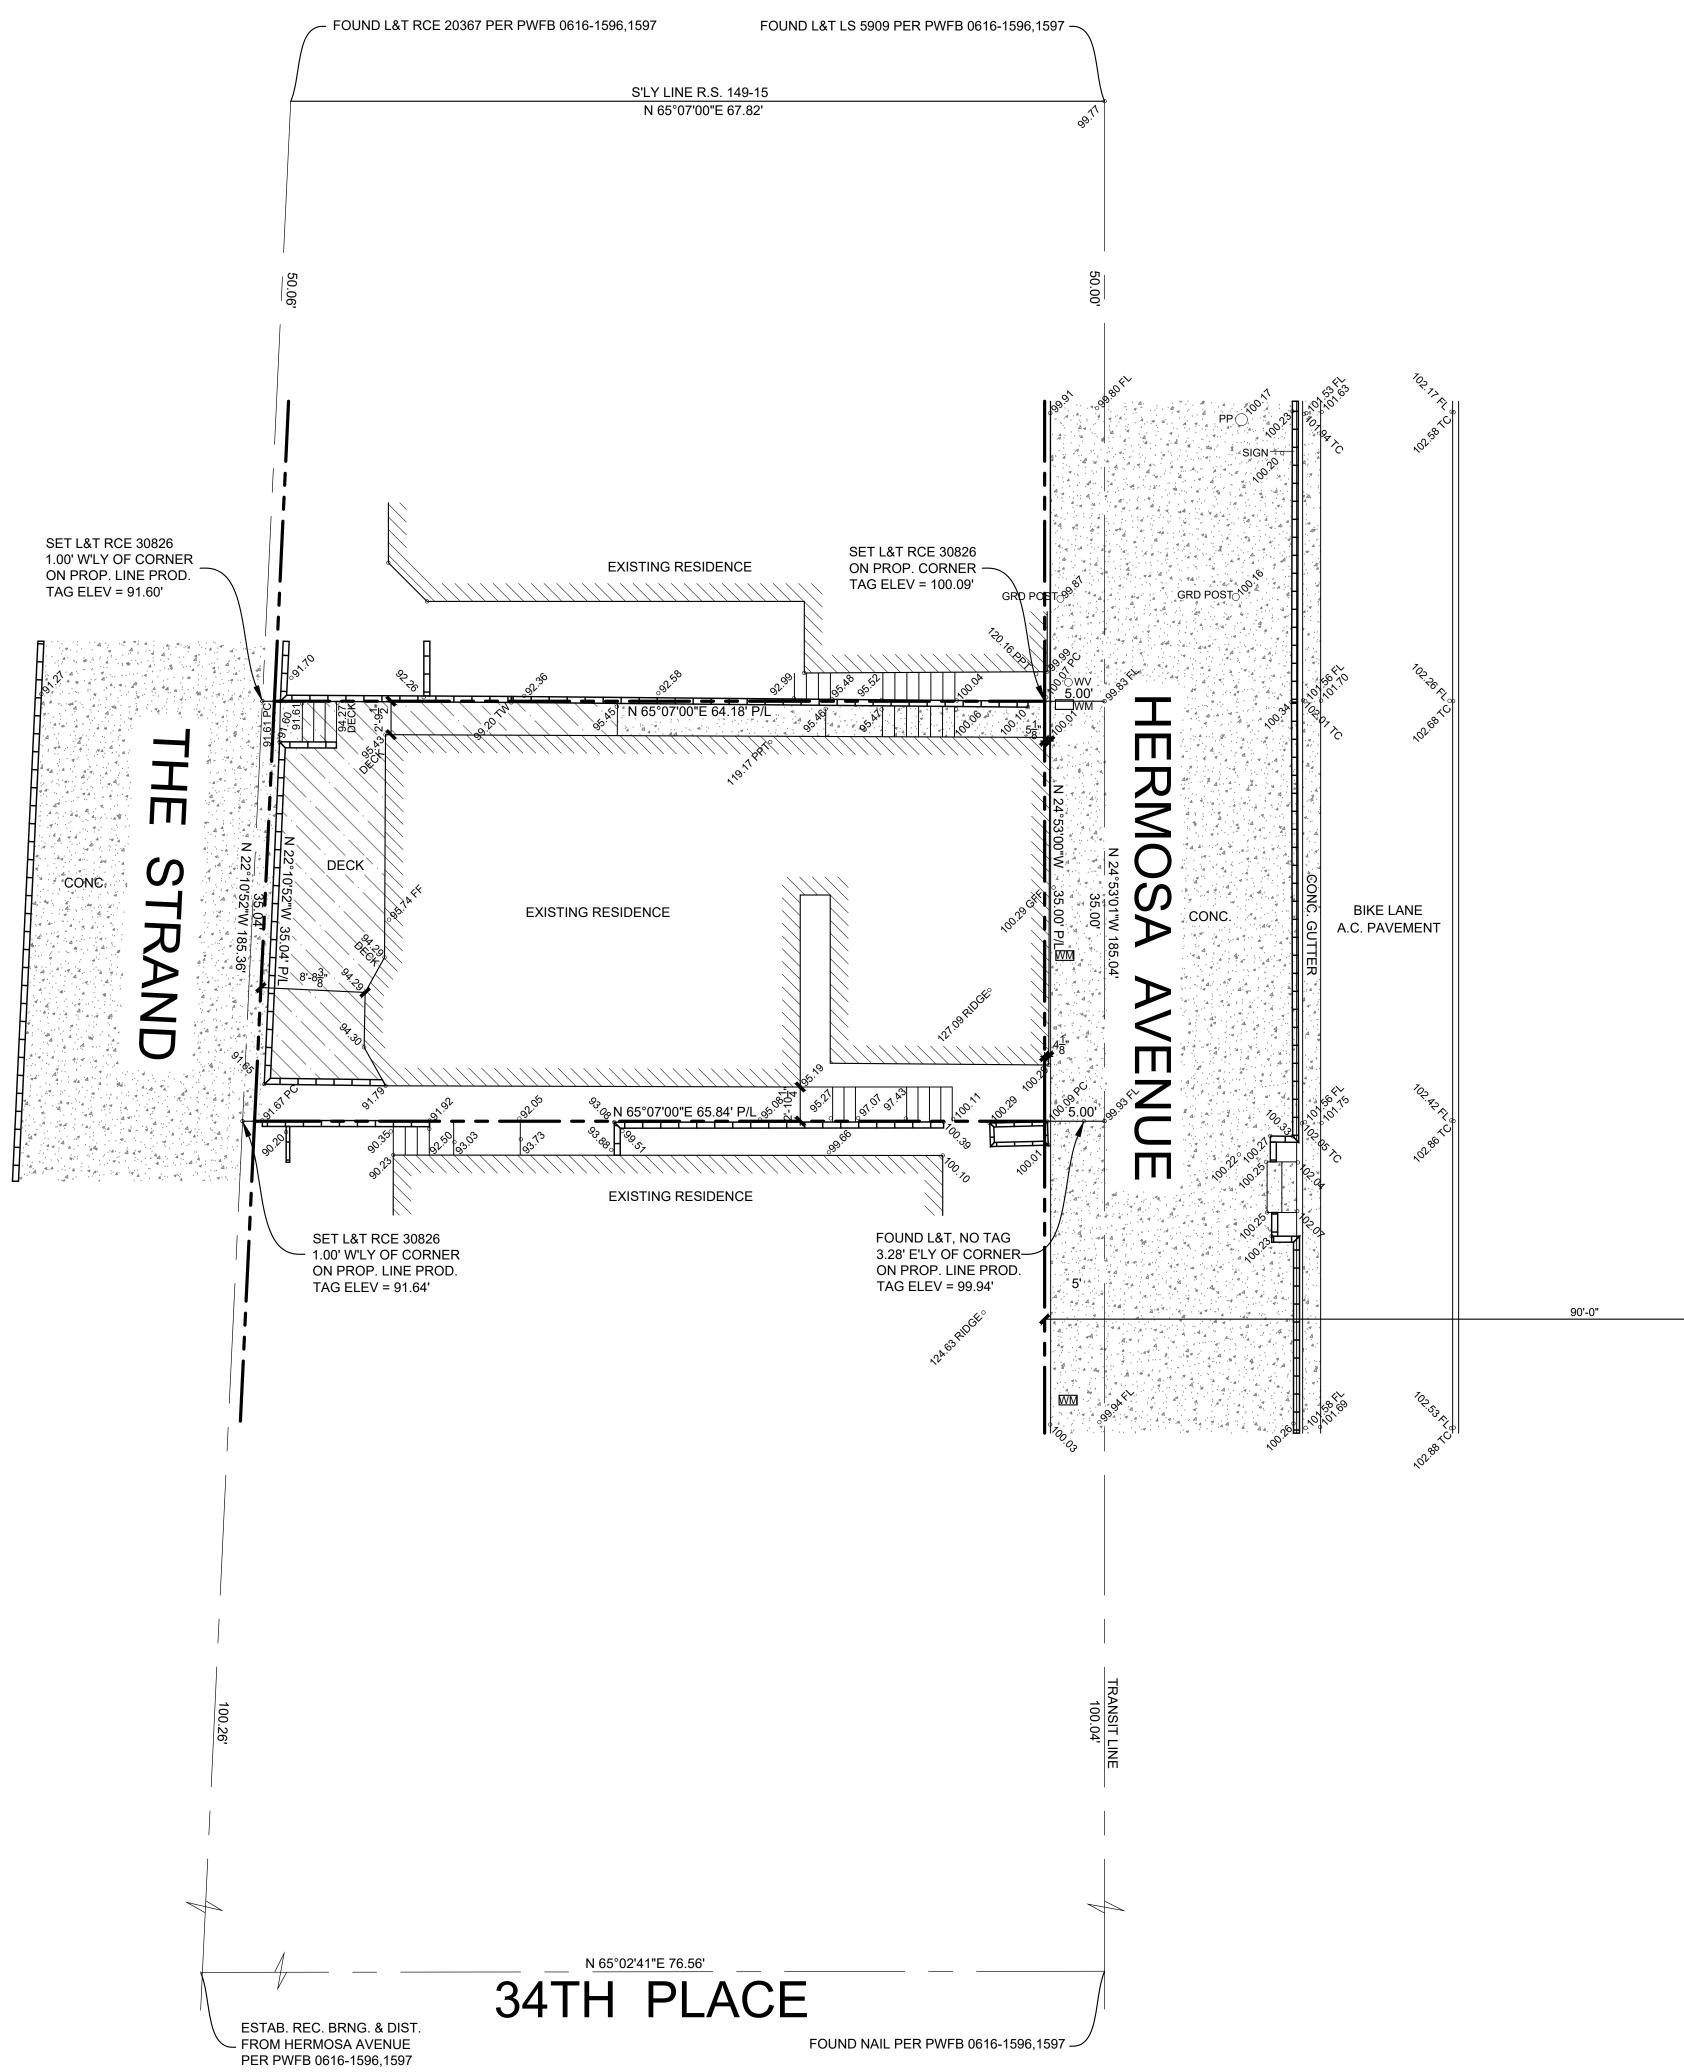
= 2275 S.F.

=	1469	S.F.	
=	989	S.F.	
=	1392	SF.	
=	3850	S.F.	
=	375	S.F.	
=	22	S.F.	
=	746	S.F.	

= 300 = 0 = 0 = 100 = 400







A TITLE POLICY HAS BEEN PROVIDED AND REVIEWED BY DENN ENGINEERS AT THE TIME OF THIS SURVEY. ANY READILY AVAILABLE ITEMS AFFECTING THIS PROPERTY HAVE BEEN PLOTTED BASED ON PROVIDED DOCUMENTS.

USA NATIONAL TITLE COMPANY ORDER NO. 071833027-GD DATED JULY 16, 2018



SHEET 1 OF 1

ENGINEERS MAY BE JOINED.

ANY CHANGES OR MODIFICATIONS MADE TO THIS PLAN WITHOUT WRITTEN CONSENT OF DENN ENGINEERS SHALL RELIEVE DENN ENGINEERS FROM ANY LIABILITY OR DAMAGE RESULTING FROM SUCH CHANGES OR MODIFICATIONS, INCLUDING ANY ATTORNEYS FEES OR COSTS INCURRED IN ANY PROCEEDING THAT DENN

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SCALE 1" = 8'

SCALE: 1/8"=1'-0"

CIVIL SURVEY

DISTANCES. IF THERE ARE ANY QUESTIONS, PLEASE DO NOT HESITATE TO CONTACT DENN ENGINEERS FOR CLARIFICATION AT : (310) 542-9433, M-F 8:00 AM TO 5:00 PM.

SET ON PROPERTY CORNERS. PLEASE REFER TO THE NOTATION ON THE PLANS FOR OFFSET

BOUNDARY MONUMENTS ARE NOT NECESSARILY

ARE MEASURED TO EXTERIOR SURFACE OF BUILDINGS UNLESS OTHERWISE NOTED.

TOP OF CURB TC TOP OF WALL / T.O.W. тw TOP OF DRIVEWAY APRON ТΧ W'LY WESTERLY WM WATER METER

NOTE: ALL SETBACK DIMENSIONS SHOWN

FE FENCE FINISH FLOOR FF FH FIRE HYDRANT FLOW LINE FL GARAGE FINISH FLOOR GFF GM GAS METER GW GUY WIRE LEAD AND TAG L&T MANHOLE MH N'LY NORTHERLY PROPERTY CORNER / PROP. CORNER PC PROPERTY LINE / PROP. LINE PL, P/L PP POWER POLE PPT PARAPET S&W SPIKE AND WASHER SOUTHERLY S'LY SPK SPIKE SSCO SANITARY SEWER CLEAN OUT SANITARY SEWER MANHOLE SSMH STAKE / STAKE & TAG STK STLT STREET LIGHT

> DRAWING **CIVIL SURVEY**

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GARY J. ROEHL

REVISIONS

LEGEND

EXISTING

UILDING

CONCRETE

◦ 106.76 EXISTING ELEVATION

100 _ EXISTING CONTOUR

— X — EXISTING FENCE

CENTERLINE

CHAIN-LINK

EASTERLY

ELECTRIC METER FOUND

BEGINNING OF CURB RETURN

BLOCK WALL

BCR

C/L C.L.F.

E'LY

EM

FD

CHECK BY TS DRAWN BY KW

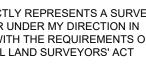
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AUGUST 21, 2018

R.C.E. 30826

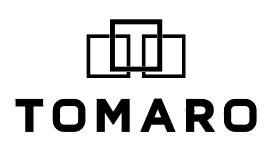
BRICK

WOOD



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ARCHITECTURE



3914 DEL AMO BLVD, SUITE 921 TORRANCE, CA 90503 (310) 542-9433

942 HIGHVIEW AVENUE MANHATTAN BEACH, CA 90266 PHONE 310-963-1711

SURVEY AND

TOPOGRAPHY

FRANK KHULUSI

FOR

JOB ADDRESS 3411 THE STRAND HERMOSA BEACH, CA 90254

LOT 1, THE DALE TRACT M.B. 21-141

LEGAL DESCRIPTION

APN 4181-034-001

THIS MAP CORRECTLY REPRESENTS A SURVEY MADE BY ME OR UNDER MY DIRECTION IN CONFORMANCE WITH THE REQUIREMENTS OF

PROFESSIONAL LAND SURVEYORS' ACT

PROJECT

A NEW

RESIDENCE 3411 THE STRAND HERMOSA BEACH

CALIFORNIA 90254

STAMP

PROJECT NUMBER

8/14/2019 2:34:27 PM

REVISION SCHEDULE

DATE

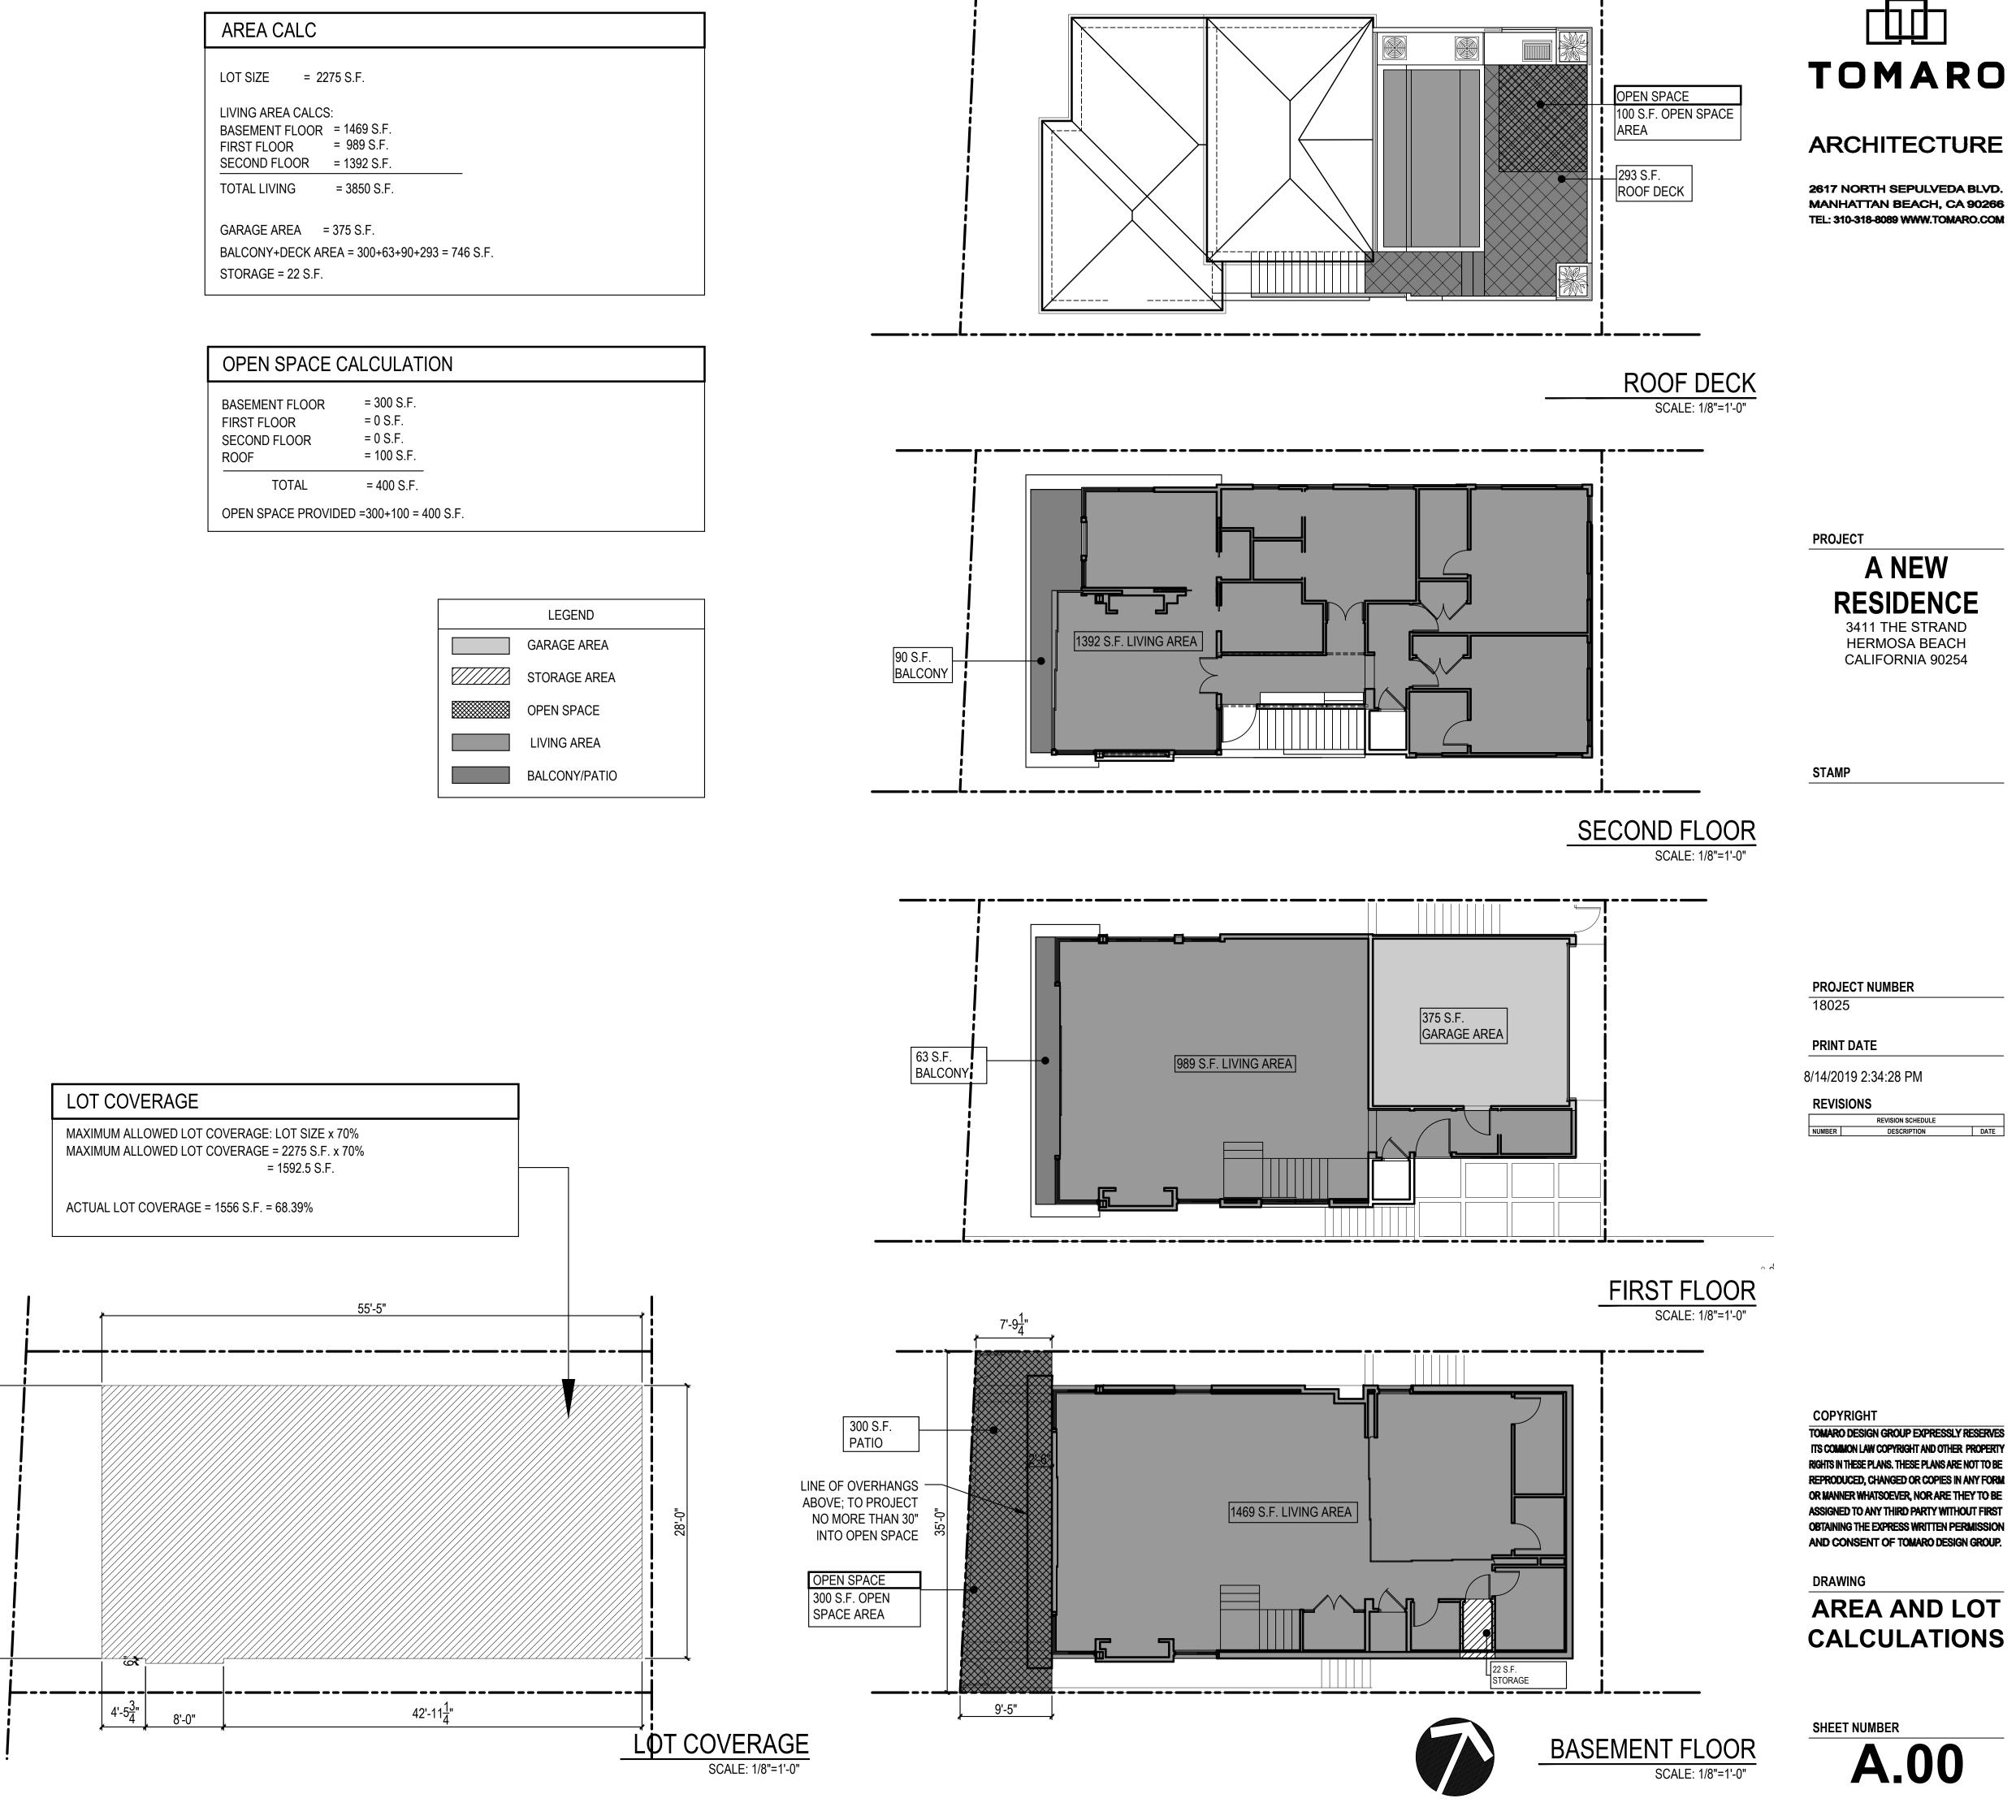
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PRINT DATE

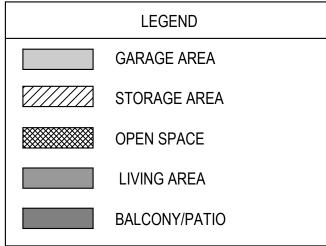
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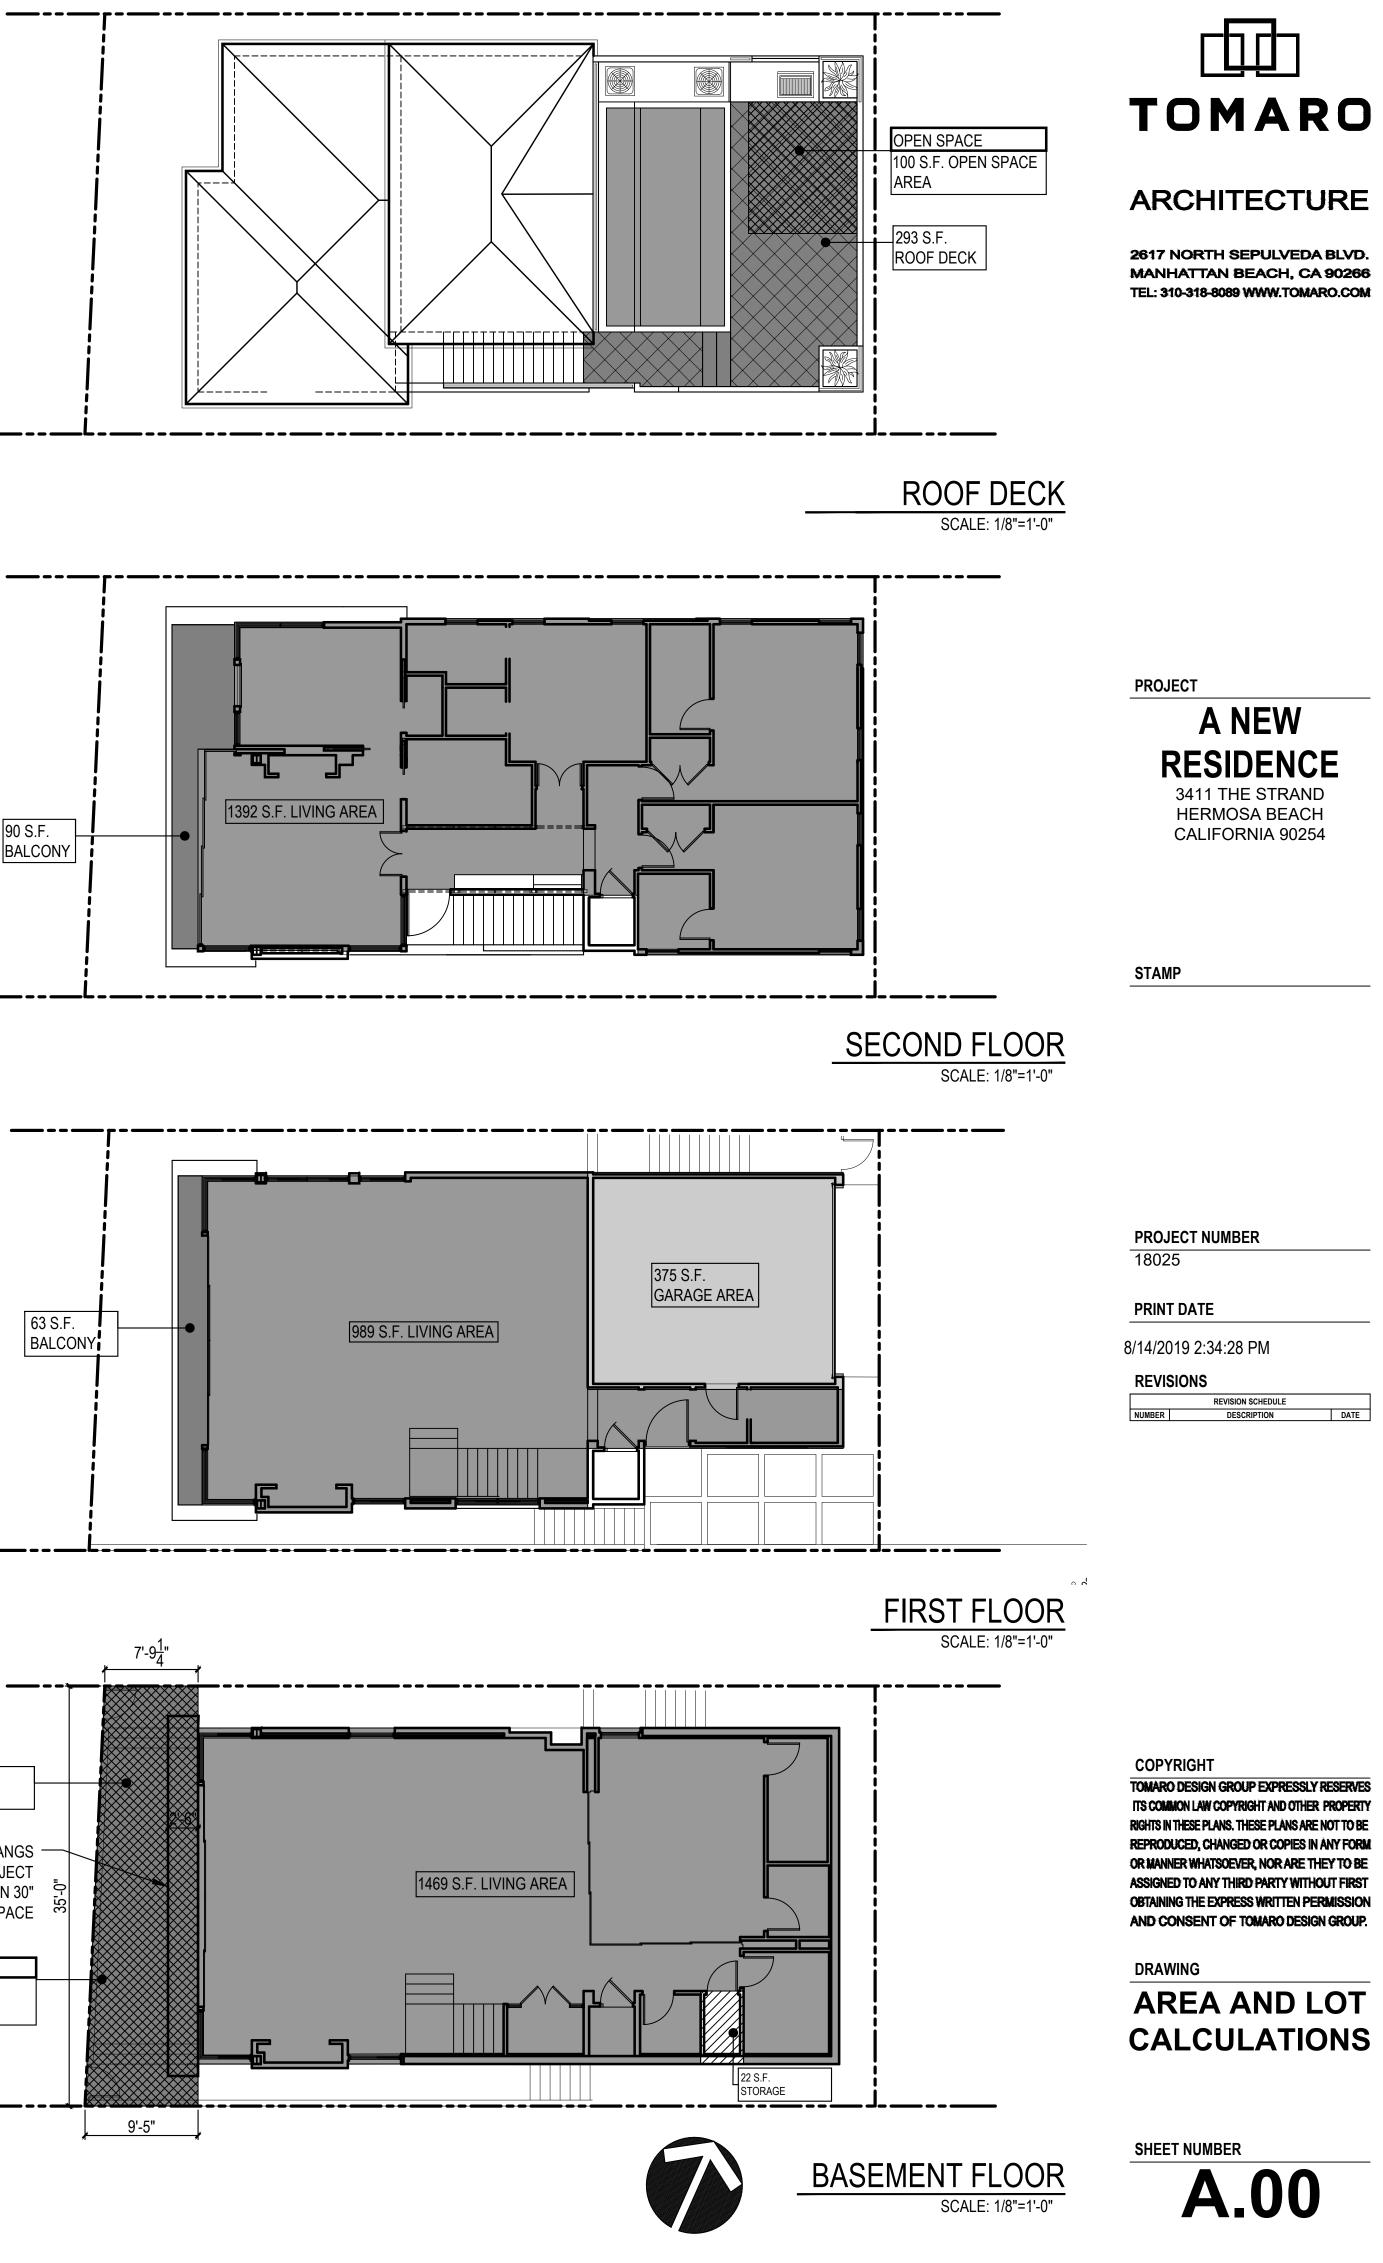
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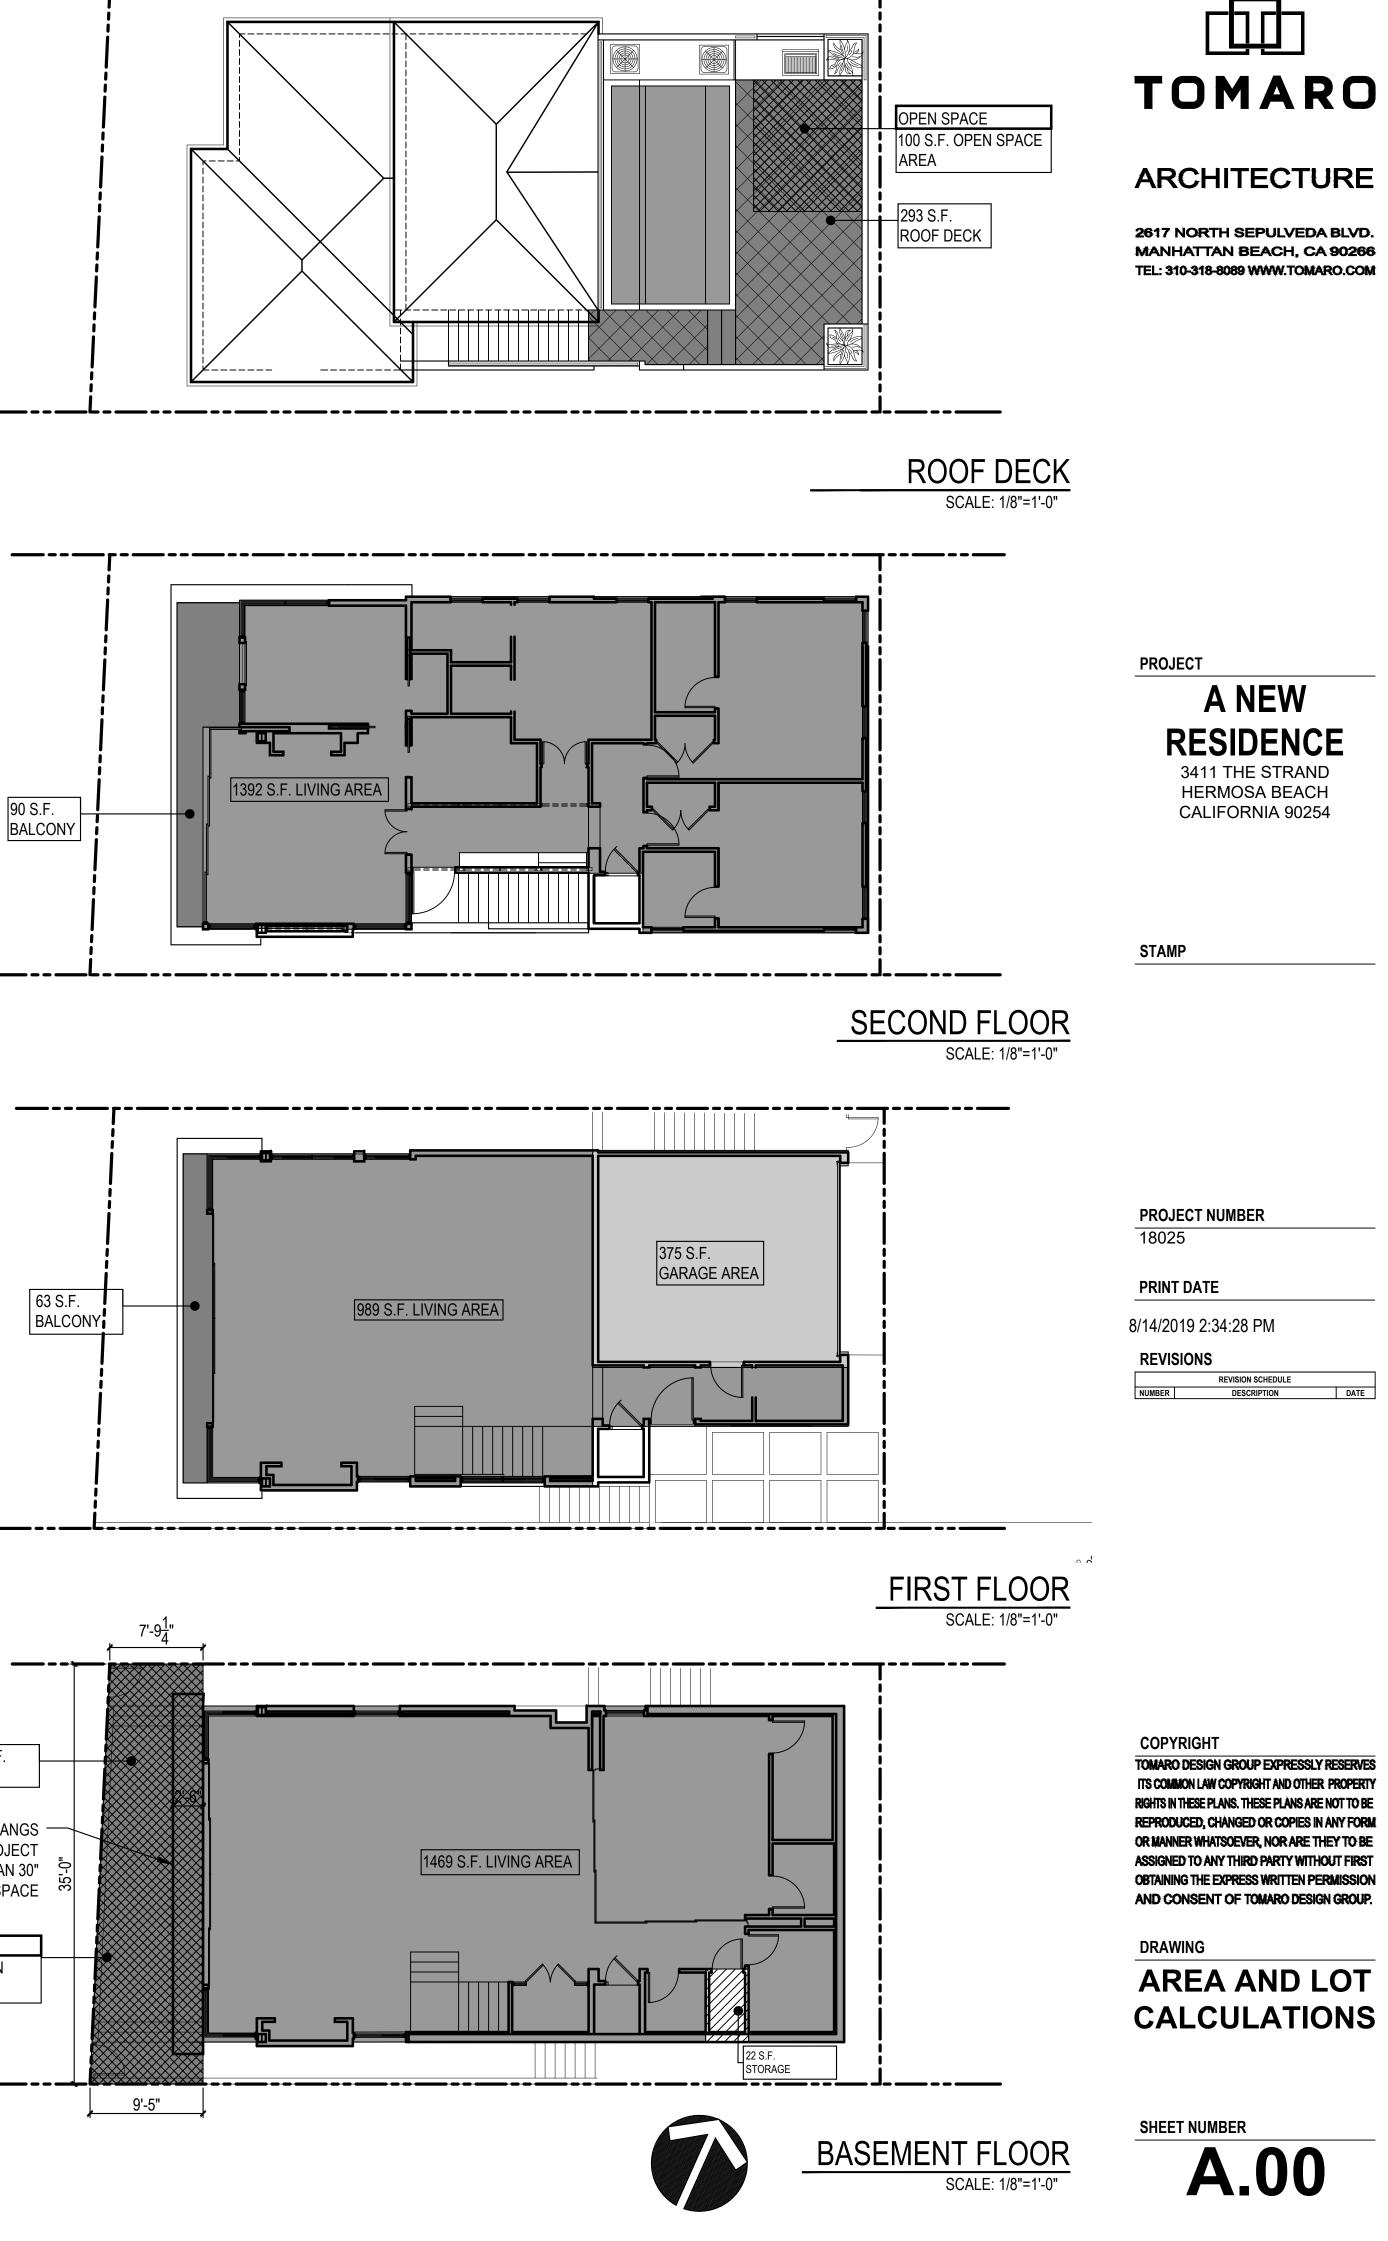


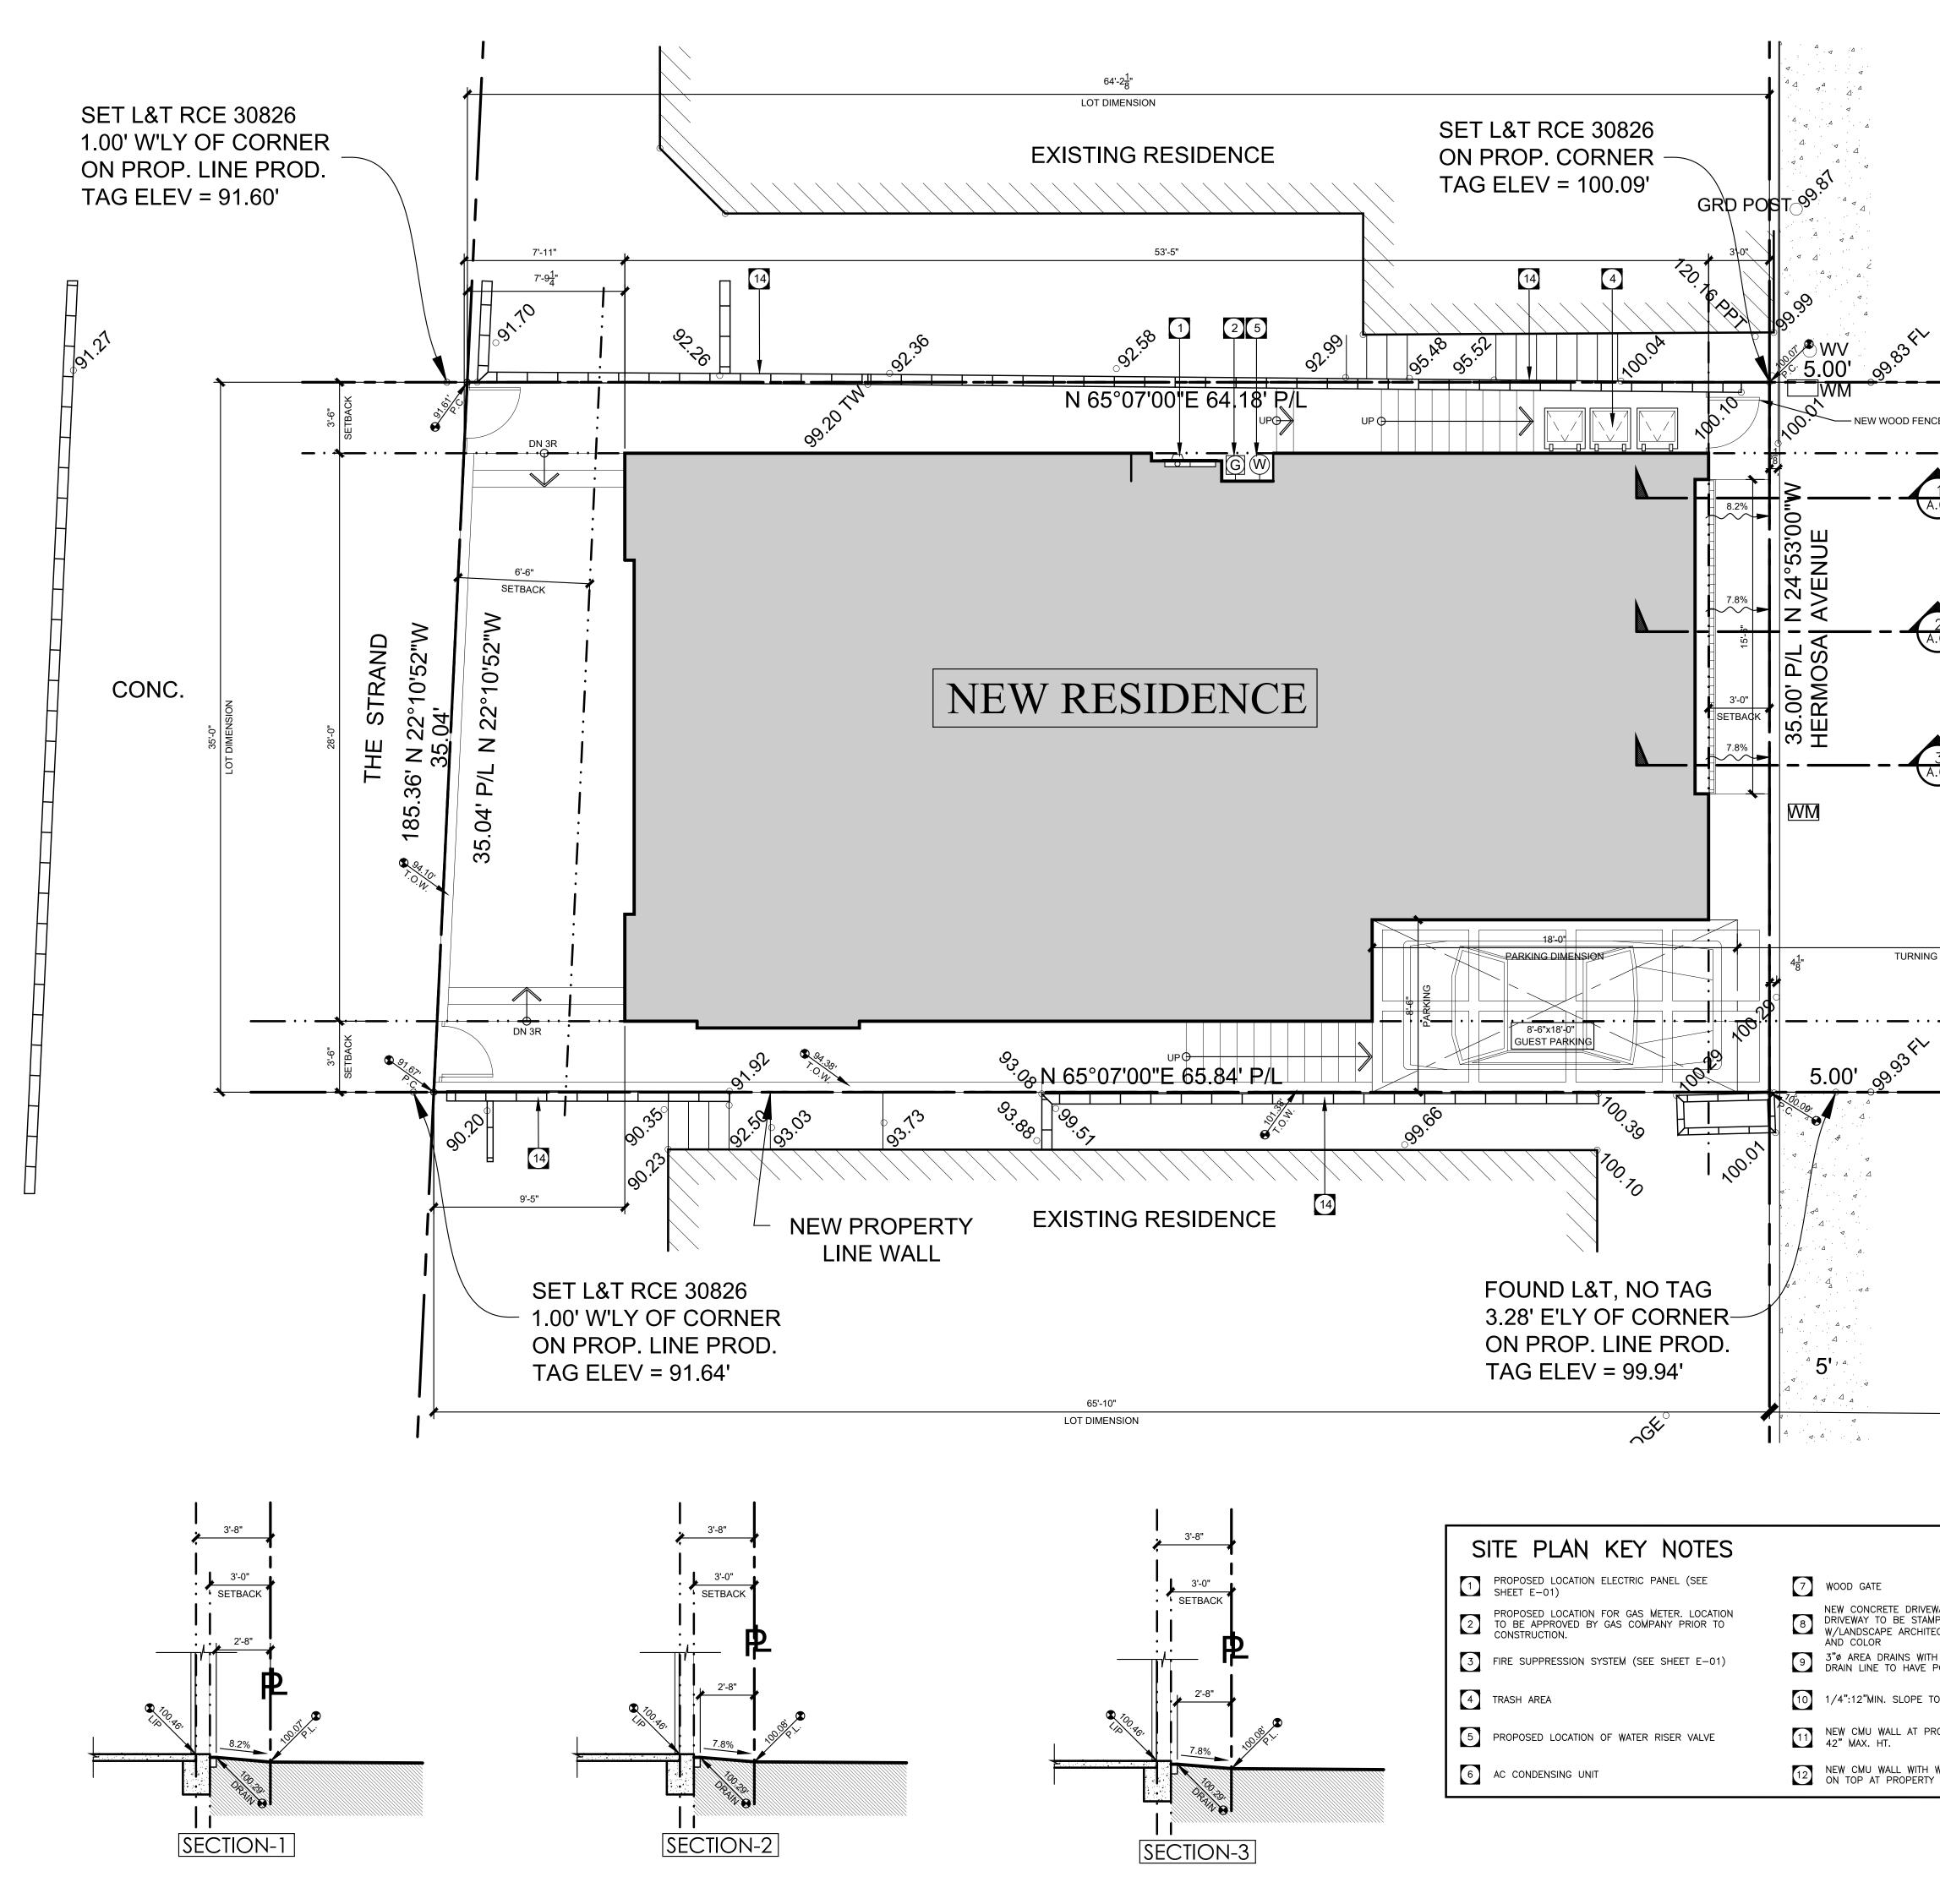
AREA CALC
LOT SIZE = 2275 S.F.
LIVING AREA CALCS: BASEMENT FLOOR = 1469 S.F. FIRST FLOOR = 989 S.F. SECOND FLOOR = 1392 S.F.
TOTAL LIVING = 3850 S.F.
GARAGE AREA = 375 S.F. BALCONY+DECK AREA = 300+63+90+293 = 746 S.F. STORAGE = 22 S.F.

OPEN SPACE CALCULATION		
BASEMENT FLOOR FIRST FLOOR SECOND FLOOR ROOF	= 300 S.F. = 0 S.F. = 0 S.F. = 100 S.F.	
TOTAL	= 400 S.F.	
OPEN SPACE PROVIDED =300+100 = 400 S.F.		



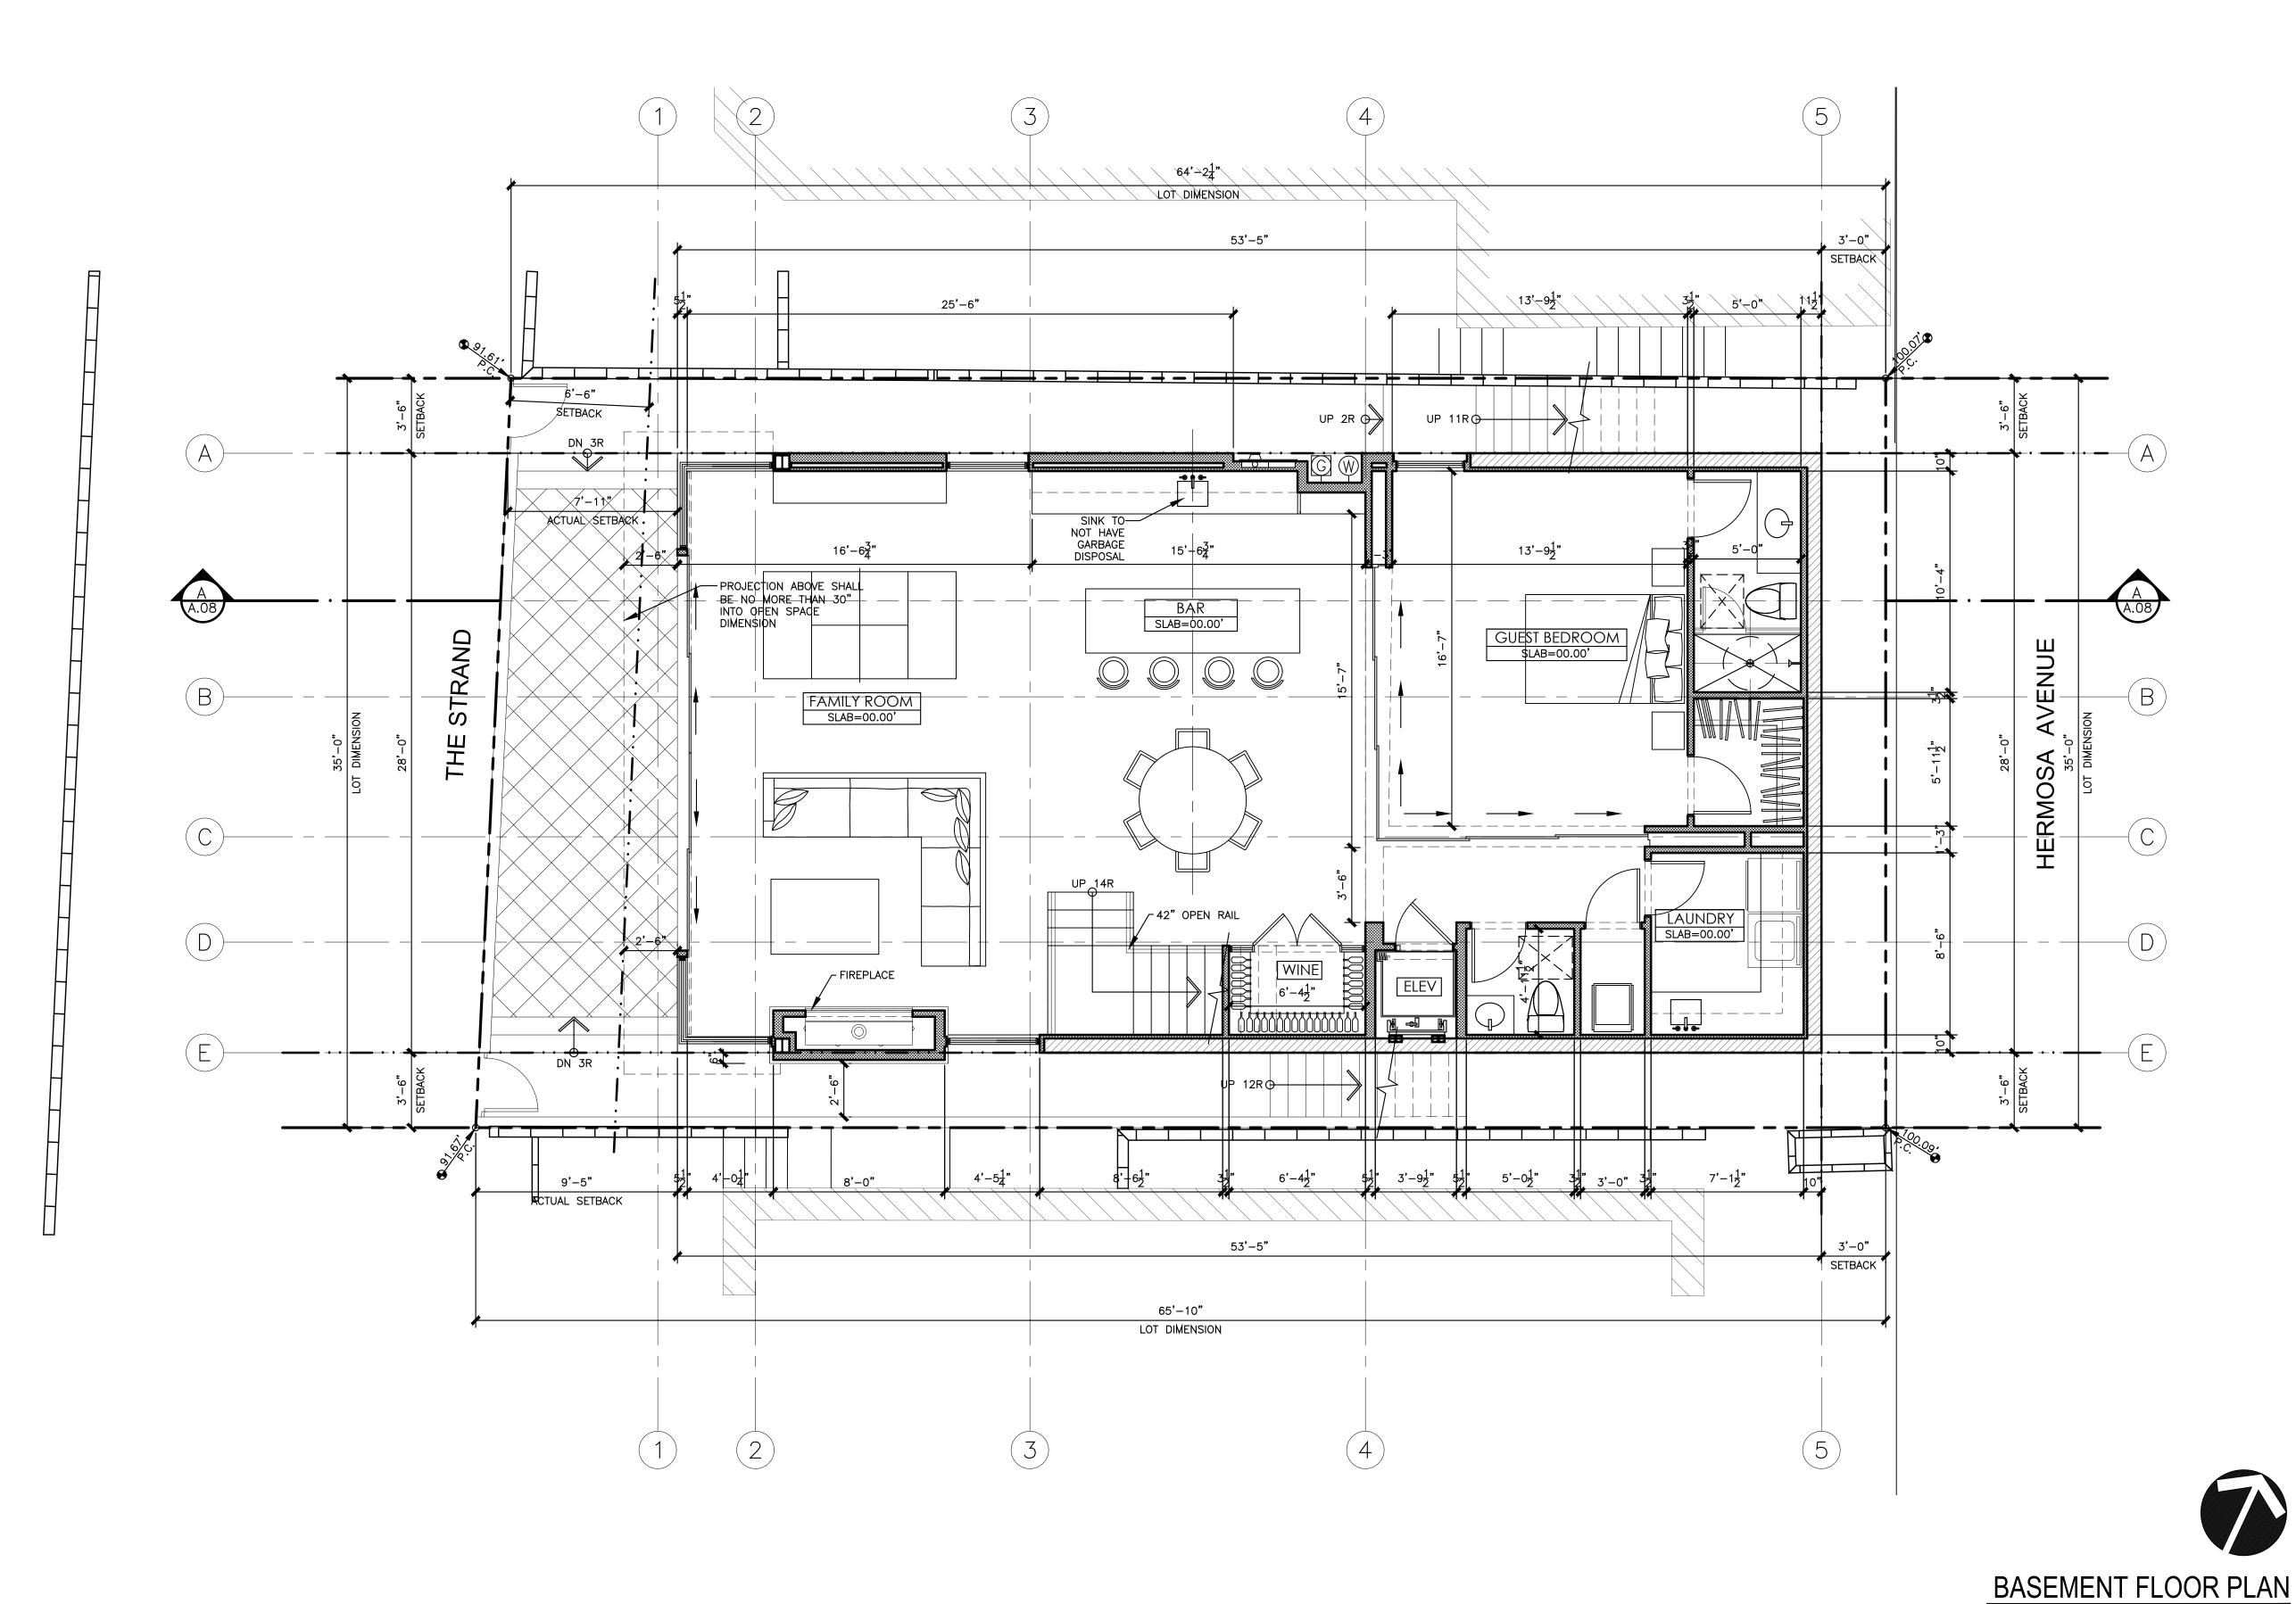


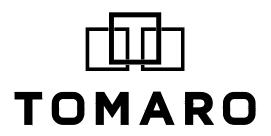




GRD POST 100.16 RD POST 100.1	ARCHITECTURE
CONC. BIKE LANE A.C. PAVEMENT	<section-header><section-header><section-header><section-header><section-header><section-header><text></text></section-header></section-header></section-header></section-header></section-header></section-header>
ZZ-3 ⁻ G RADIUS DIMENSION	PROJECT NUMBER 18025 PRINT DATE 8/14/2019 2:34:32 PM REVISIONS REVISIONS REVISIONS DESCRIPTION DATE
WAY PER CITY STANDARDS. WAY PER CITY STANDARDS. WEW WOOD FENCE @ PROPERTY LINE - 6'-0" MAX HT. IMAX HT.	COPYRIGHT TOMARO DESIGN GROUP EXPRESSLY RESERVES TIS COMMON LAW COPYRIGHT AND OTHER PROPERTY RIGHTS IN THESE PLANS. THESE PLANS ARE NOT TO BE REPRODUCED, CHANGED OR COPIES IN ANY FORM OR MANNER WHATSOEVER, NOR ARE THEY TO BE ASSIGNED TO ANY THIRD PARTY WITHOUT FIRST OBTAINING THE EXPRESS WRITTEN PERMISSION AND CONSENT OF TOMARO DESIGN GROUP. DRAWING DRAWING
SCALE: 1/4"=1'-0"	

SCALE: 1/4"=1'-0"





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SHEET NUMBER

A.02

BASEMENT **FLOOR PLAN**

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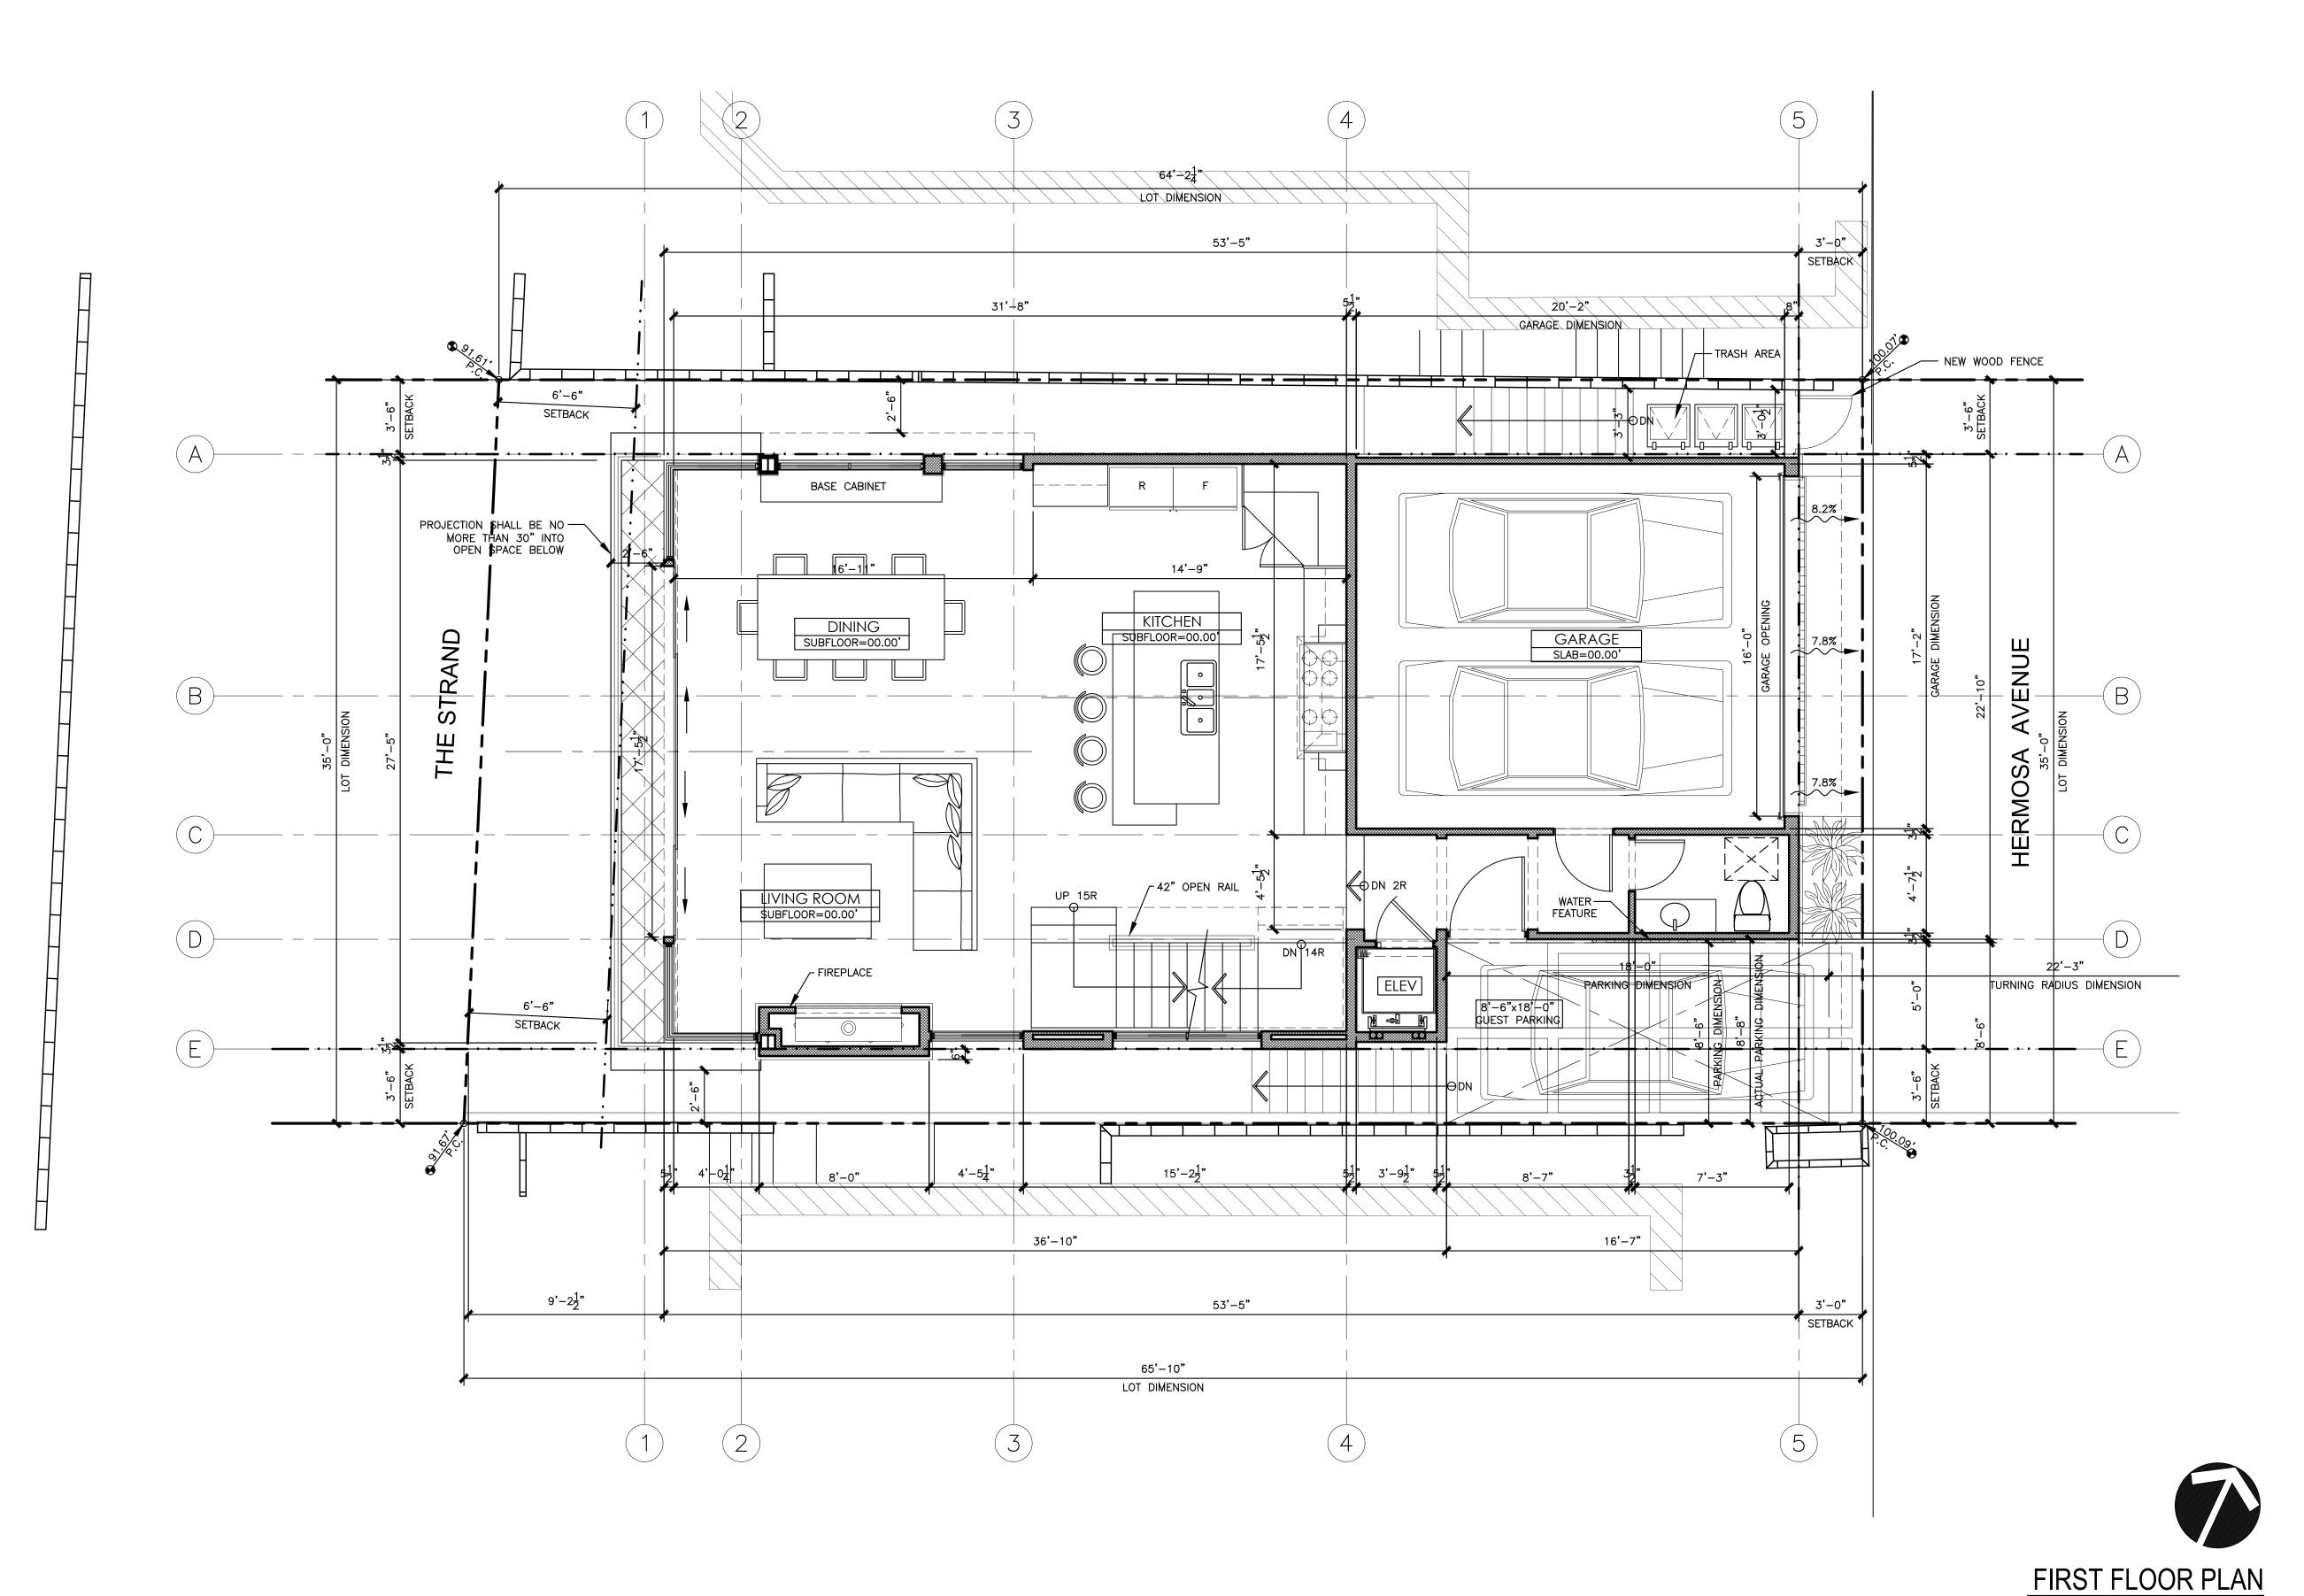
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FIRST FLOOR PLAN

A.03

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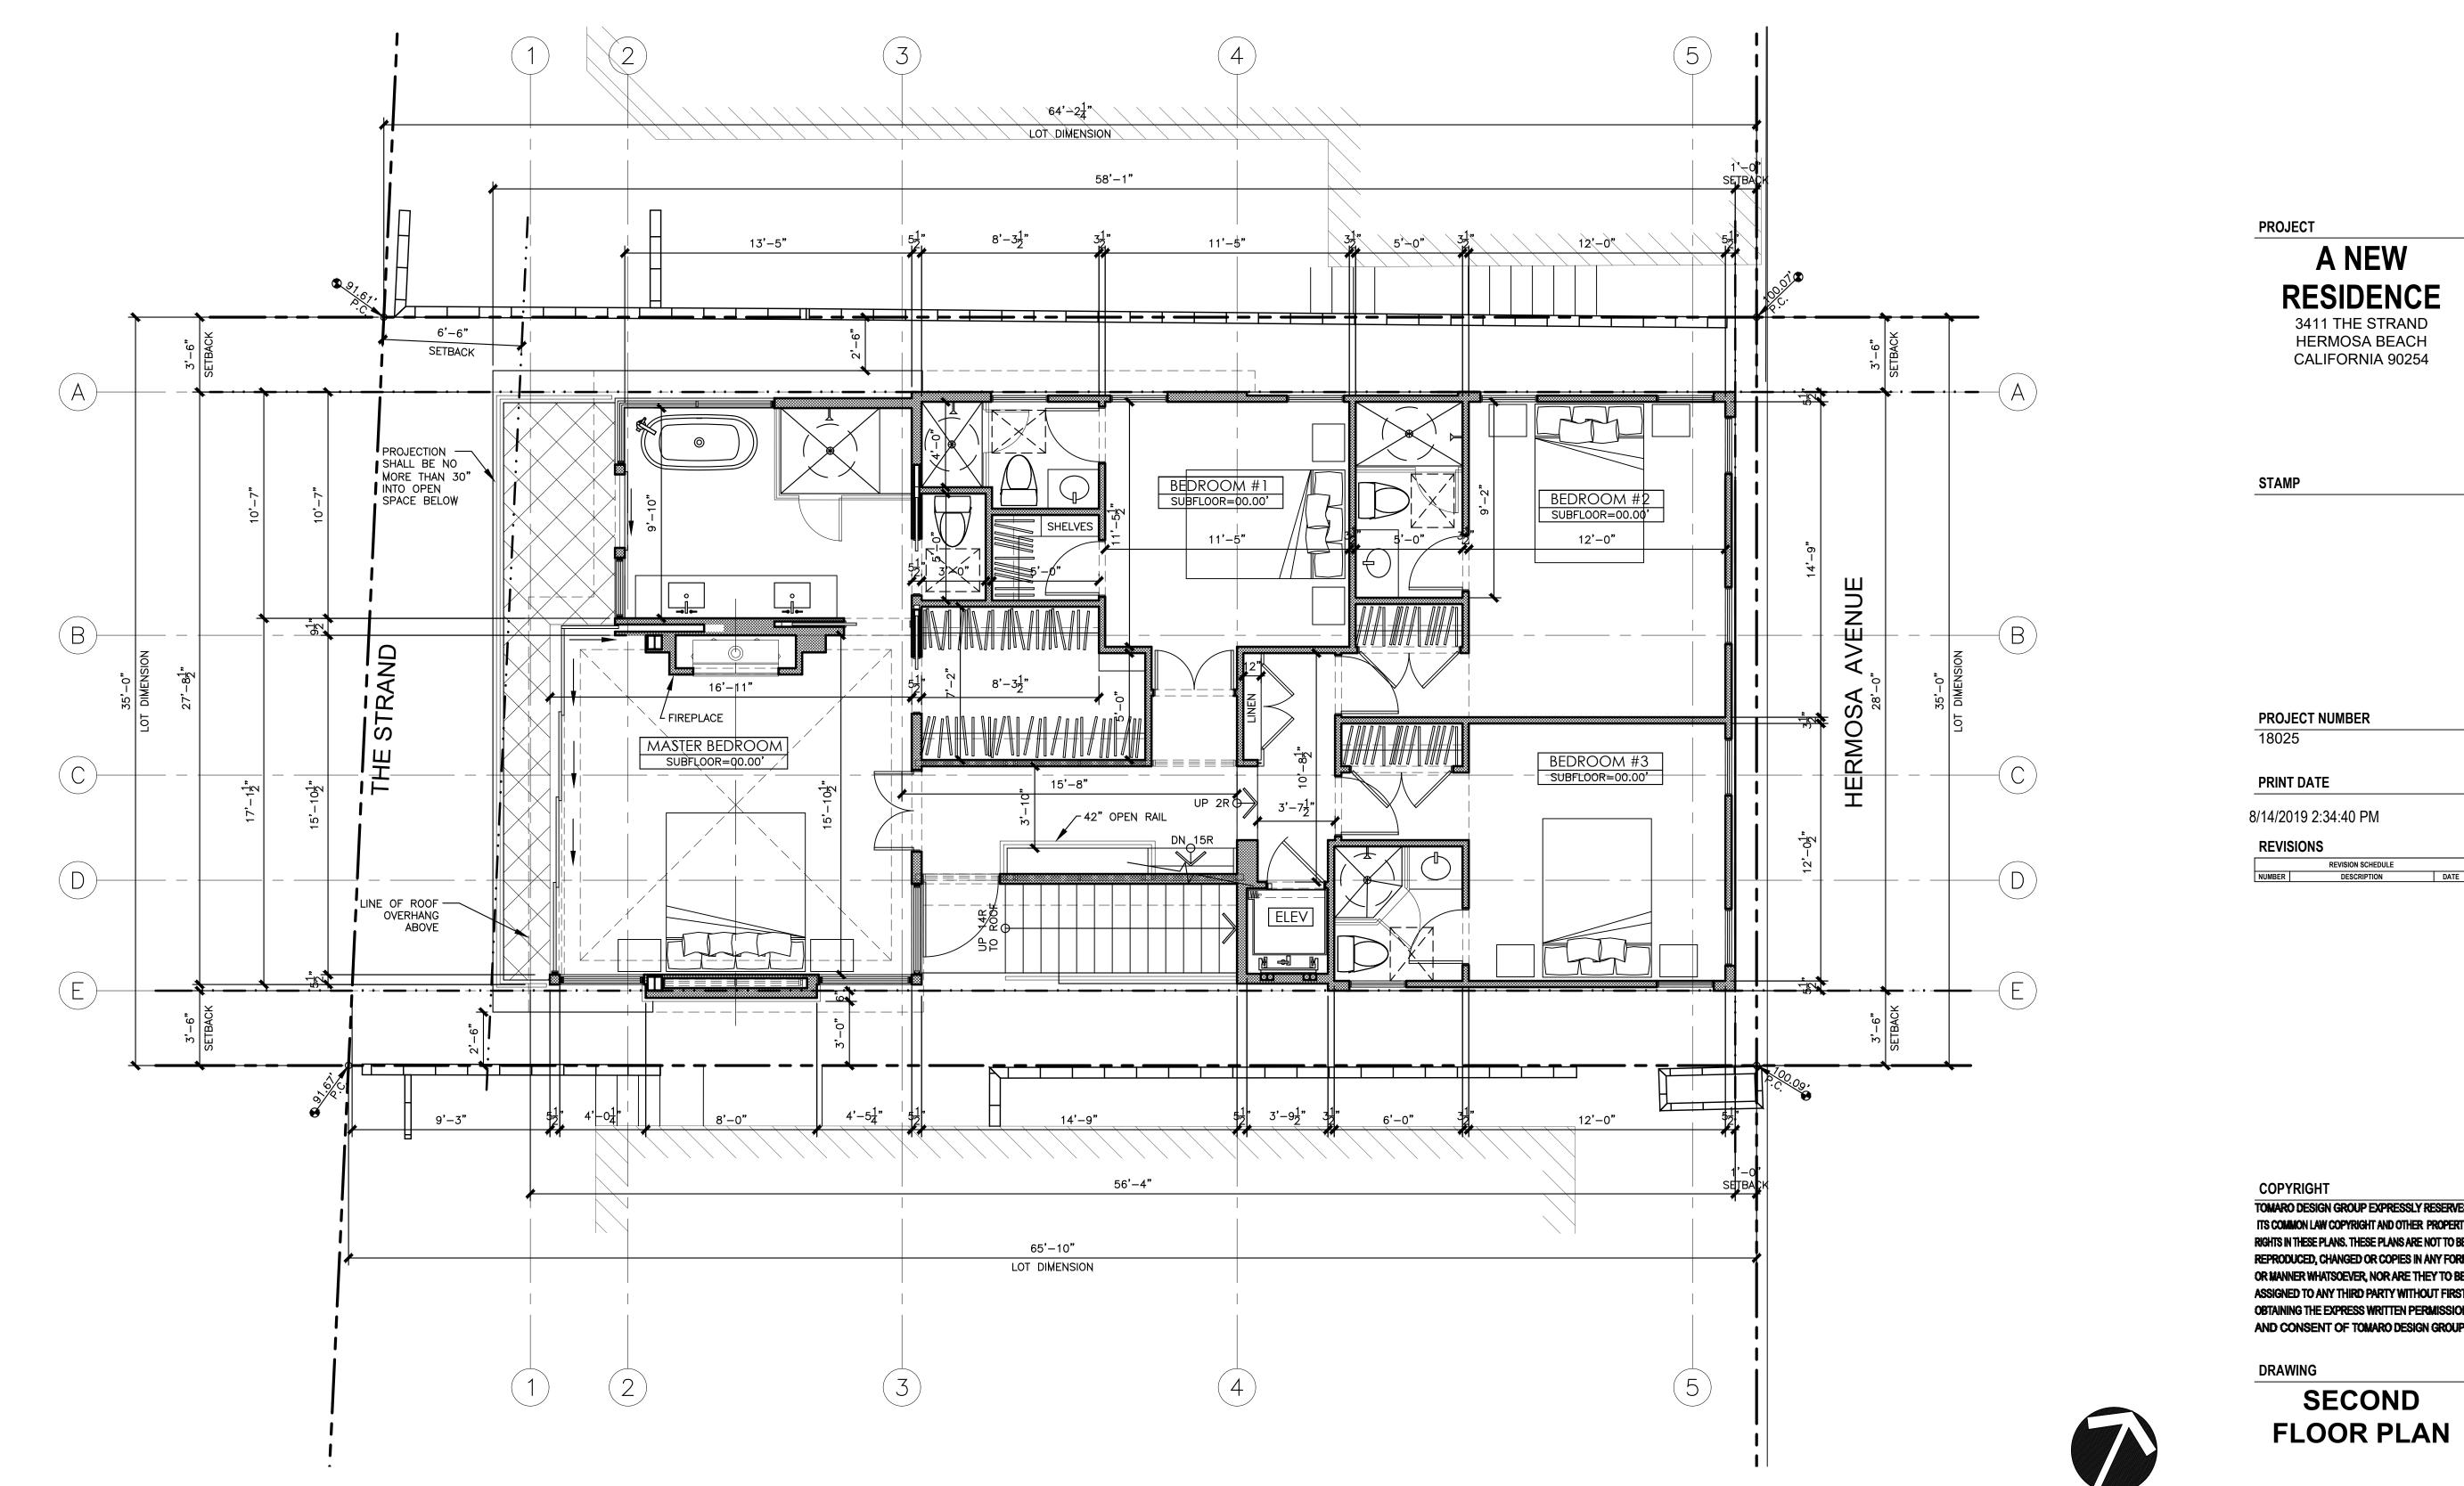
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PROJECT

A NEW RESIDENCE 3411 THE STRAND HERMOSA BEACH CALIFORNIA 90254







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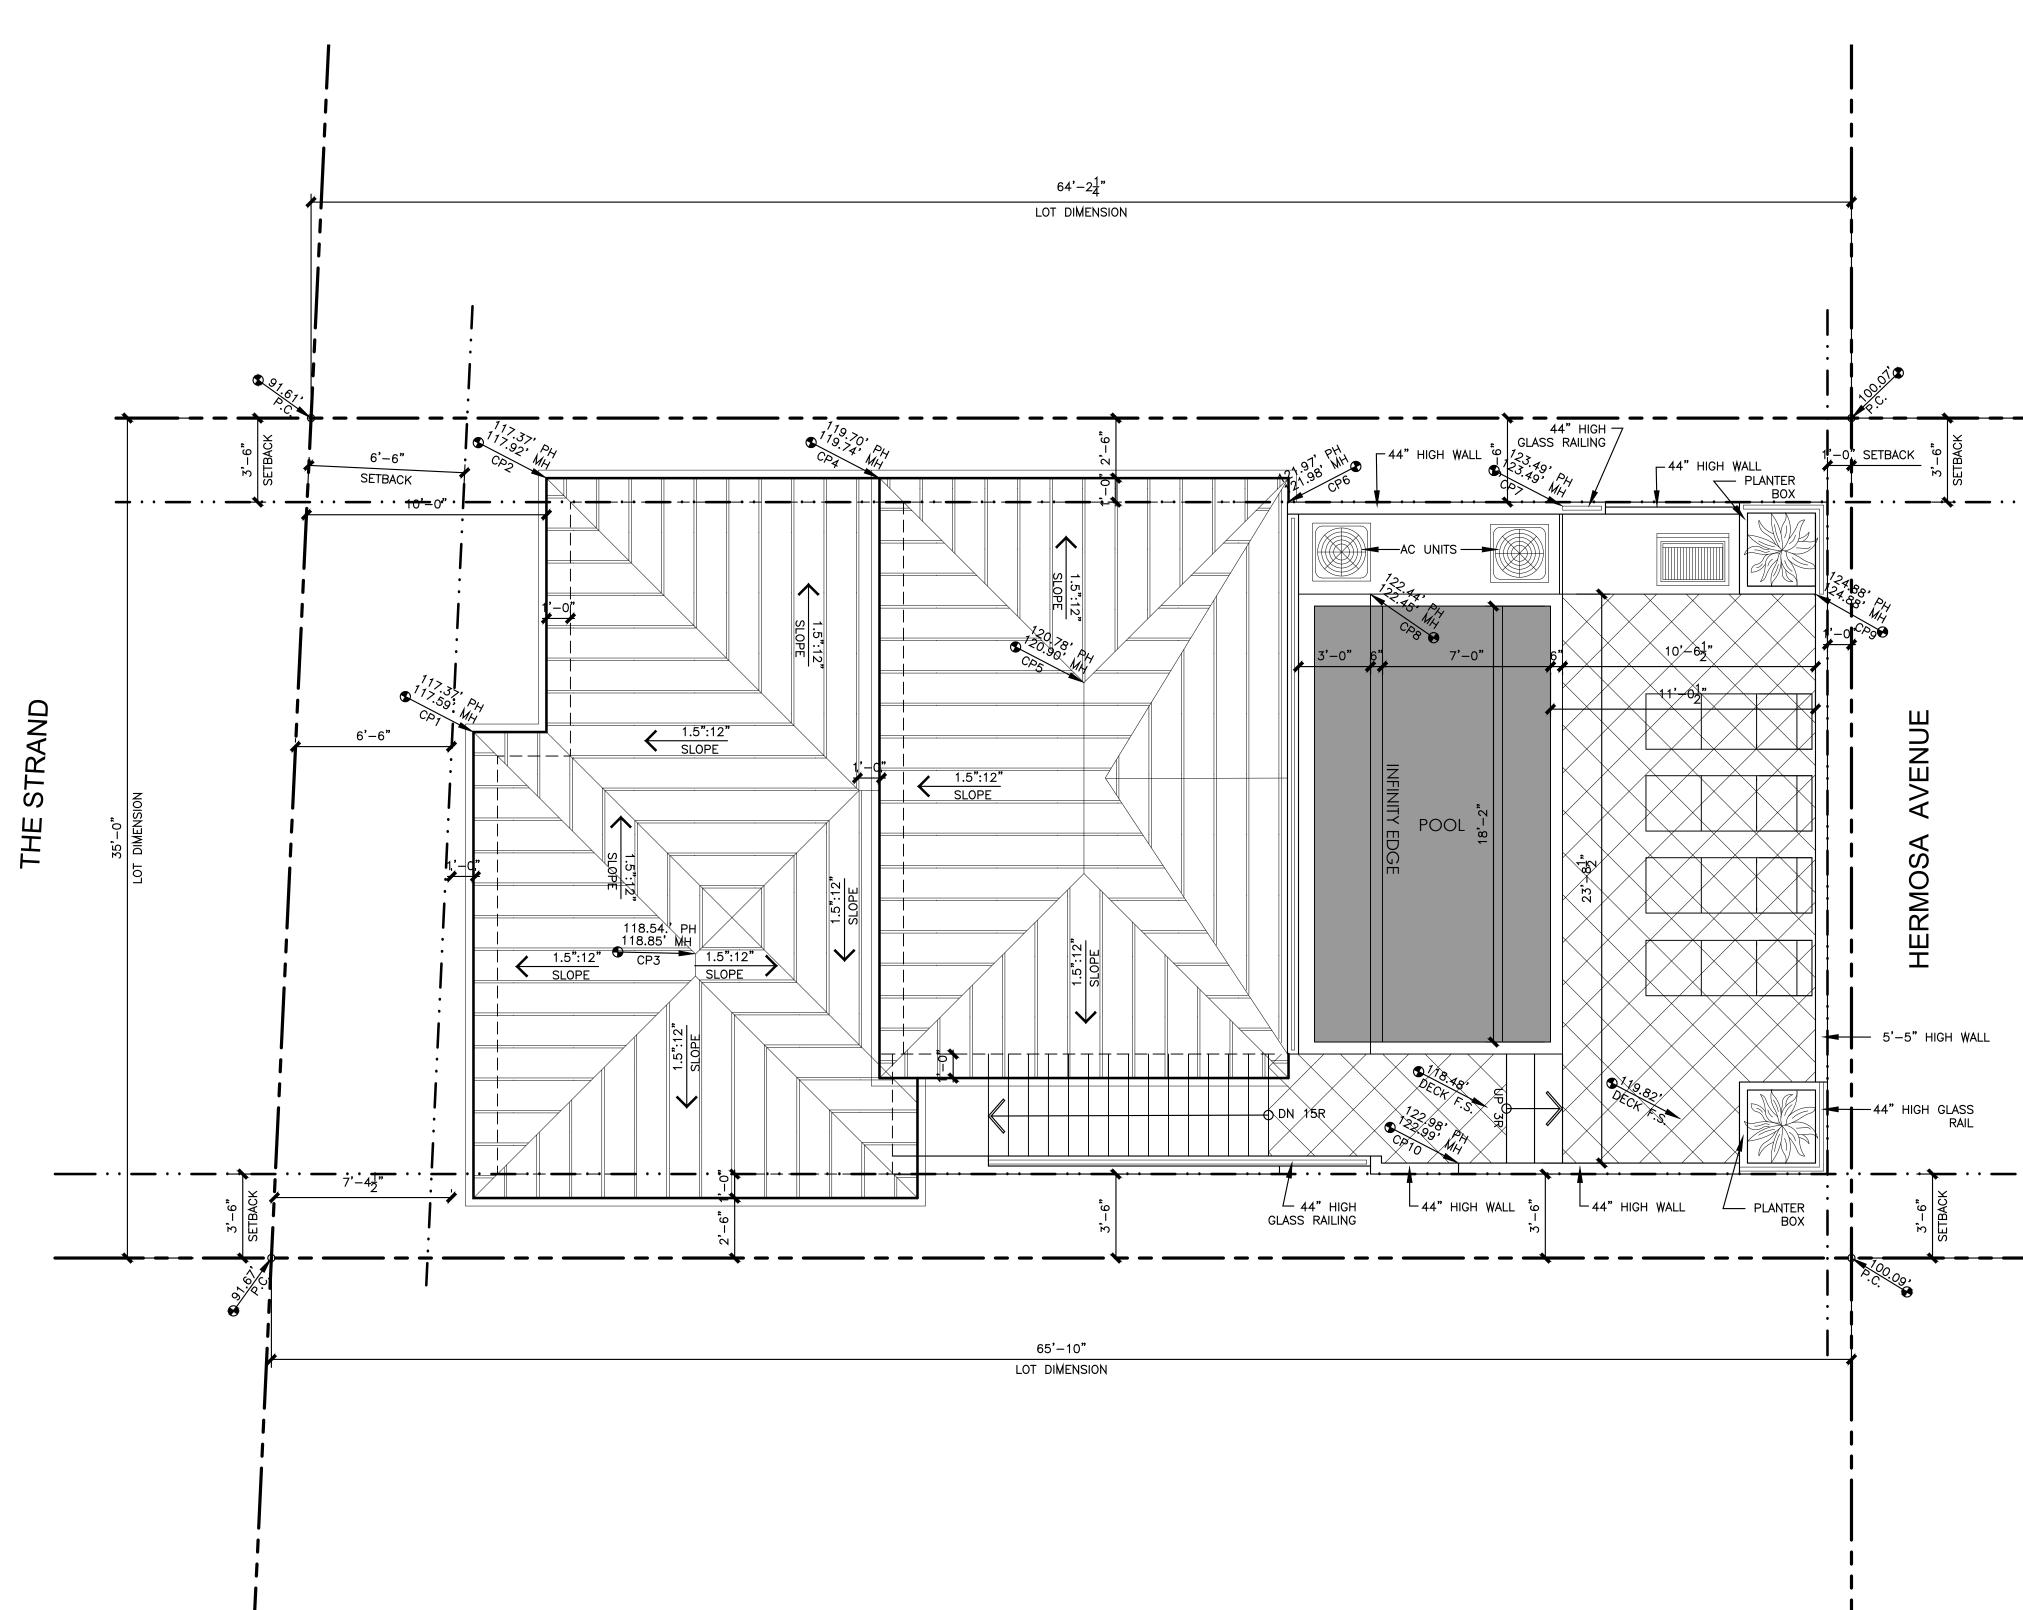
A.04

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SECOND FLOOR PLAN

SCALE: 1/4"=1'-0"

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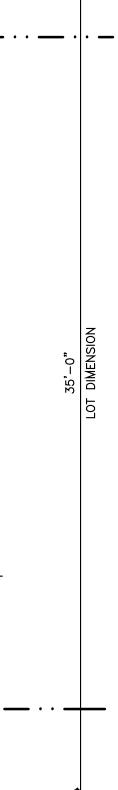


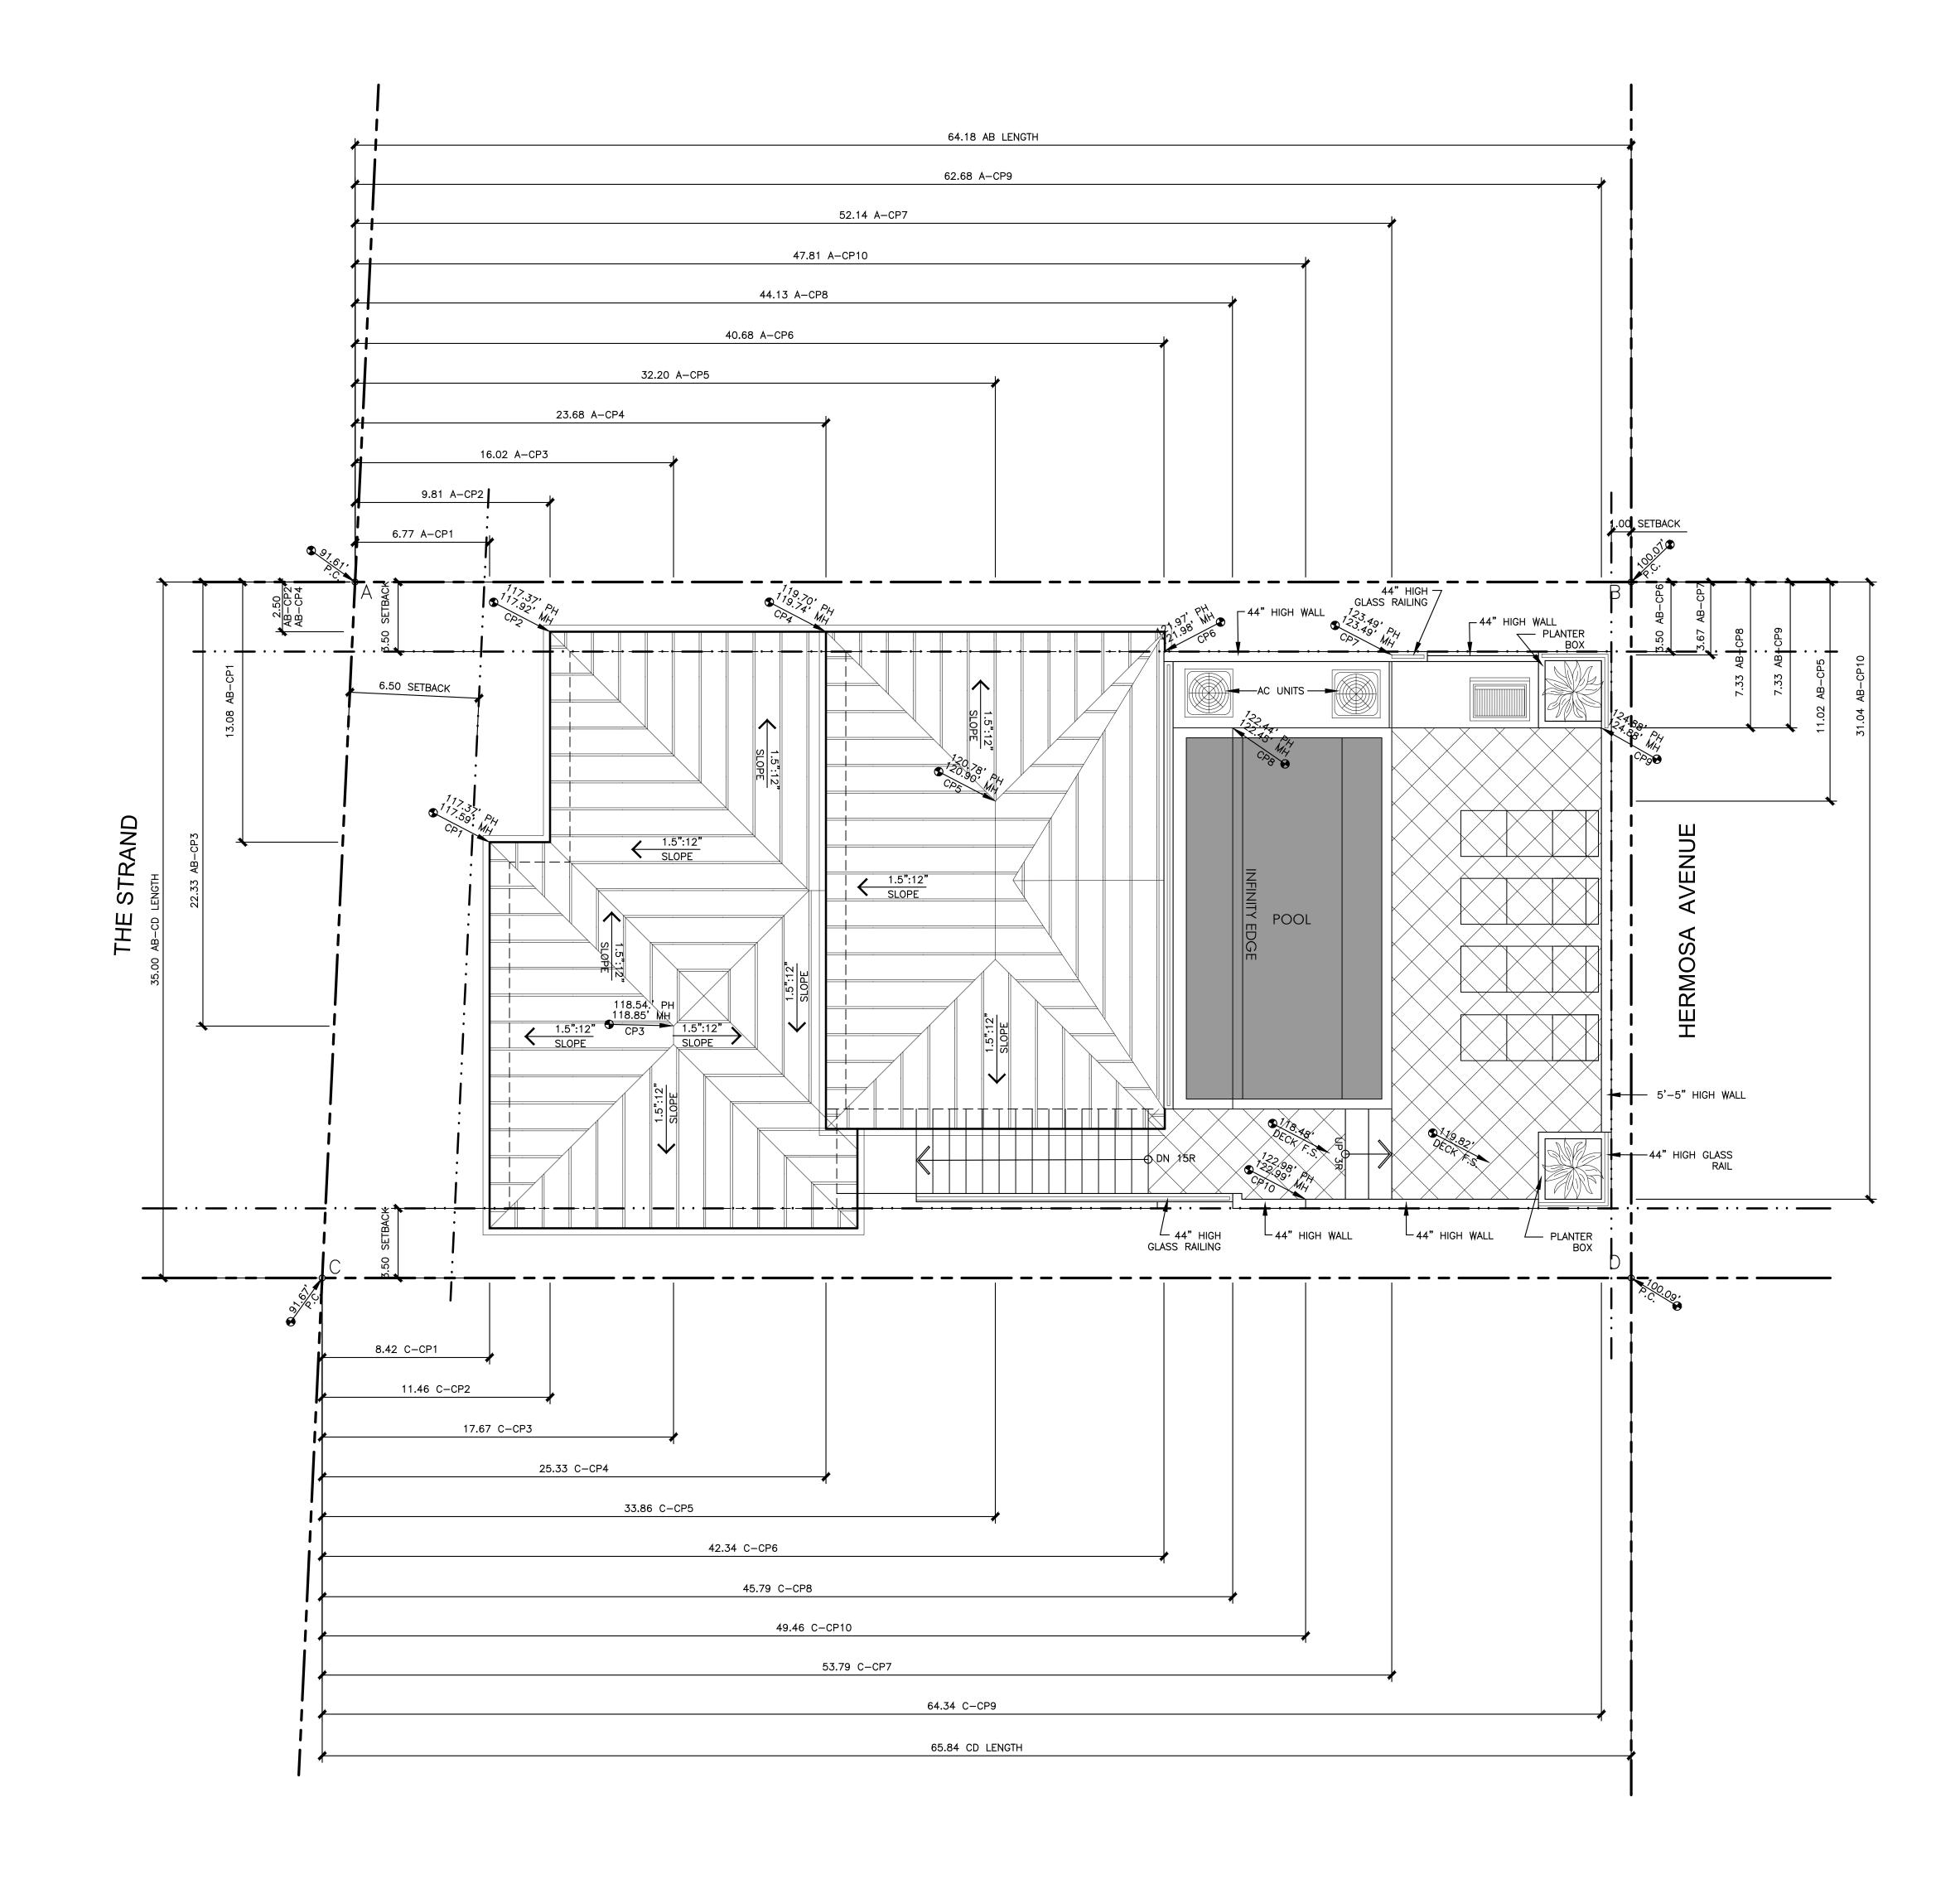
PROJECT



ARCHITECTURE

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CRITICAL POINT PLAN

DRAWING

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REVISIONS REVISION SCHEDULE NUMBER DESCRIPTION

DATE

8/14/2019 2:34:46 PM

18025

PRINT DATE

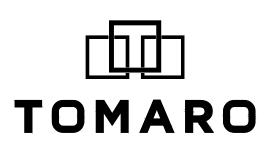
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3411 THE STRAND HERMOSA BEACH CALIFORNIA 90254

PROJECT A NEW RESIDENCE

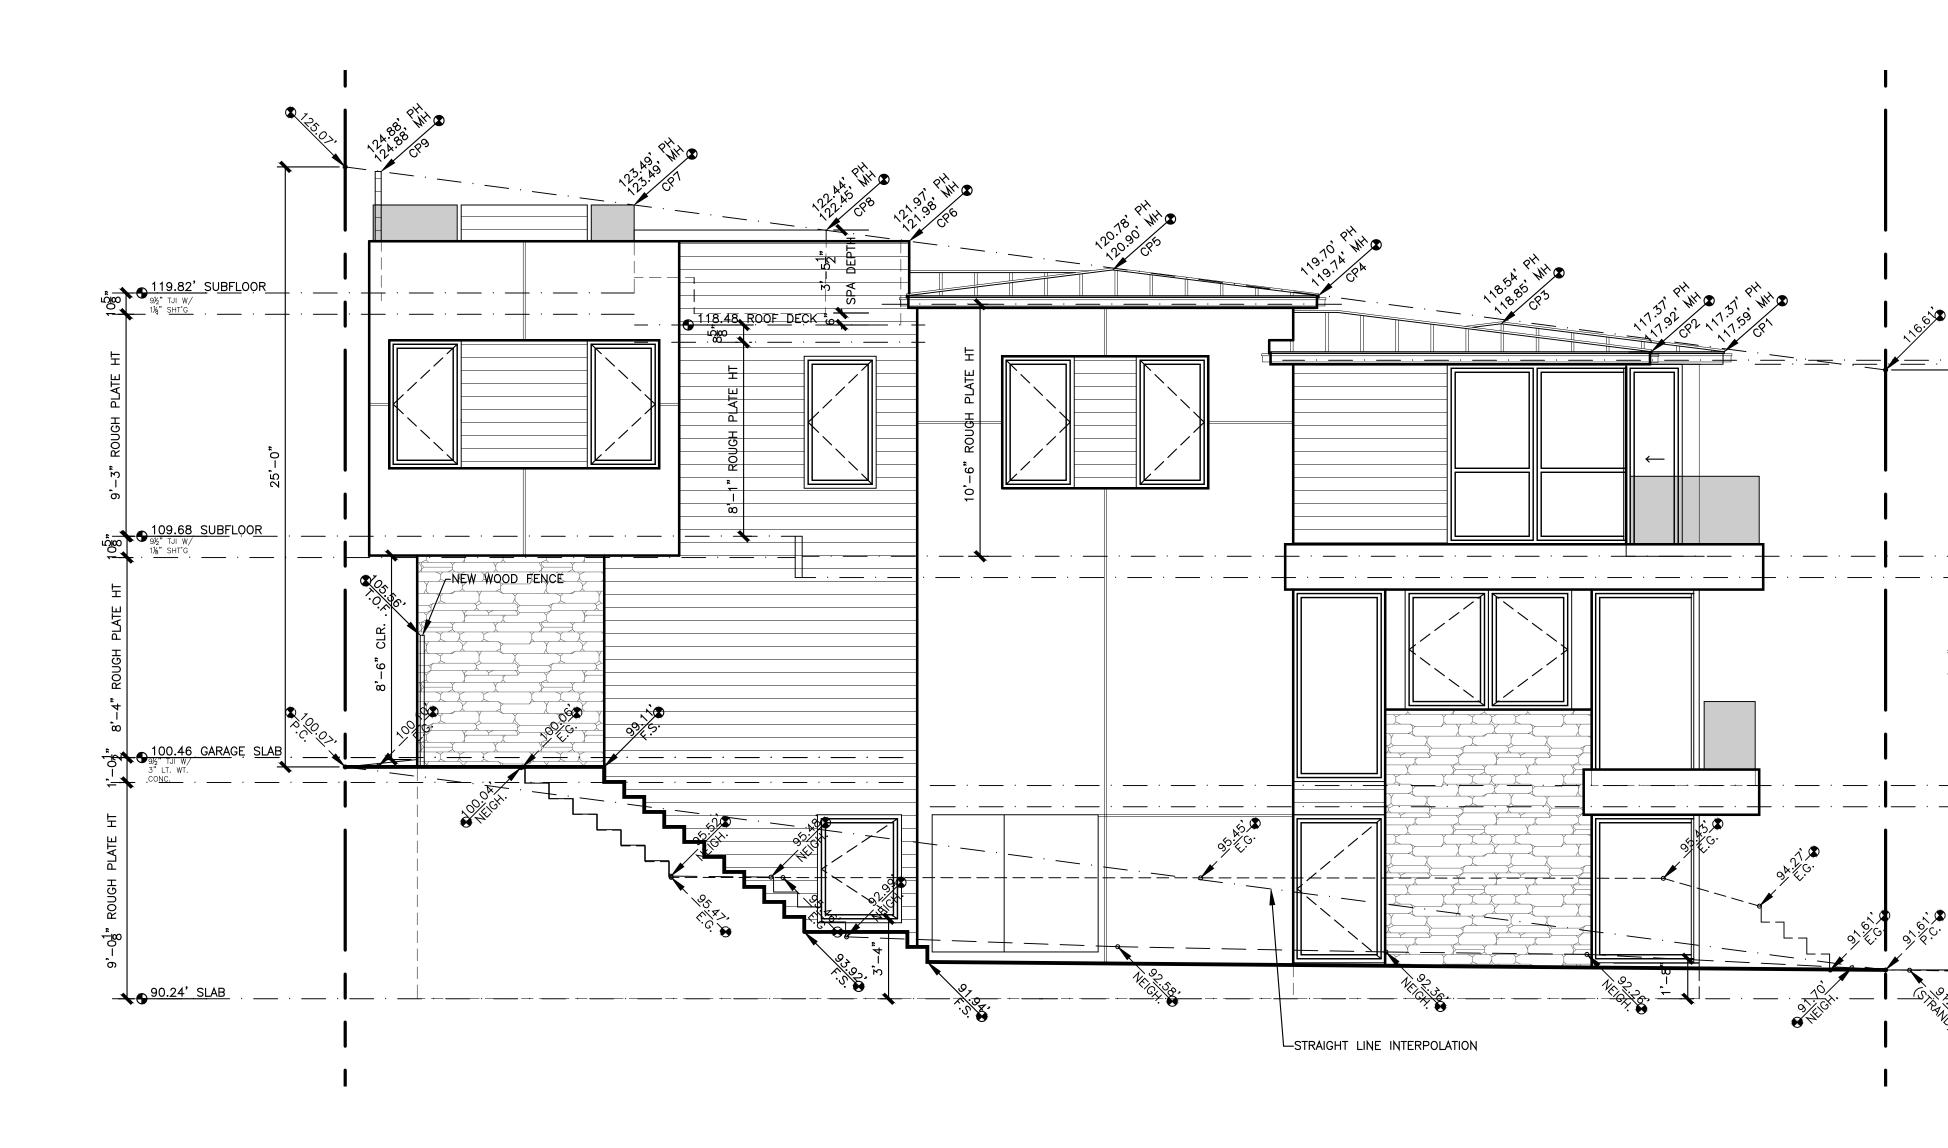
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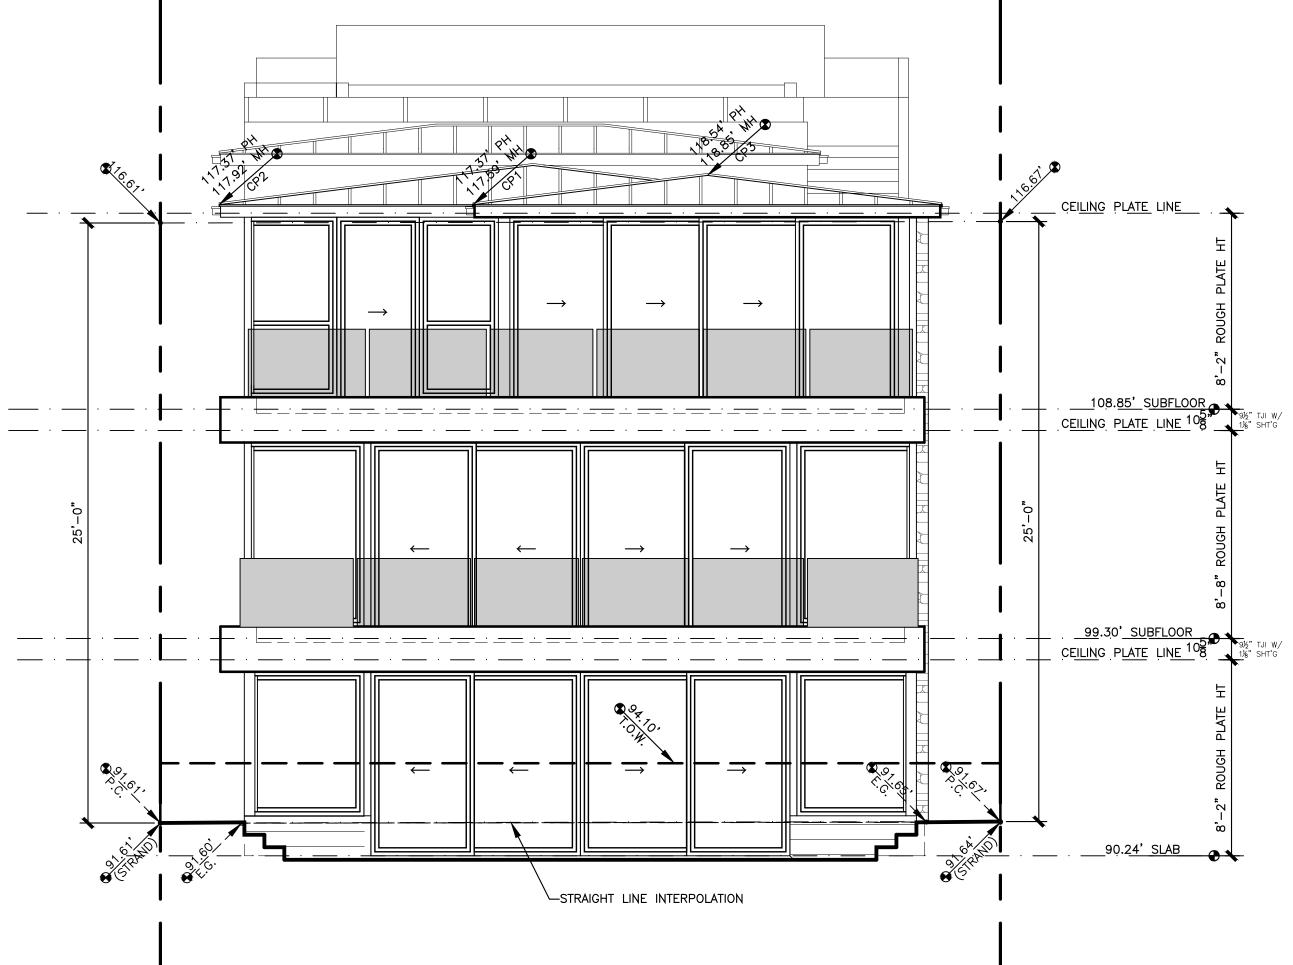


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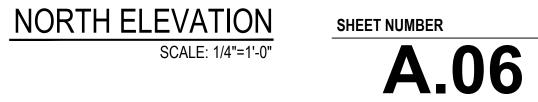
16.61

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108.85' SUBFLOOR CEILING PLATE LINE 105" 1%" SHT'G

99.30' SUBFLOOR

90.24' SLAB





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DATE

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PROJECT NUMBER

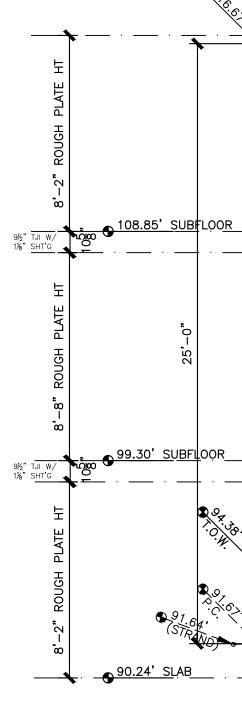
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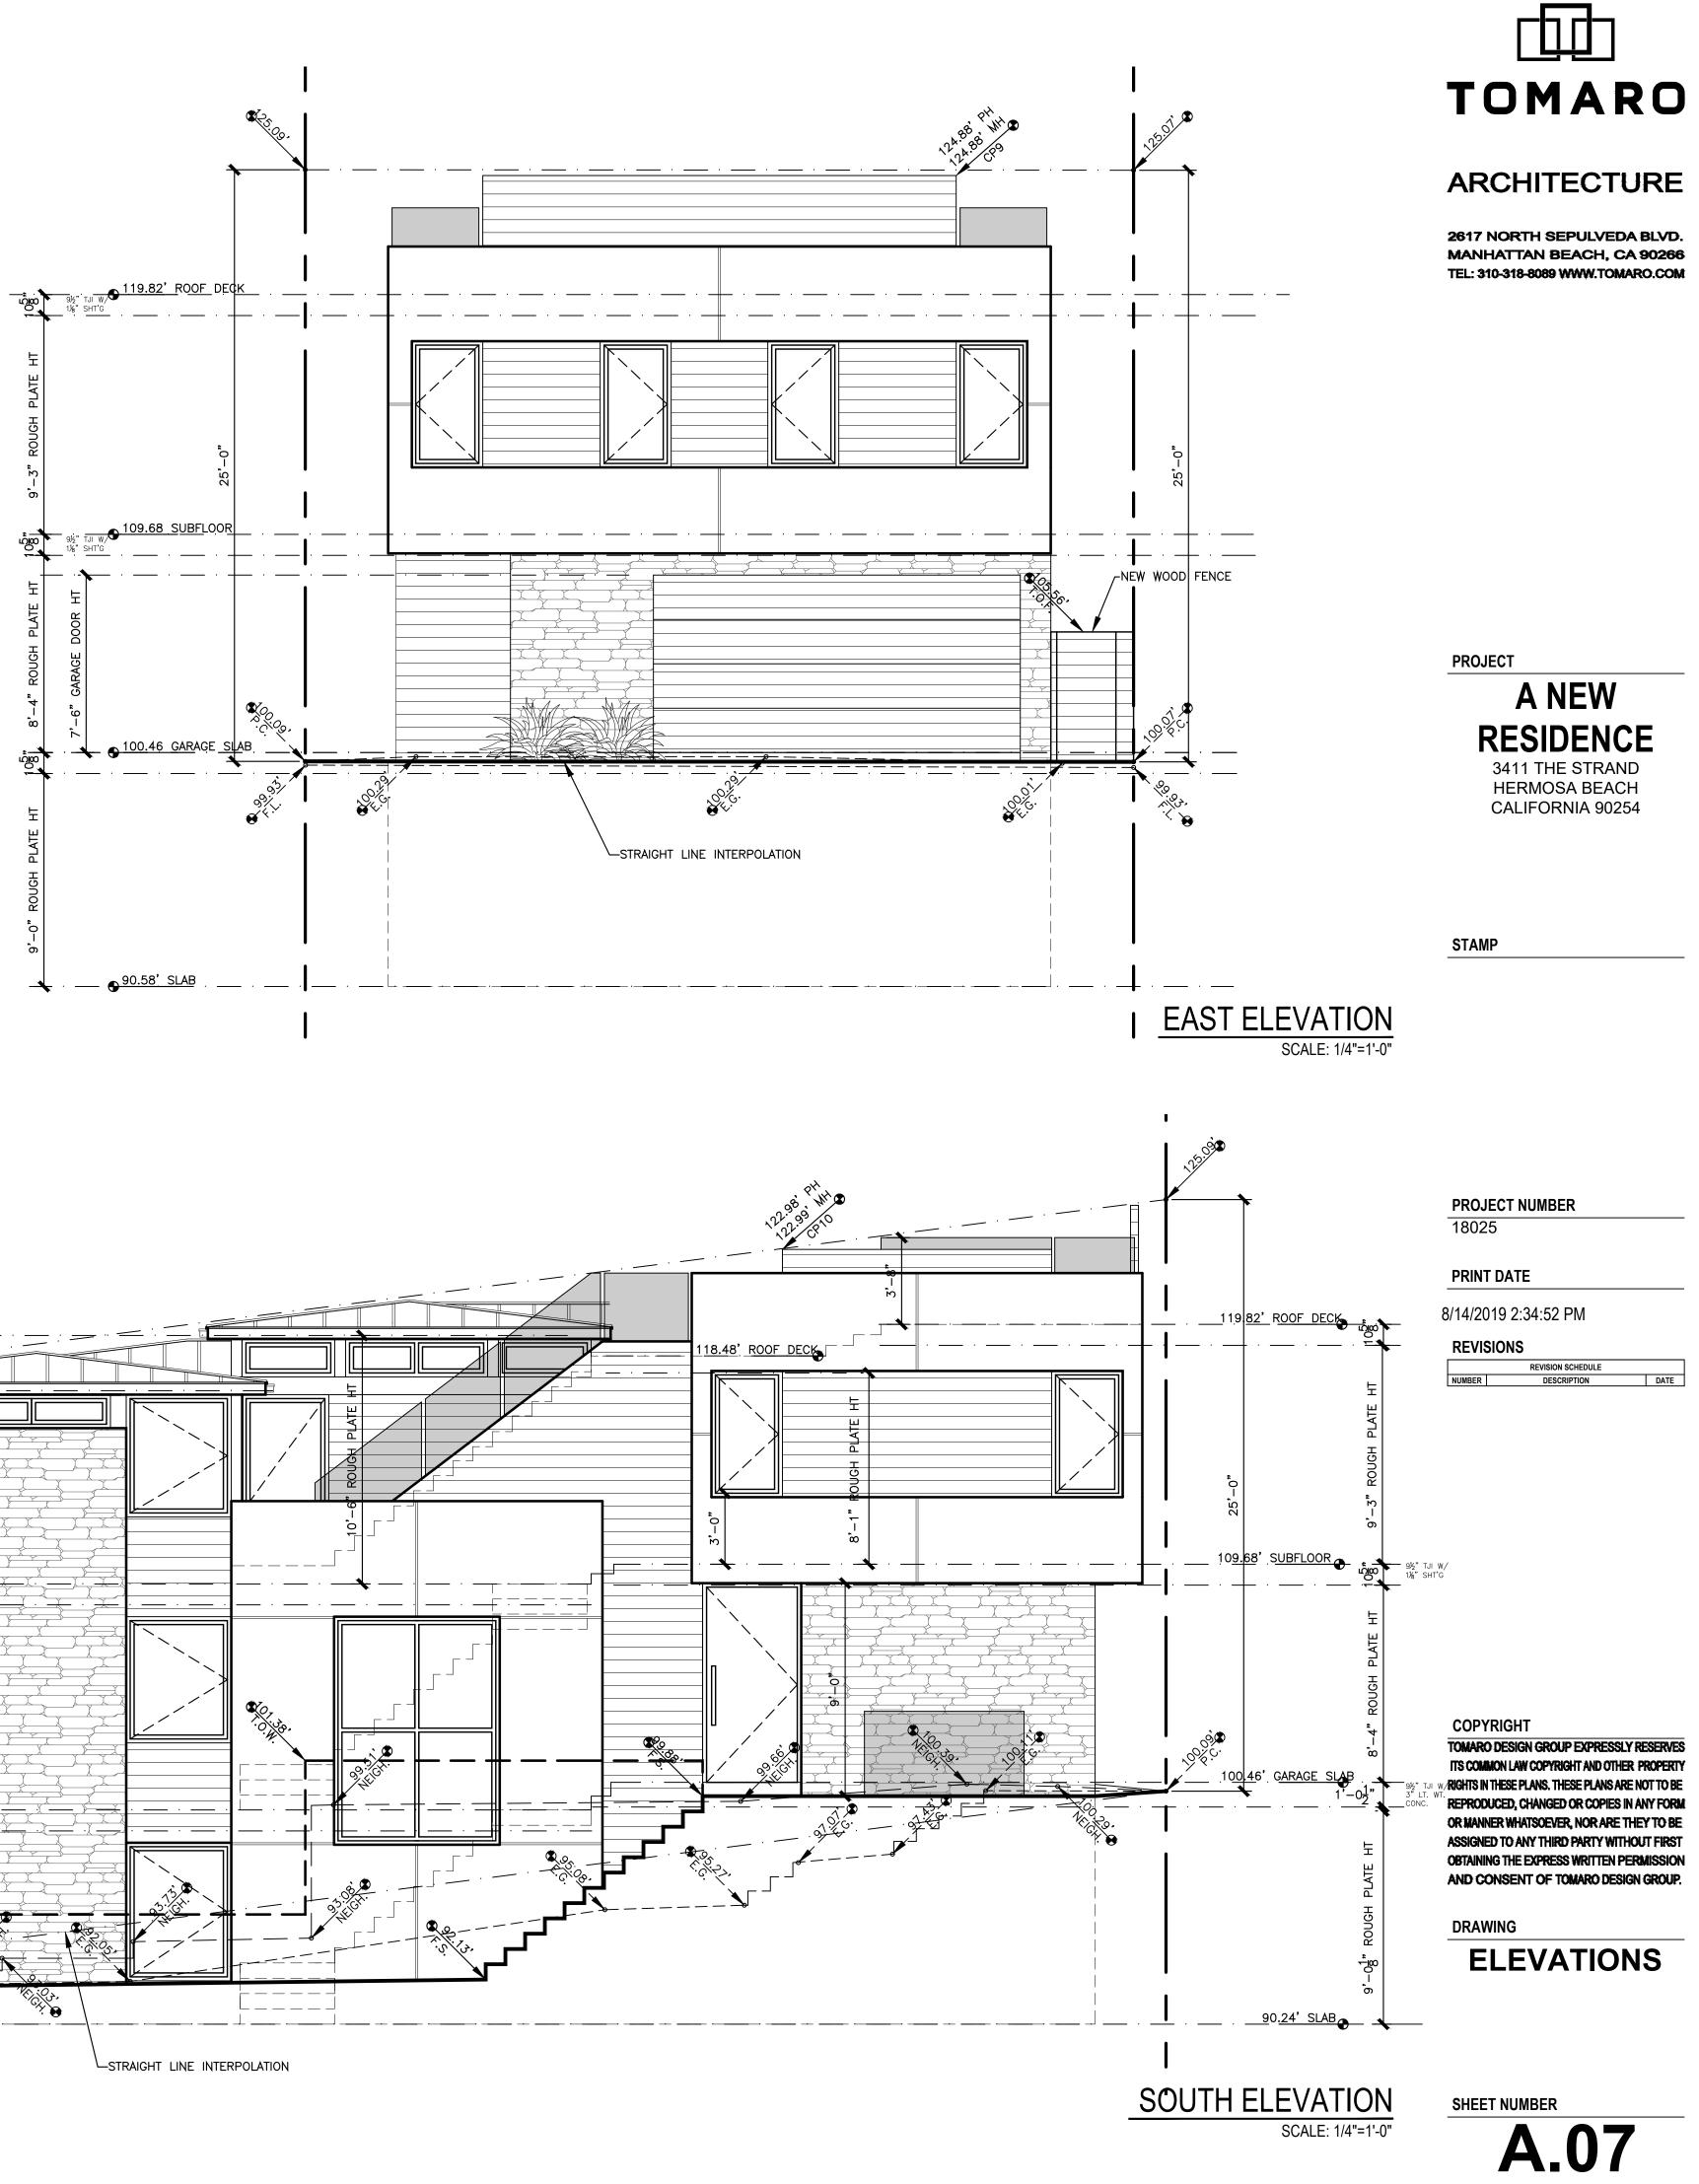


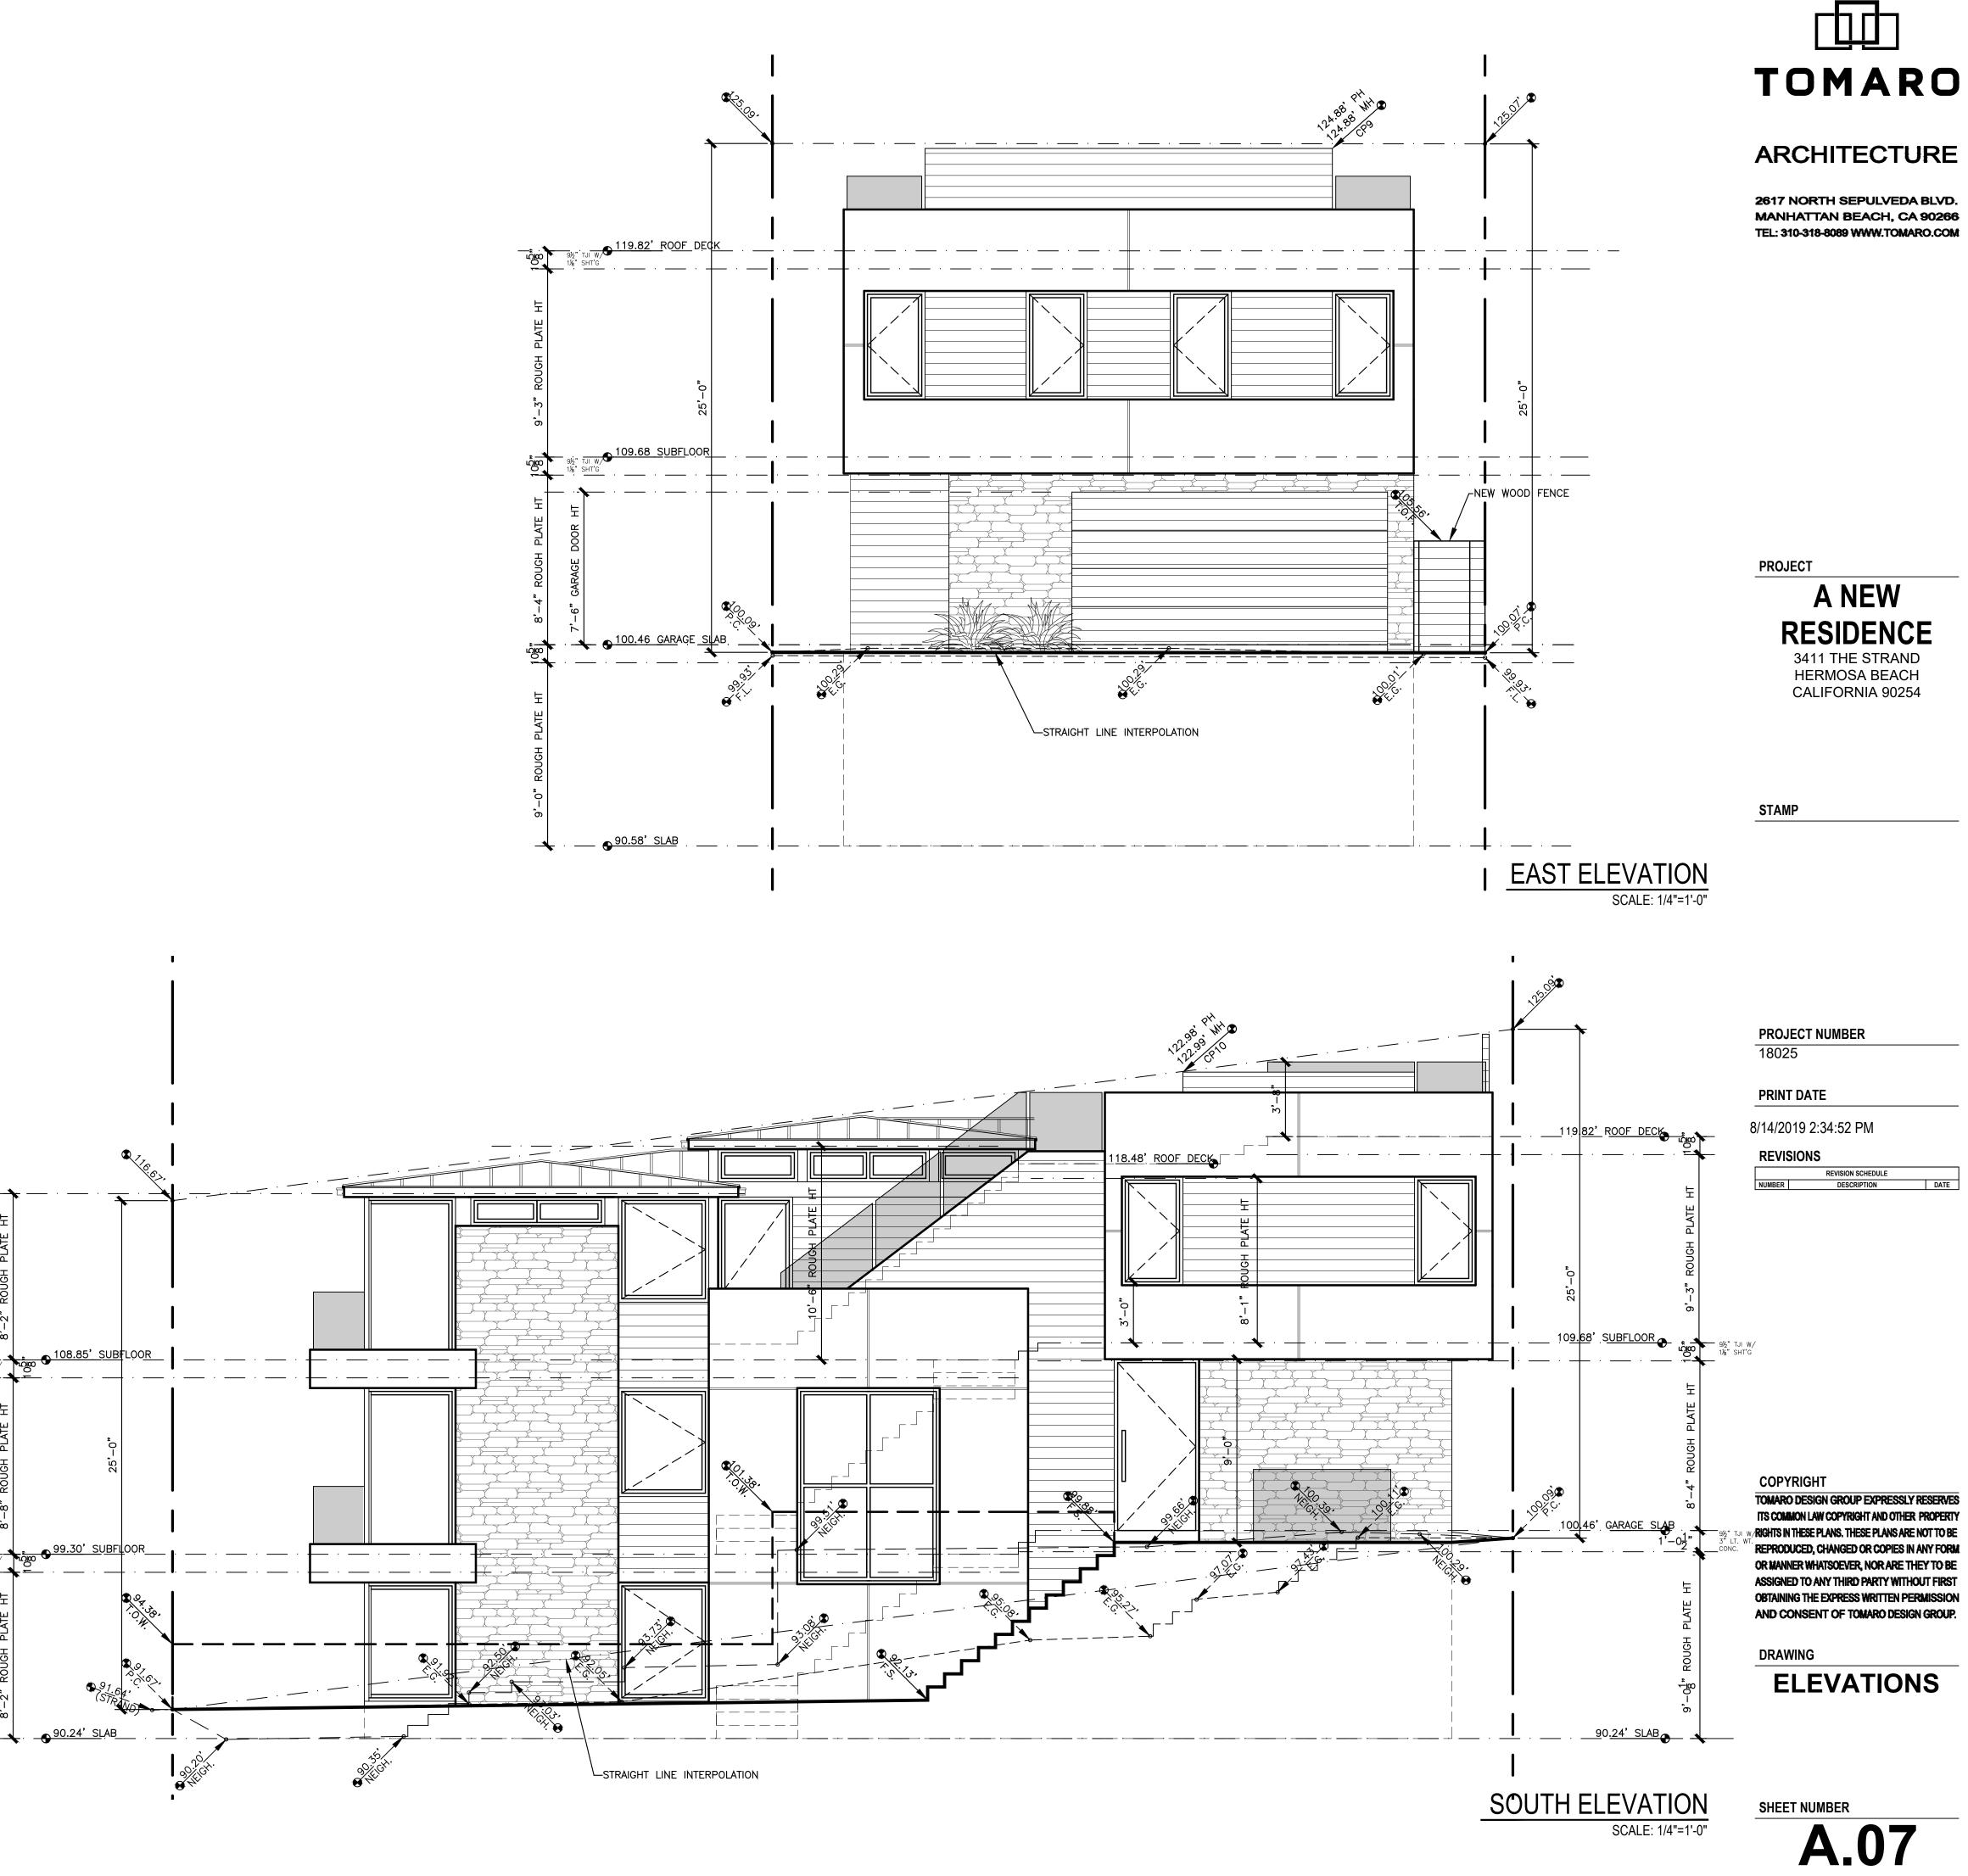
PROJECT A NEW **RESIDENCE** 3411 THE STRAND HERMOSA BEACH CALIFORNIA 90254

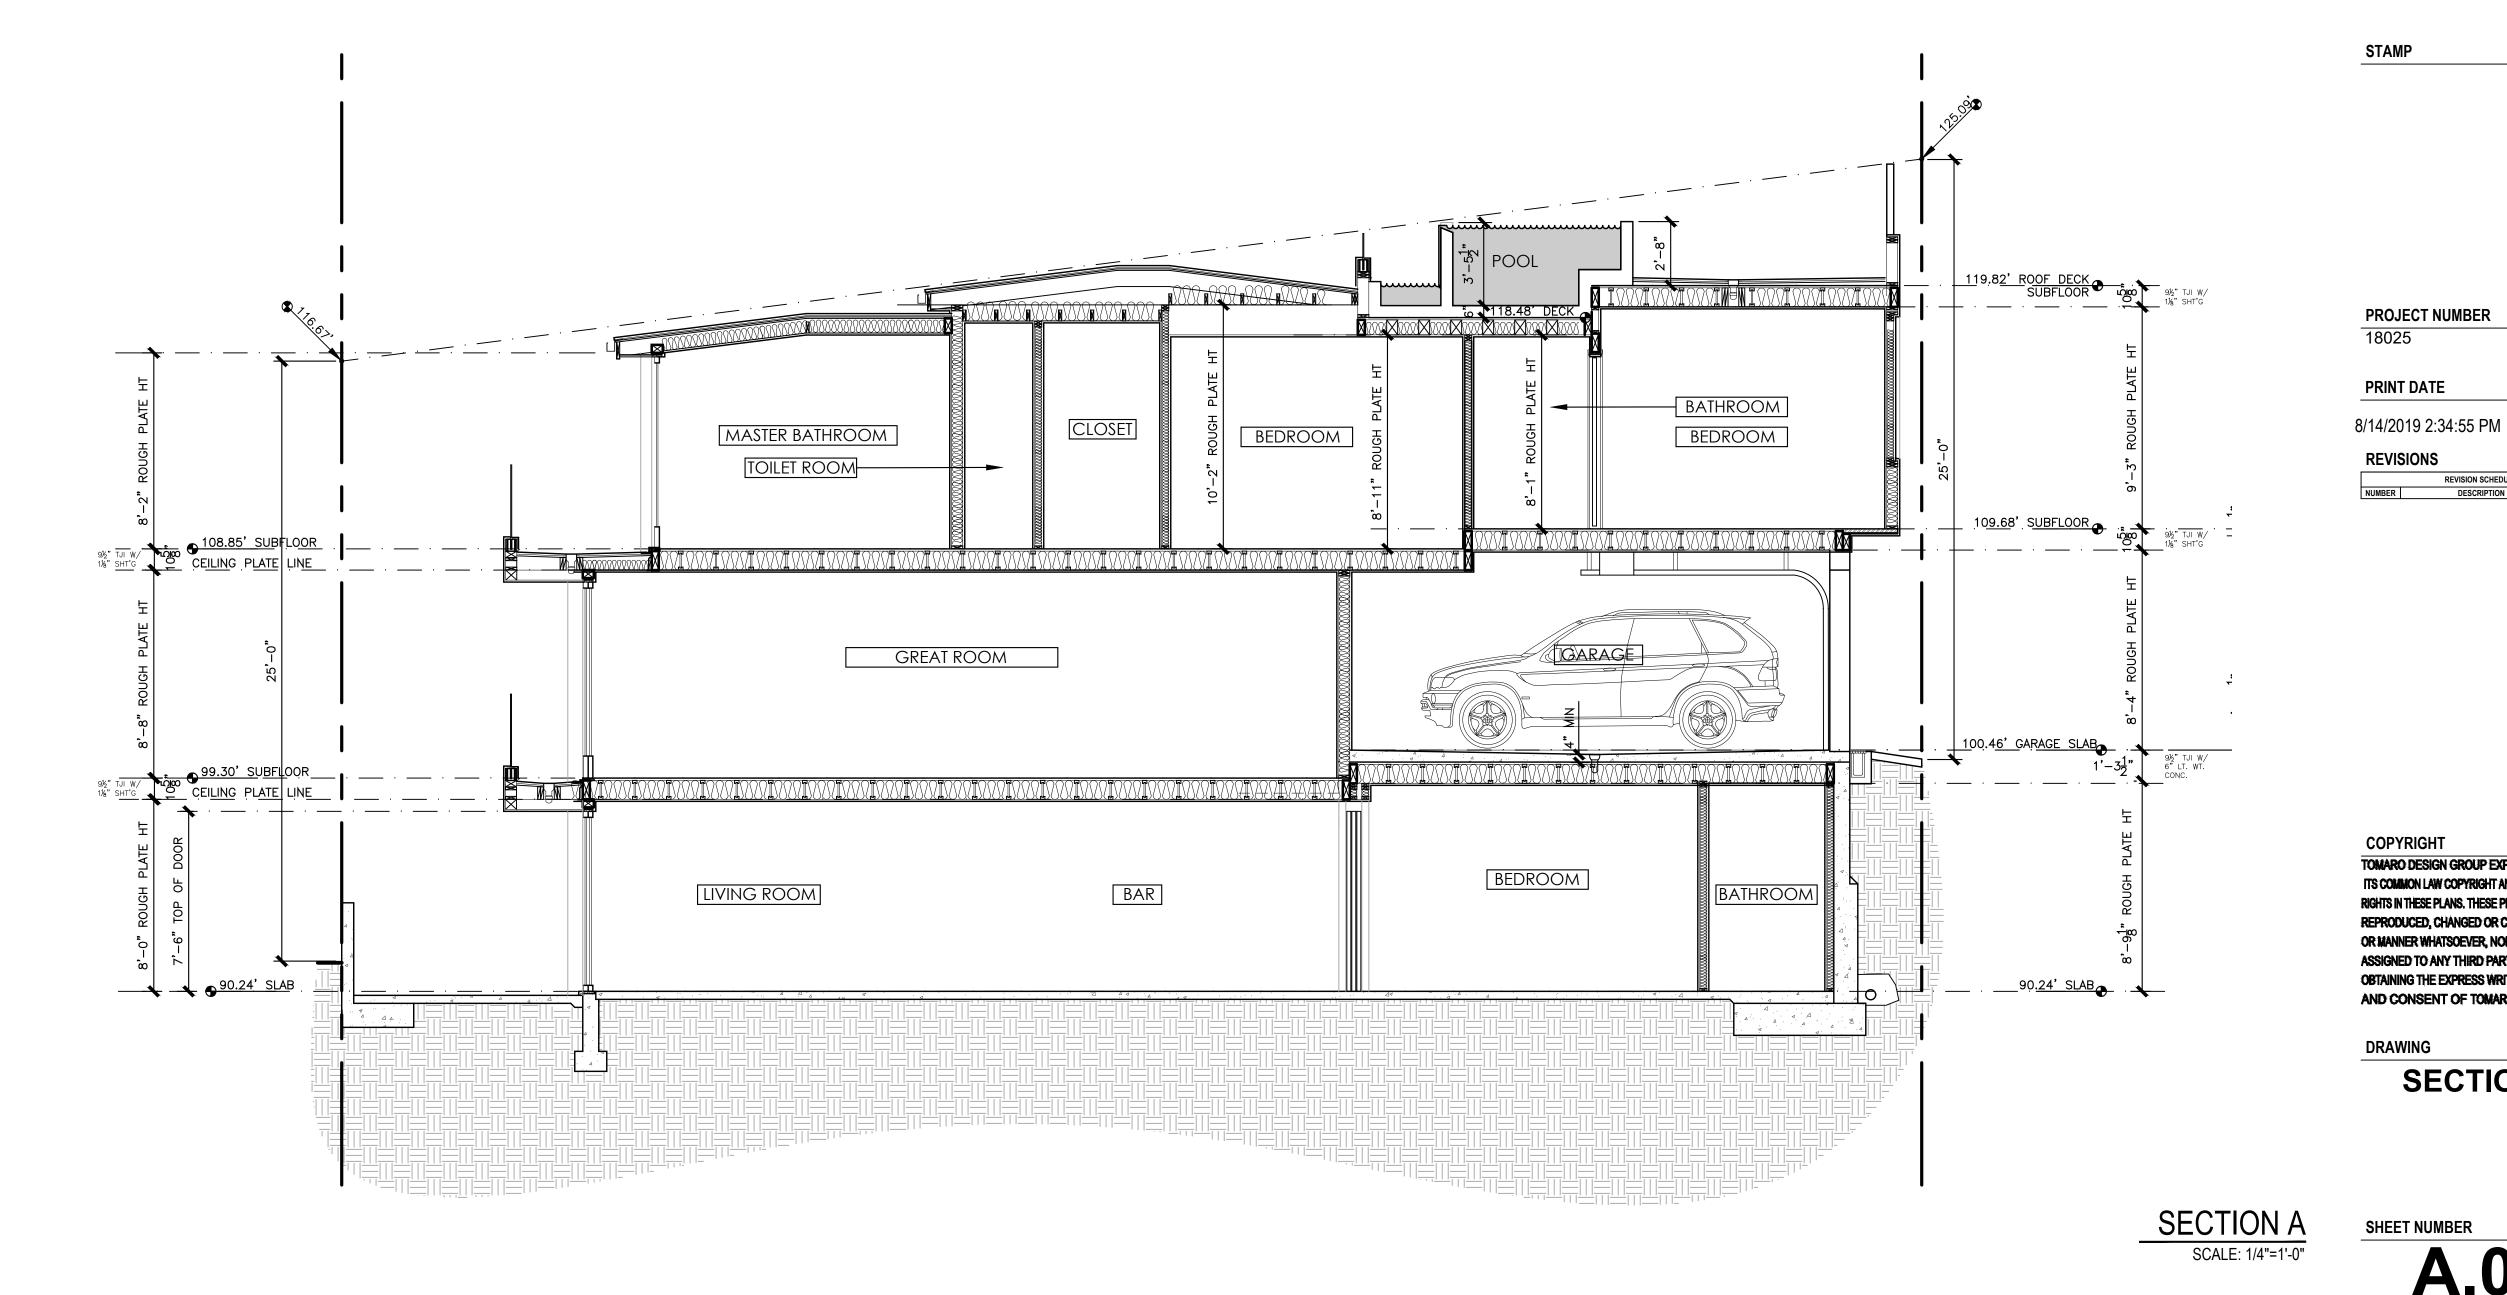


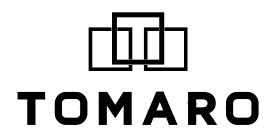
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DRAWING SECTIONS

80.A

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