NOTE:
PROVIDE ELECTRICAL CONDUITS FOR FUTURE SOLAR
INSTALLATION PER HBMC SECTION 15.32.140

NO PLUMBING WILL BE LOCATED IN COMMON WALLS (HBMC SECTION 17.46.010.B)

THIS PROJECT SHALL MEET STC 52 MIN.

(NW) 93.7 PC

123.33

123.33

CP2= 126.26' MAX.

CP1= 124.31' MAX

ACTUAL 123.83'-

—(SE) 99.6 PC

ACTUAL 125.50' PARAPET-

123.33

(SW) 93.8 PC/

—(NE) 96.8 PC

19' - 7"

—BALCONY ABOVĖ LINE

(NW) 93.7 PC

(SW) 93.8 PC/

10' - 4"

PROPERTY LINE 38.00'

7' - 0"

—BALCONY ABOVE LINE

Lot Coverage Plan

1/8" = 1'-0"

PROPERTY LINE 38.00'

24' - 3"

CONDUIT FROM ROOF TO ELECTRIC SERVICE PANEL WILL BE PROVIDED FOR EACH UNIT .

→ROOF →

16' - 3"

◄—R00F—**▶**

16' - 3"

16.25'

6' - 6"

17' - 11"

UNIT "B" ROOF DECK

16' - 5"

UNIT "A" ROOF DECK

35' - 0 1/2"

SETBACK

1' - 4"

(METAL AWNING)

---(SE) 99.6 PC

drive way section

see civil plan

413 SQ.FT.

2'-0" CHIMNEY HEIGHT PER

PROPERTY LINE 38.00

MANUFACTURER ----

◄—R00F——▶

PROPERTY LINE 38.00'

-(NE) 96.8 PC

(METAL AWNING)


SITE NOTES:

1. ALL UTILITIES SHALL BE UNDERGROND, CONTACT SOUTHERN CALIFORNIA EDISON FOR THEIR REVIEW

2. ALL SITE DRAINAGE SHALL BE TERMINATED AT PUBLIC WAY VIA NON-EROSIVE DEVISE, PER HBMC.

3. DRAINAGE FIXTURE LOCATED BELOW THE NEXT UPSTREAM MANHOLE OR BELOW THE MAIN SEWER LEVEL REQUIRES INVESTIGATION TO ASCERTAIN THE NECESSITY FOR SEWER BACKWATER DEVICE INSTALLATION. CONTRACTOR TO VERIFY PRIOR TO CONSTRUCTION

NOTE: PROPERTY LINE SHOWN ON PLANS ARE SQUARED FOR CLARITY, CONTRACTOR SHALL REFER TO CIVIL SURVEY PLAN FOR EXACT PROPERTY LINE BOUNDARIES. NOTIFY ARCHITECT FOR ANY DISCREPANCIES. CONTRACTOR SHALL MEET ALL MINIMUM SETBACKS INDICATED PER PLAN

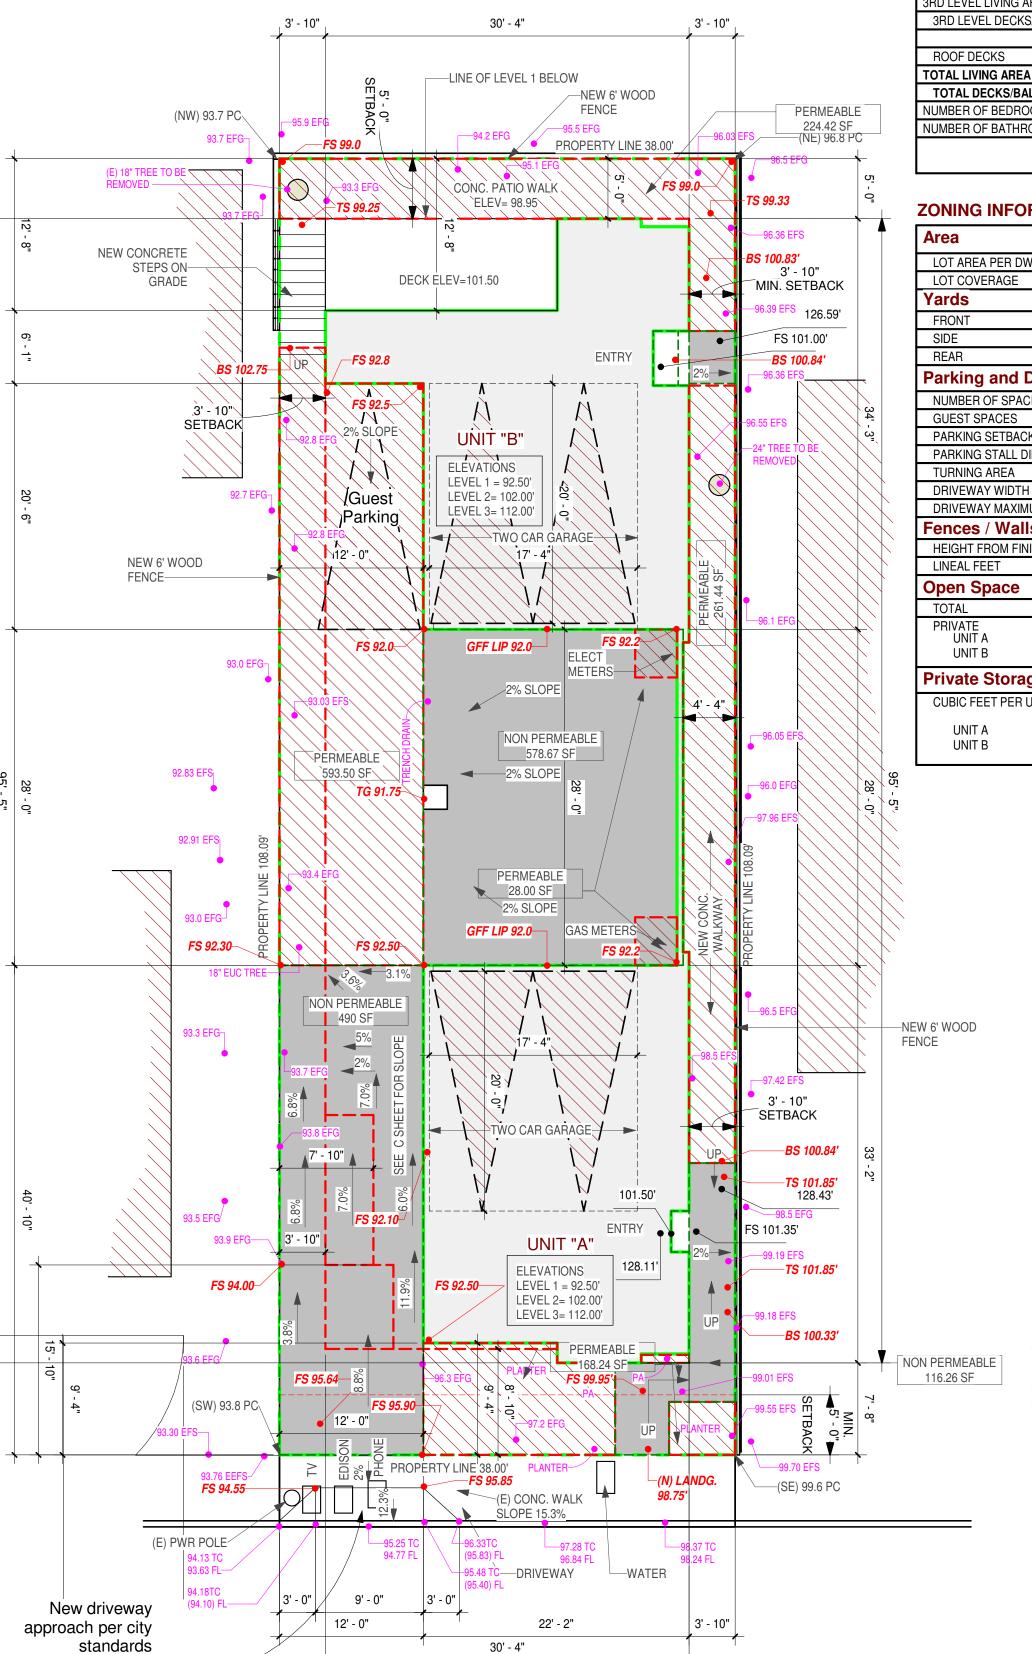

DEVELOPMENT PROGRAM

PROJECT LOCATION	N: 645 10TH STRE	EET HERMOSA BEACH, CA
OWNERS NAME:	MARK SLUSARZ	TEL
ADDRESS		
LEGAL DESCRIPTI	ON: <u>APN= 4187-026-024</u>	
LOT 4. BLOCK 78. SECOND A	DDITION TO HERMOSA BEACH	TRACT. IN THE CITY OF HERMOSA

BEACH, COUNTY OF LOS ANGELES, STATE OF CALIFORNIA, AS PER MAP RECORDED IN BOOK 3, PAGES 11 & 12 OF MAPS, IN THE OFFICE OF THE COUNTY RECORDER OF SAID COUNTY.


ZONING R2

GENERAL BUILDING INFORMATION

LOT AREA = 4,107.19 SQ.FT.	Total Building Area		7,034 Sq.Ft.	
	UNIT A	UNIT B		
1ST LEVEL LIVING AREA	273	406		
GARAGE	378	378		
2ND LEVEL LIVING AREA	1281	1274		
2ND LEVEL DECKS/BALCONIES	50	147		
3RD LEVEL LIVING AREA	1050	1020		
3RD LEVEL DECKS/BALCONIES	301	293		
ROOF DECKS	413	413		
TOTAL LIVING AREA	2604	2700		
TOTAL DECKS/BALCONIES	764	853		
NUMBER OF BEDROOMS	4	4		
NUMBER OF BATHROOMS	3.5	3.5		

ZONING INFORMATION	Required	Provided
Area		
LOT AREA PER DWELLING UNIT	4107/2= 2,166 SF	
LOT COVERAGE	4107.19 SF X 65% = 2,669.67	2,605 63%
Yards	-	-
FRONT	5'	5'
SIDE	3.8'	3'-10"
REAR	5' / 3'	5' / 3'
Parking and Driveway		
NUMBER OF SPACES	4	4
GUEST SPACES	1	1
PARKING SETBACK		
PARKING STALL DIMENSION	17x20	17' x 20'
TURNING AREA	24'	24'
DRIVEWAY WIDTH	9'	12'
DRIVEWAY MAXIMUM SLOPE	12.5% MAX	12.3 %
Fences / Walls		
HEIGHT FROM FINISHED SURFACE	6'	6'
LINEAL FEET		
Open Space		
TOTAL		
PRIVATE	LINUT A COO OF	LINUT A 057 400 (MAN)
UNIT A UNIT B	UNIT A 300 SF UNIT B 300 SF	UNIT A 257 + 100 (MAX) = 357 SF UNIT B 161 + 224 + 100 (MAX) =485
	ONIT B 300 SI	ONT B 101 + 224 + 100 (MAX) =403
Private Storage Space		
CUBIC FEET PER UNIT	CUBIC FEET PER UNIT (REQ.D)	CUBIC FEET PER UNIT (PROVID
UNIT A	UNIT A 200	UNIT A 111 CF + 171 CF= 282 C
UNIT B	UNIT B 200	UNIT B 111 CF + 124 CF= 235 C

Sheet List		
Sheet Number	Sheet Name	
A101	Title, Site, Lot Cov., Roof Plans	
A102	Site Driveway Plan	
A103	Floor Plans	
A104	Elevations	
A105	Sections	
A106	Landscape Plan	
A107.	Level 1 Floor Plan	
A108.	Level 2 Floor Plan	
A109.	Level 3 Floor Plan	
A110.	Schedules	
C101	Civil Survey	
R-01	RENDERING	

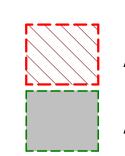

AREA INDICATED PERMEABLE SURFACES

AREA INDICATED NONE PERMEABLE SURFACES

TOTAL SITE 4,107 SF - 1,580 SF FOOTPRINT= 2,527 SF TOTAL PERMEABLE REQUIRED IS 2,527 SF X 50% (1/2 OF SITE)= 1,264 SF TOTAL PERMEABLE AREA PROVIDED IS = 1,277 SF TOTAL NONE PERMEABLE AREA PROVIDED IS = 1,250 SF

BASEMENT QUALIFICATION:

TOTAL LINEAR FOOT OF BASEMENT = 251.48 /2= 125.74 LIN FT REQUIRED TO QUALIFY

151.00 LIN FT PROVIDED 60% LINEAR FT QUALIFIED AS BASEMENT

(SEE SHEET A102)



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Project Status **Project Status** Scal As indicated

11/25/2019 12:08:38 PM

No. Description Date

Drawing Number

A101

Revision:

04 Roof 1/8" = 1'-0"

Site
1/8" = 1'-0"

10TH STREET



NECESSITY FOR SEWER BACKWATER DEVICE INSTALLATION. CONTRACTOR TO VERIFY PRIOR TO CONSTRUCTION 30' - 4" —LINE OF LEVEL 1 BELOW (NW) 93.7 PC --(NE) 96.8 PC PROPERTY LINE 38.00' CONC. PATIO WALK ELEV= 99.25 NEW CONCRETE STEPS ON— GRADE _3' - 10" MIN. SETBACK landscape plan ENTRY 3' - 10" SETBACK Guest /Parking —BASEMENT LINE 2% SLOPE **→**2% SLOPE 2% SLOPE 3' - 10" SETBACK 128.43' ENTRY FS 101.35' 30' - 4" PROPERTY LINE 38.00' —(SE) 99.6 PC (E) CONC. WALK SLOPE 15.3% (SW) 93.8 PC/ New driveway approach per city standards (SEE C-SHEET) Parking 12' - 0" APPROACH 10TH STREET Site Driveway Plan
1/8" = 1'-0"

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NOTE: PROPERTY LINE SHOWN ON PLANS ARE SQUARED FOR CLARITY, CONTRACTOR SHALL REFER TO CIVIL SURVEY PLAN FOR EXACT PROPERTY LINE BOUNDARIES. NOTIFY ARCHITECT FOR ANY DISCREPANCIES. CONTRACTOR SHALL MEET ALL MINIMUM SETBACKS INDICATED PER PLAN

PROVIDE ELECTRICAL CONDUITS FOR FUTURE SOLAR INSTALLATION PER 15.32.140

1. ALL UTILITIES SHALL BE UNDERGROND, CONTACT

WAY VIA NON-EROSIVE DEVISE, PER HBMC. DRAINAGE FIXTURE LOCATED BELOW THE NEXT UPSTREAM MANHOLE OR BELOW THE MAIN SEWER LEVEL REQUIRES INVESTIGATION TO ASCERTAIN THE

SOUTHERN CALIFORNIA EDISON FOR THEIR REVIEW 2. ALL SITE DRAINAGE SHALL BE TERMINATED AT PUBLIC

THIS PROJECT SHALL MEET STC 52 MIN.

note: "automatic and moisture sensor sprinkler" will be provided on the

BASEMENT QUALIFICATION:

SITE NOTES:

TOTAL LINEAR FOOT OF BASEMENT = 251.48 /2= 125.74 LIN FT REQUIRED TO QUALIFY

151.00 LIN FT PROVIDED 60% LINEAR FT QUALIFIED AS BASEMENT

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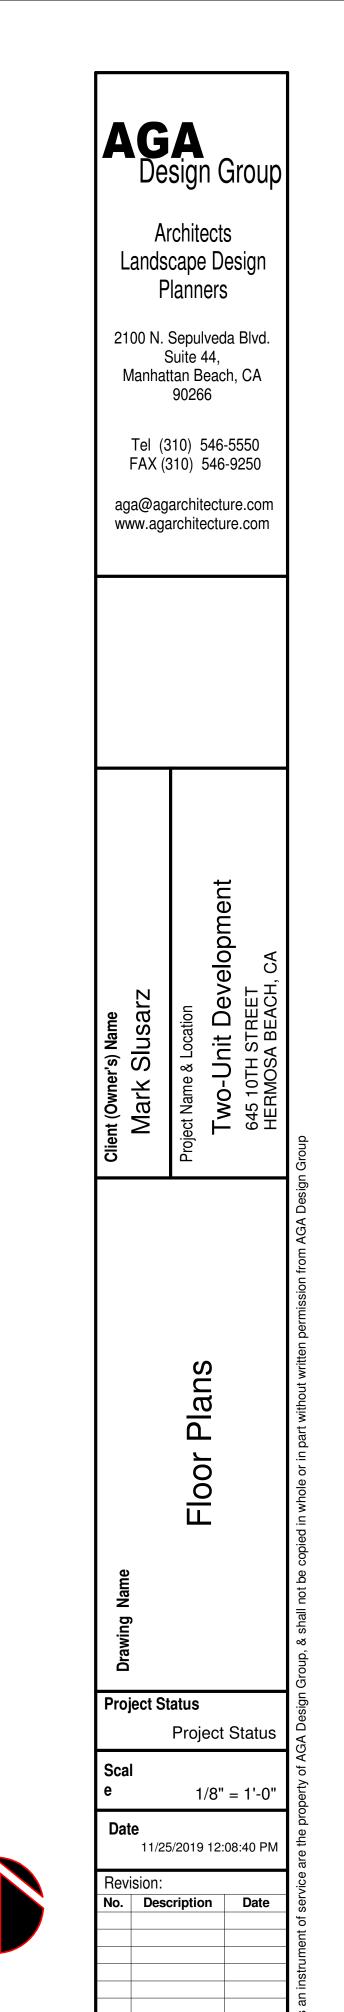
Project Status 1/8" = 1'-0'

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Revision: No. Description Date

A102


Drawing Number





1/8" = 1'-0"

1/8" = 1'-0"

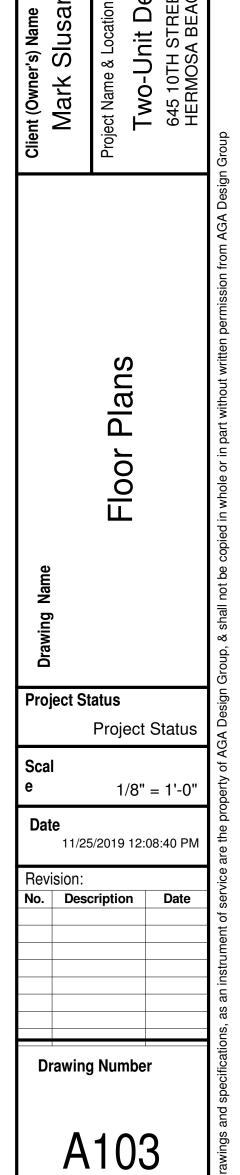

1/8" = 1'-0"




Sectional roll-up stained metal and frosted garage door.
Horizontal wood siding. Minimum class B fire rated shake panels over #15 felt. Color to be dark


4. +42" high modern style aluminum guardrail and rail per detail, natural brushed metal finish.
5. Brushed aluminum box awning over doors & windows per elevation.
6. Seamless anodized aluminum roof facia eave.

 Exposed stained wood siding under cantilevers and roof eave overhangs.
 Solid +42" stucco guardrail.
 Aluminum panels over framing. Natural brushed metal color. 10. Brick veneer over wood framing

CHECK HEIGHT OF CHIMNEY PER MANUFACTURER

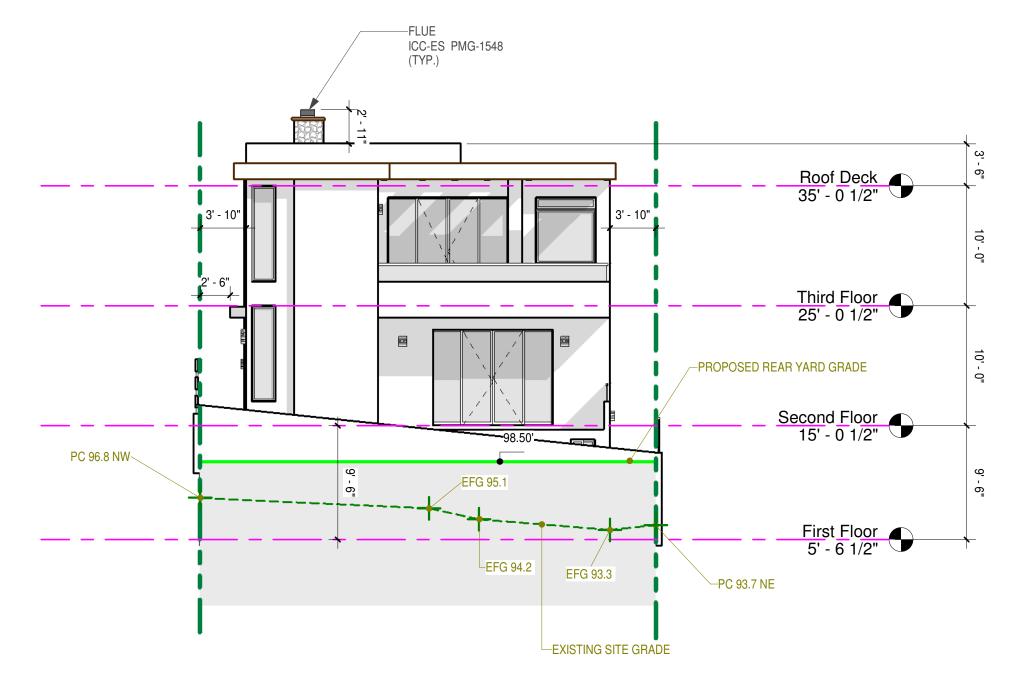

North UNIT-B 1/8" = 1'-0"

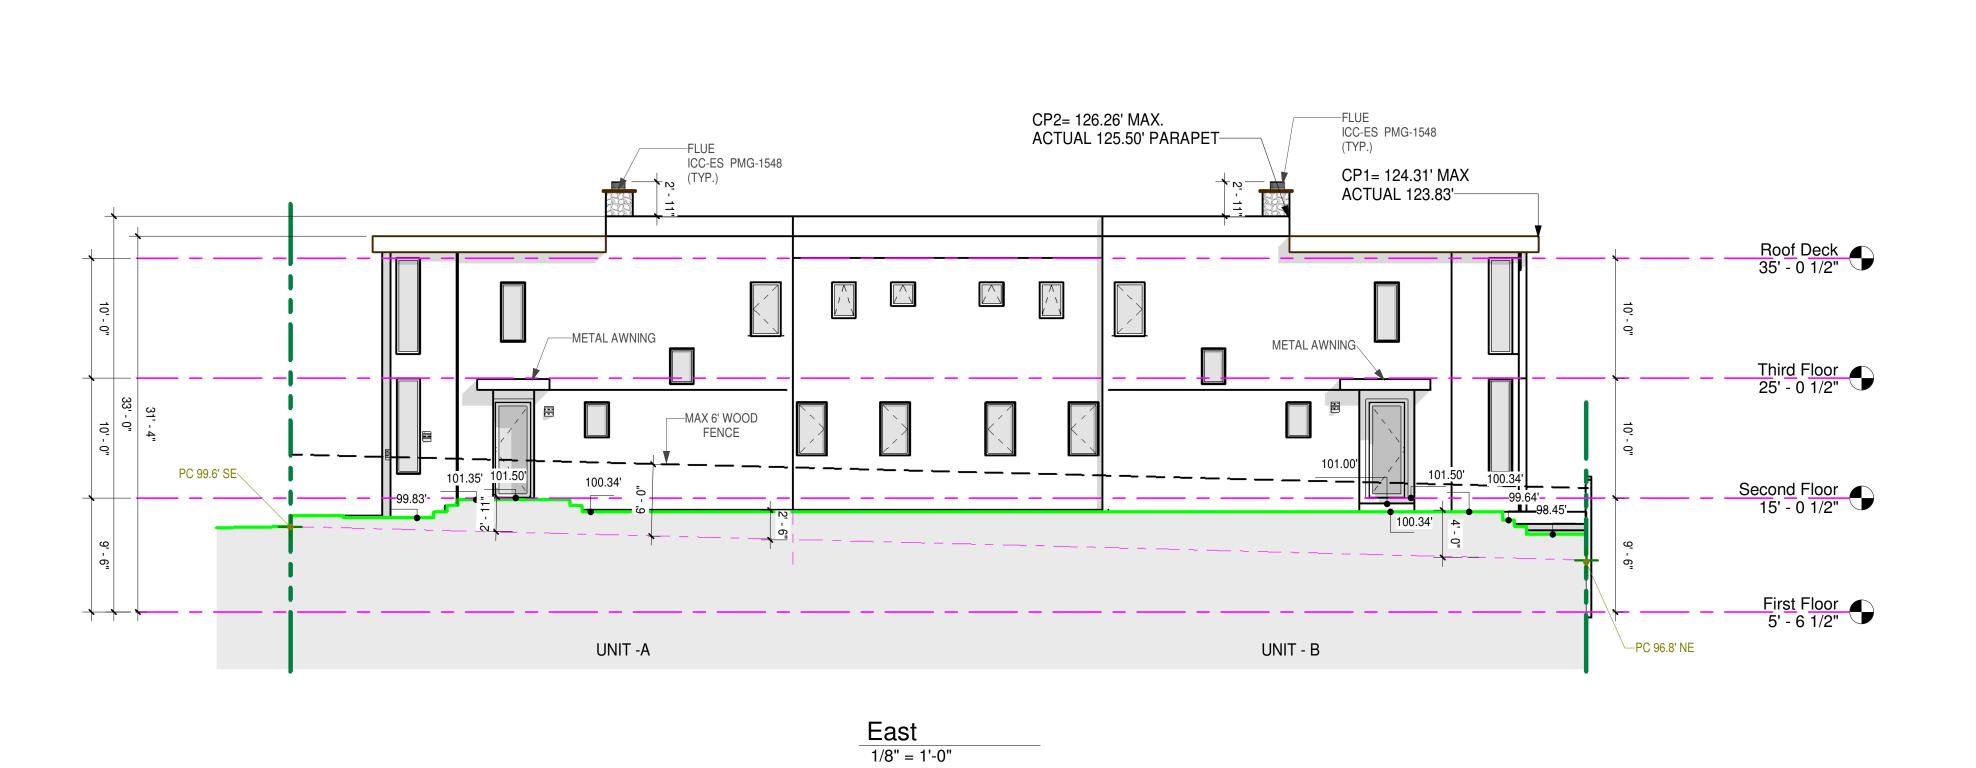

FLUE ICC-ES PMG-1548

UNIT -B

---ELECT METERS

EFS 93.03'

West

--FLUE ICC-ES PMG-1548 (TYP.)

-NEW DWY.

GRADE BRK.

93.83' MIN

ф°

—GAS METERS

UNIT -A


Roof Deck 35' - 0 1/2"

Third Floor 25' - 0 1/2"

-PLANTER WALL

Second Floor 98.00 15' - 0 1/2"

First Floor 5' - 6 1/2"

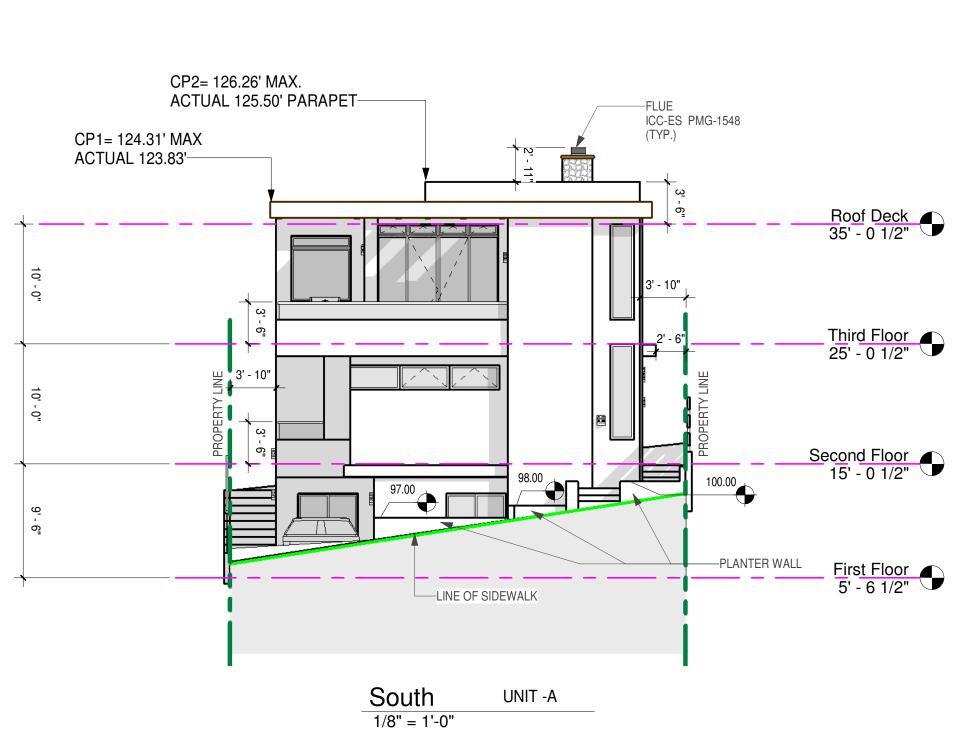



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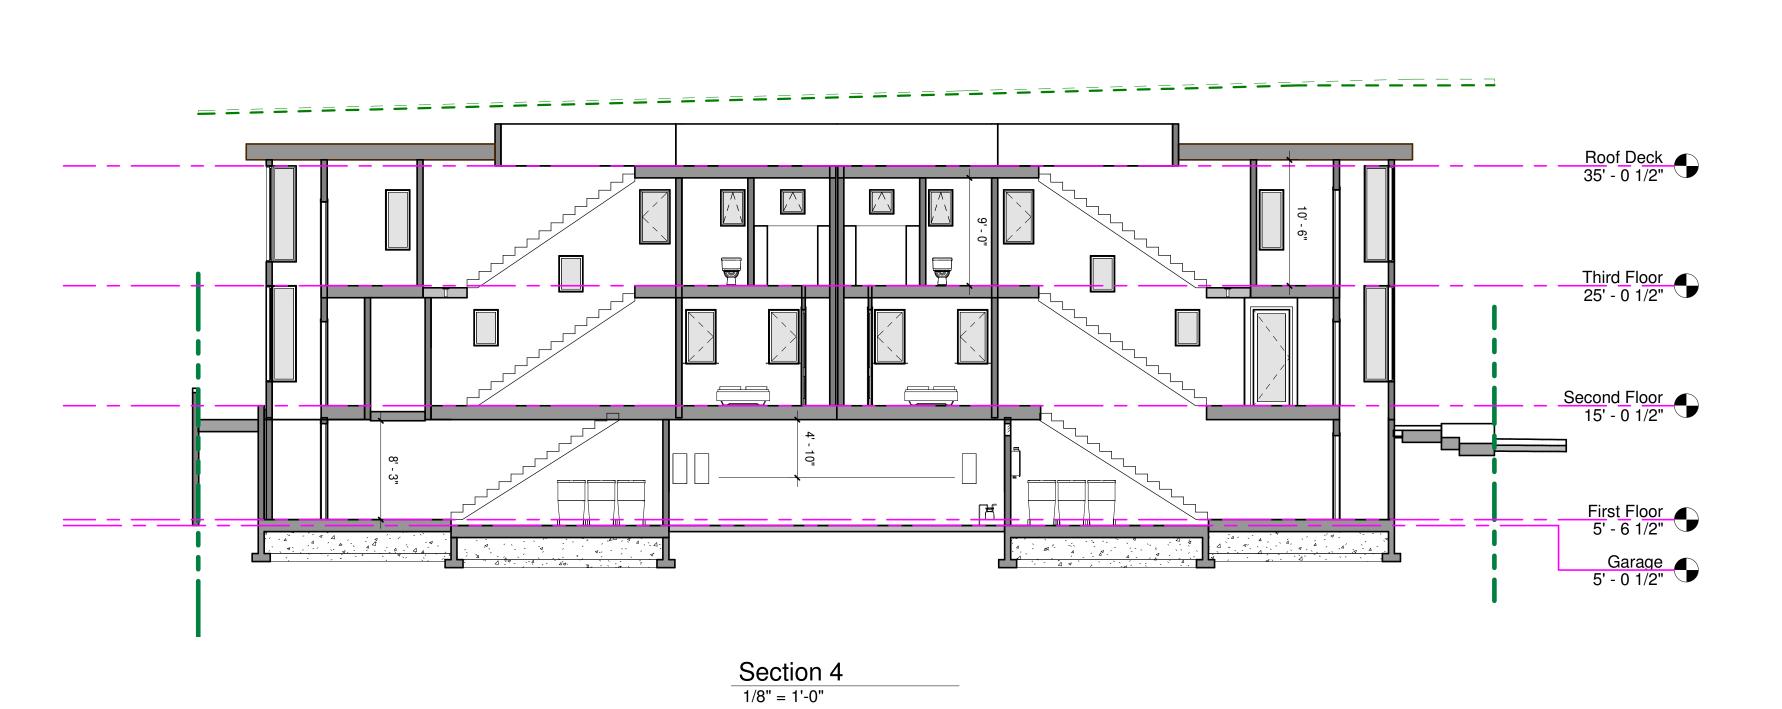
Elevations Project Status Project Status As indicated 11/25/2019 12:08:43 PM Revision: No. Description Date **Drawing Number** A104

PC 93.7 NW____

ON GRADE



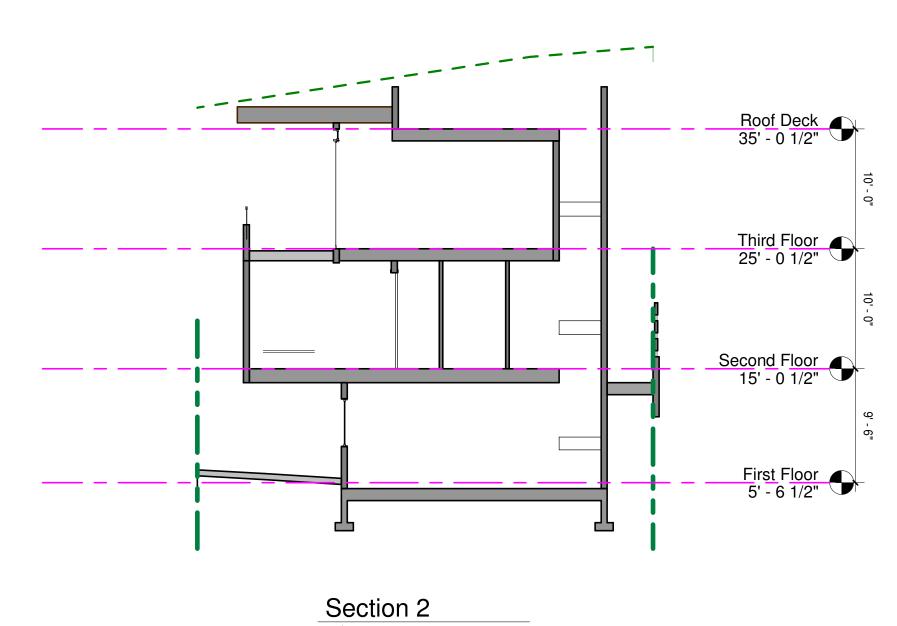

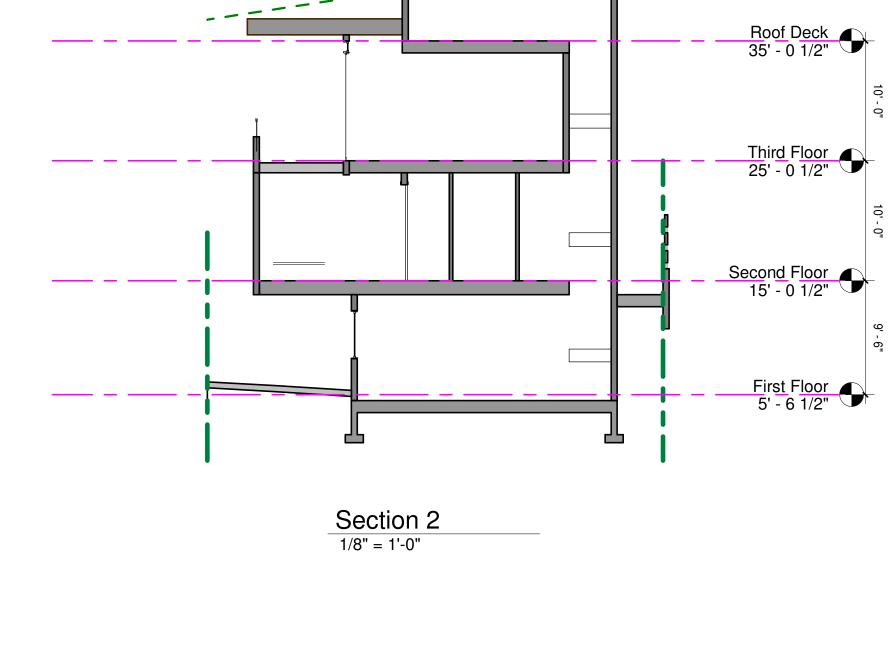

Section 3

1/8" = 1'-0"

MAX. HEIGHT LIMIT


Roof Deck 35' - 0 1/2"

Third Floor 25' - 0 1/2"

Second Floor 15' - 0 1/2"

First Floor 5' - 6 1/2"

Garage 5' - 0 1/2"

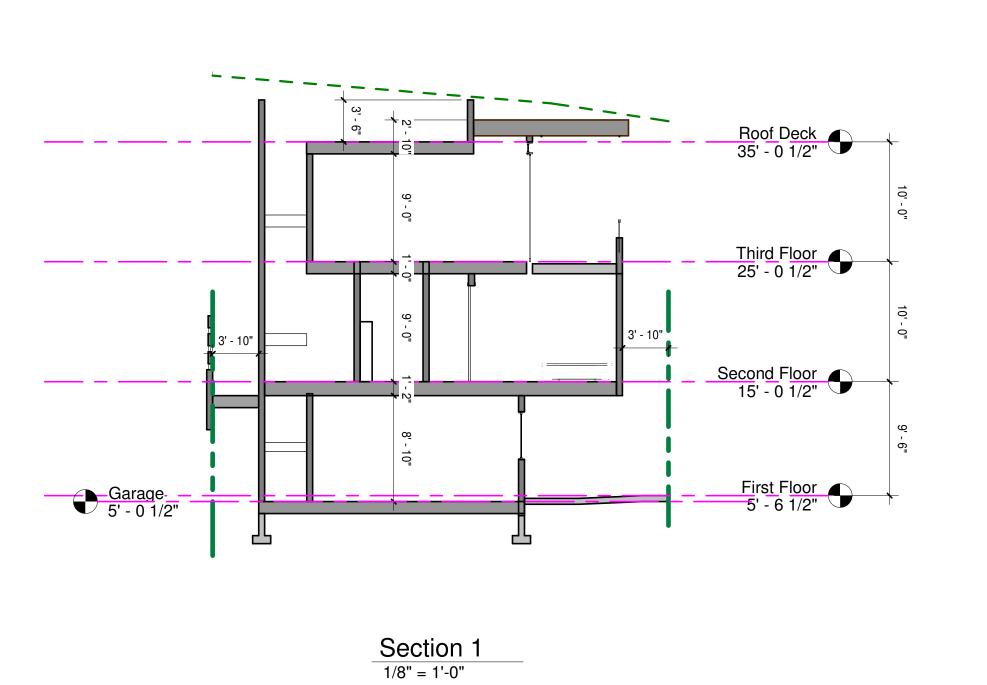

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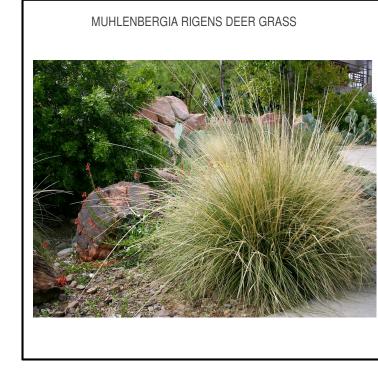







FESTUCA GLAUCA ELIJAH BLUE FESCUE







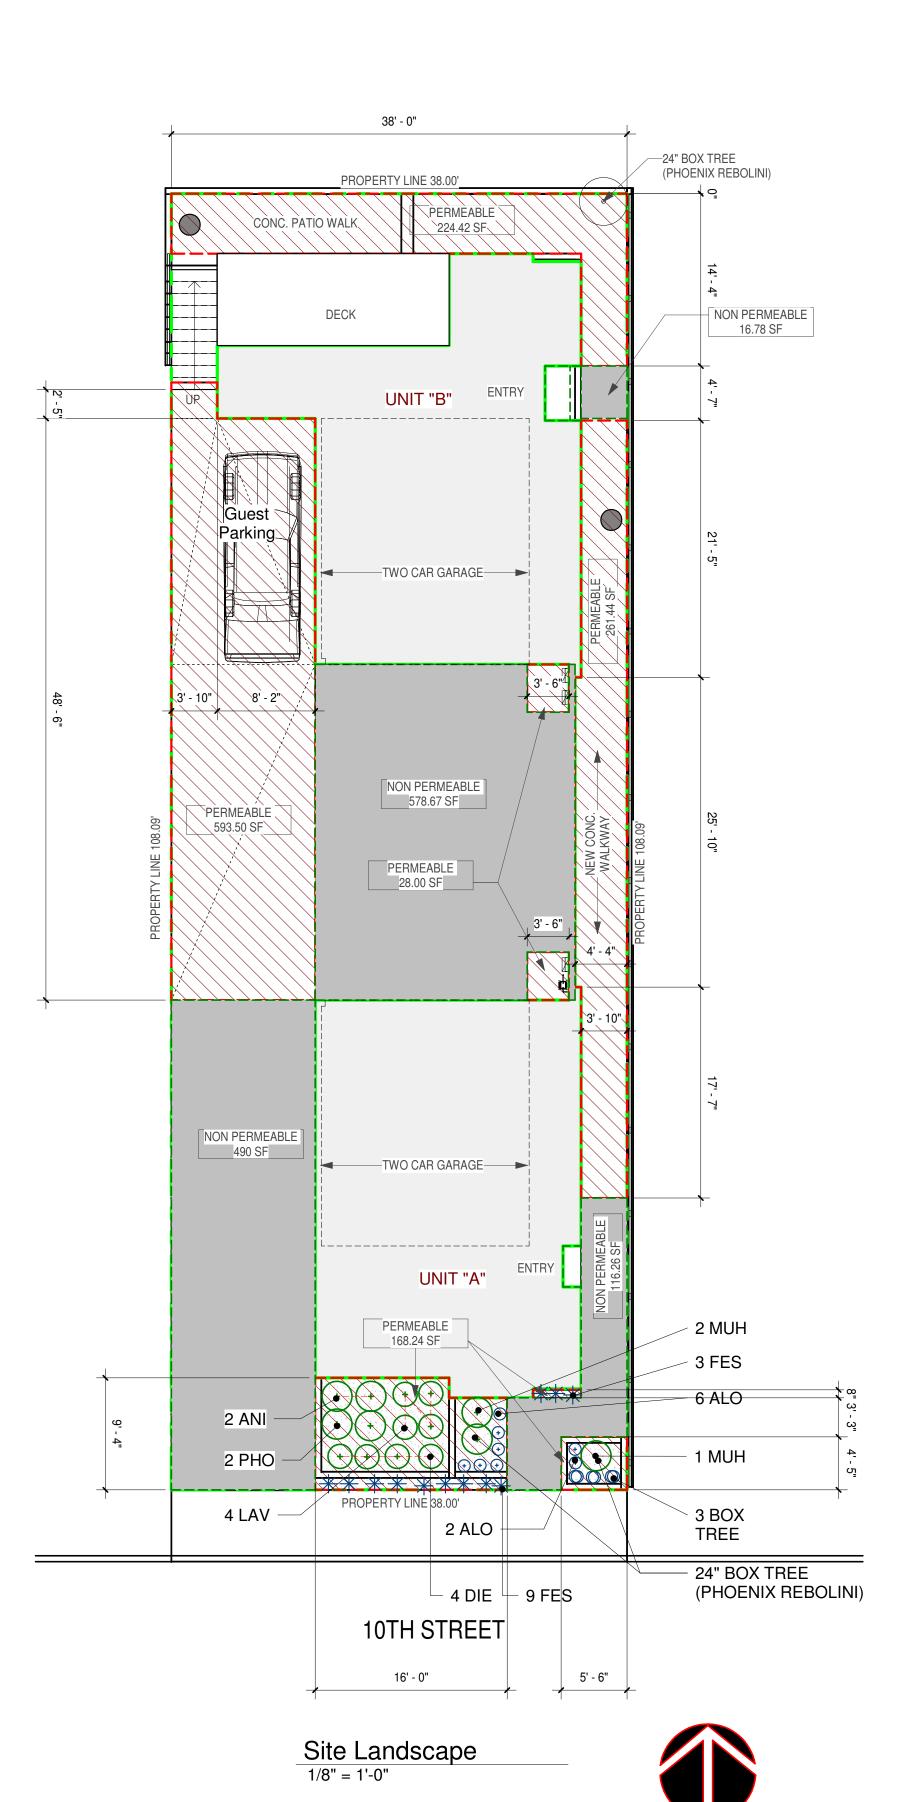

PLANT LEGEND Symbol Botanical Name HEIGHT / WIDTH at MATURITY Common Name

PYGMY DATE PALM PHEONIX ROABELWNII ALOE NOBILIS **GOLD TOOTH ALOE** LOW LOW 1-2 feet / 1-2 feet RED CROSS KANGAROO PAWS 5 GAL PERENNIAL ANIGOZANTHOS 'RED CROSS' 4-6 feet / 2-3 feet FES FESTUCA GLAUCA ELIJAH BLUE FESCUE PERENNIAL <1 foot / 1-2 feet LAVANDULA INTERMEDIA 'GROSSO' 2-3 feet / 4-6 feet PHORMIUM TENAX 'JACK SPRATT' 5 GAL NEW ZEALAND FLAX 18 inches/ 18 inches 5 GAL SHRUB 5 GAL PERENNIAL 2' feet / 2' feet wide 4-5 feet / 4-6 feet DIETIES BICOLOR **BUTTERFLY IRIS** DEER GRASS MUHLENBERGIA RIGENS

BEFORE ANY PLANTS ARE LOCATED, ALL PLANTED AREAS ARE TO BE GRADED IN AN ACCEPTABLE MANNER TO ASSURE POSITIVE DRAINAGE.

WHERE CIRCUMSTANCES PERMIT, DO NOT PLANT TREES CLOSER THAN 5' (FIVE FEET) TO AN EDGE OF PAVING, HEADERBOARD OR ROOF LINE.

WHERE CIRCUMSTANCES PERMIT, DO NOT PLANT SHRUBS CLOSER THAN 3' (THREE FEET) TO AN EDGE OF PAVING OR HEADERBOARD. ANY TREE PLANTED WITHIN 5' OF HARDSCAPE SURFACE (EDGE OF SIDEWALK, WALLS, CURBS, AND BUILDING MUST HAVE ROOT GUARD INSTALLED AT TIME OF

PLANTING PER MANUFACTURERS SPECIFICATIONS. INSTALL PER DETAIL.

LANDSCAPE PLANS ARE DIAGRAMMATIC FOR CLARITY OF READING. PLANTING MAY BE ADJUSTED IN FIELD.

MOUNDING AND ROUGH GRADE TO 1/10 FT. TO BE PROVIDED BY OTHERS. FINISH GRADE TO BE PROVIDED BY LANDSCAPE CONTRACTOR. IF APPLICABLE WHERE MOUNDING OCCURS ADJACENT TO STREET OR WALKS, SWALES SHALL BE FORMED ALONG THE STREET OR WALK TO CONTROL IRRIGATION RUN OFF.

PLANT QUANTITY LIST IS PROVIDED FOR THE CONVENIENCE OF THE CONTRACTOR AND IS NOT INTENDED FOR ACCURATE BIDDING PURPOSES. 10. IF REQUIRED, THE OWNER OR OWNER'S REPRESENTATIVE SHALL SUBMIT PLANS TO THE APPROPRIATE PLANNING AND AGRICULTURE DEPARTMENTS PRIOR TO

SUBMITTAL FOR BUILDING PERMITS.

AREA INDICATED PERMEABLE SURFACES

AREA INDICATED NONE PERMEABLE SURFACES

2,527 SF TOTAL SITE 4,107 SF - 1,580 SF FOOTPRINT= TOTAL PERMEABLE REQUIRED IS 2,527 SF X 50% (1/2 OF SITE)= 1,264 SF TOTAL PERMEABLE AREA PROVIDED IS = 1,275.60 SF TOTAL NON PERMEABLE AREA PROVIDED IS = 1,201.71SF

SPECIFICATION

1. ALL LANDSCAPE AREA TO BE ON AUTOMATIC IRRIGATION SYSTEM . EACH PRIVATE OPEN SPACE SHALL BE ON A PRIVATE DOMESTIC WATER.

CONTROLLER SHALL BE IN A SEPARATE SYSTEM.

2' ALL IRRIGATION VALVES, CONTROLLER HEADS TO BE BY RAINBIRD OR EQUALLY . 3. ALL PIPES TO BE TO SCHEDULE 200 AND MAIN LINE TO BE IN SCHEDULE. 40

PLANTS SHALL NOT EXCEED MORE THAN 20% HIGH WATER USE

AUTOMATIC AND MOISTURE SENSOR SPRINKLER" WILL BE PROVIDED

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11/25/2019 12:08:45 PM No. Description Date

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A106

Floor Plan Legend

New 2X Studs Wall or In-Fill @ 16" OC, UNO

- (E) Existing to Remain
 (N) New
 (R) Replaced
 (D) Demolish
 (F) Future Not This Permit
- 3040, Window or door size, top example indicates 3'-0" width X 4'-0" height, bottom example indicates 2'-6" X 6'-8" height.

Hard wire smoke alarms with battery back up in sleeping rooms and centrally located in corridors. CDD Carbon monoxide detector shall be interconnected hard-wired with battery backup.

Combination fluorescent light/Exhaust Fan, 50 CF/Min.

Exhaust fan, 50 CFM, Kitchen airflow rate shall be minium 100 CFM.

Floor Plan Key Notes

Front entrance / exit door minimum 32 inches clear opening width 1-3/4 inches minimum thick.
 Vent through wall and or door at laundry room for combustion air, minimum 100 square inch.

Provide mechanical ventilation capable of providing 5 air changers per hour.
 Net area of shower receptor shall be not less than 1,024 square inch of floor area, and encompass 30 inch diameter

5. Lighting 12 inch minimum away from shelves and provide cover for protection of combustible materials.
6. Forced-Air-Unit (FAU), See energy calculations. Set unit on minimum 18" high wood framed platform or per plan.

7. Granite slab and counter +36 inches high top (owner to select). 8. Exit doors shall be operable from the inside without use of key or any special knowledge or effort. 9. Tankless hot water heater shall be gas or electric, continuous burning gas pilot light are prohibited, see energy calculations.

10. Provide shelf and pole assembly at all closets and walk in closets. 11. Water closets shall be located in a 30" wide space and have a clear space in front of toilet shall be minimum of 24 inch in front of the water closet.

12. Drain inlets (two-3" diameter) 1 drain to be 2 inches above low point for overflow, and the main drain to connect to down spouts or internal drain.

13. Dryer vent to outside air maximum 14' total length with maximum (2) 90 deg. Bends. 14. Fireplace Hearth shall be +12" raised non combustible surround.

20. Hard wire smoke alarms with battery back up. See Specific Notes on Sheet A004

15. Provide one-hour resistive construction at walls and ceiling on the enclosed side of stairs as required per code.
16. Showers and tub-shower shall have either a pressure balance or a thermostat mixing valve. 17. Guardrail shall be at least 42 inches high. Baluster shall not be permit 4.375 inch diameter to pass through any opening.

18. Handrail shall be 34" to 38" above tread nosing, with openings less than 4 inch diameter clear. 19. Emergency escape and rescue from sleeping rooms. See Specific Notes on Sheet A004

21. Exterior waterproofing surface, slope 2% min. to drain (Crossfield Products, Dex-o-tex Weather Ware, ES Report ESR# 22. Landing areas adjacent to doors shall have a measured length in the direction of travel no less than 36 inches. 23. Mechanical ventilation in laundry, bathrooms, and toilet rooms shall be 50 cubic feet per minute. Vent to outside


24. Stair risers shall be 4" minimum and 7.75" maximum; treads shall be 11" minimum; headroom 6'-8" minimum; width 36" minimum. Stair landings shall be minimum 7'. 25. Shower with tempered glass enclosure door.

26. Required parking area shall be per code, provide 5/8" Type-X drywall at walls and ceiling to achieve an 1-hour rating. Automatic garage door opener equipment and the garage door entrance to be minimum 7'-4" high clear. Provide louvered vents - 14" x 6", 6" above garage floor, verify w/ adjacent grade, adjust as required per code, slope floor 0.5% minimum, 2% maximum. Note, the garage floor shall slope to facilitate the movement of liquids to a drain or toward the main vehicle entry door per CRC section R309.1 or CBC section 406.3.3
27. Laundry room shall have waterproof the floor area, and install a floor drain. Provide a trap primer; include washing-

machine drip pans and electronic shutoff valves that automatically stop the flow of water when they sense a leak.

28. Fire rated, (20 Minute), self closing, tight fitting door shall be equipped with weather strip and threshold. 29. Kitchen exhaust fan for local ventilation per code, min. airflow rate shall be 100 CFM.

30. Combustion air ventilation required when FAU and Water Heaters located in garage area.

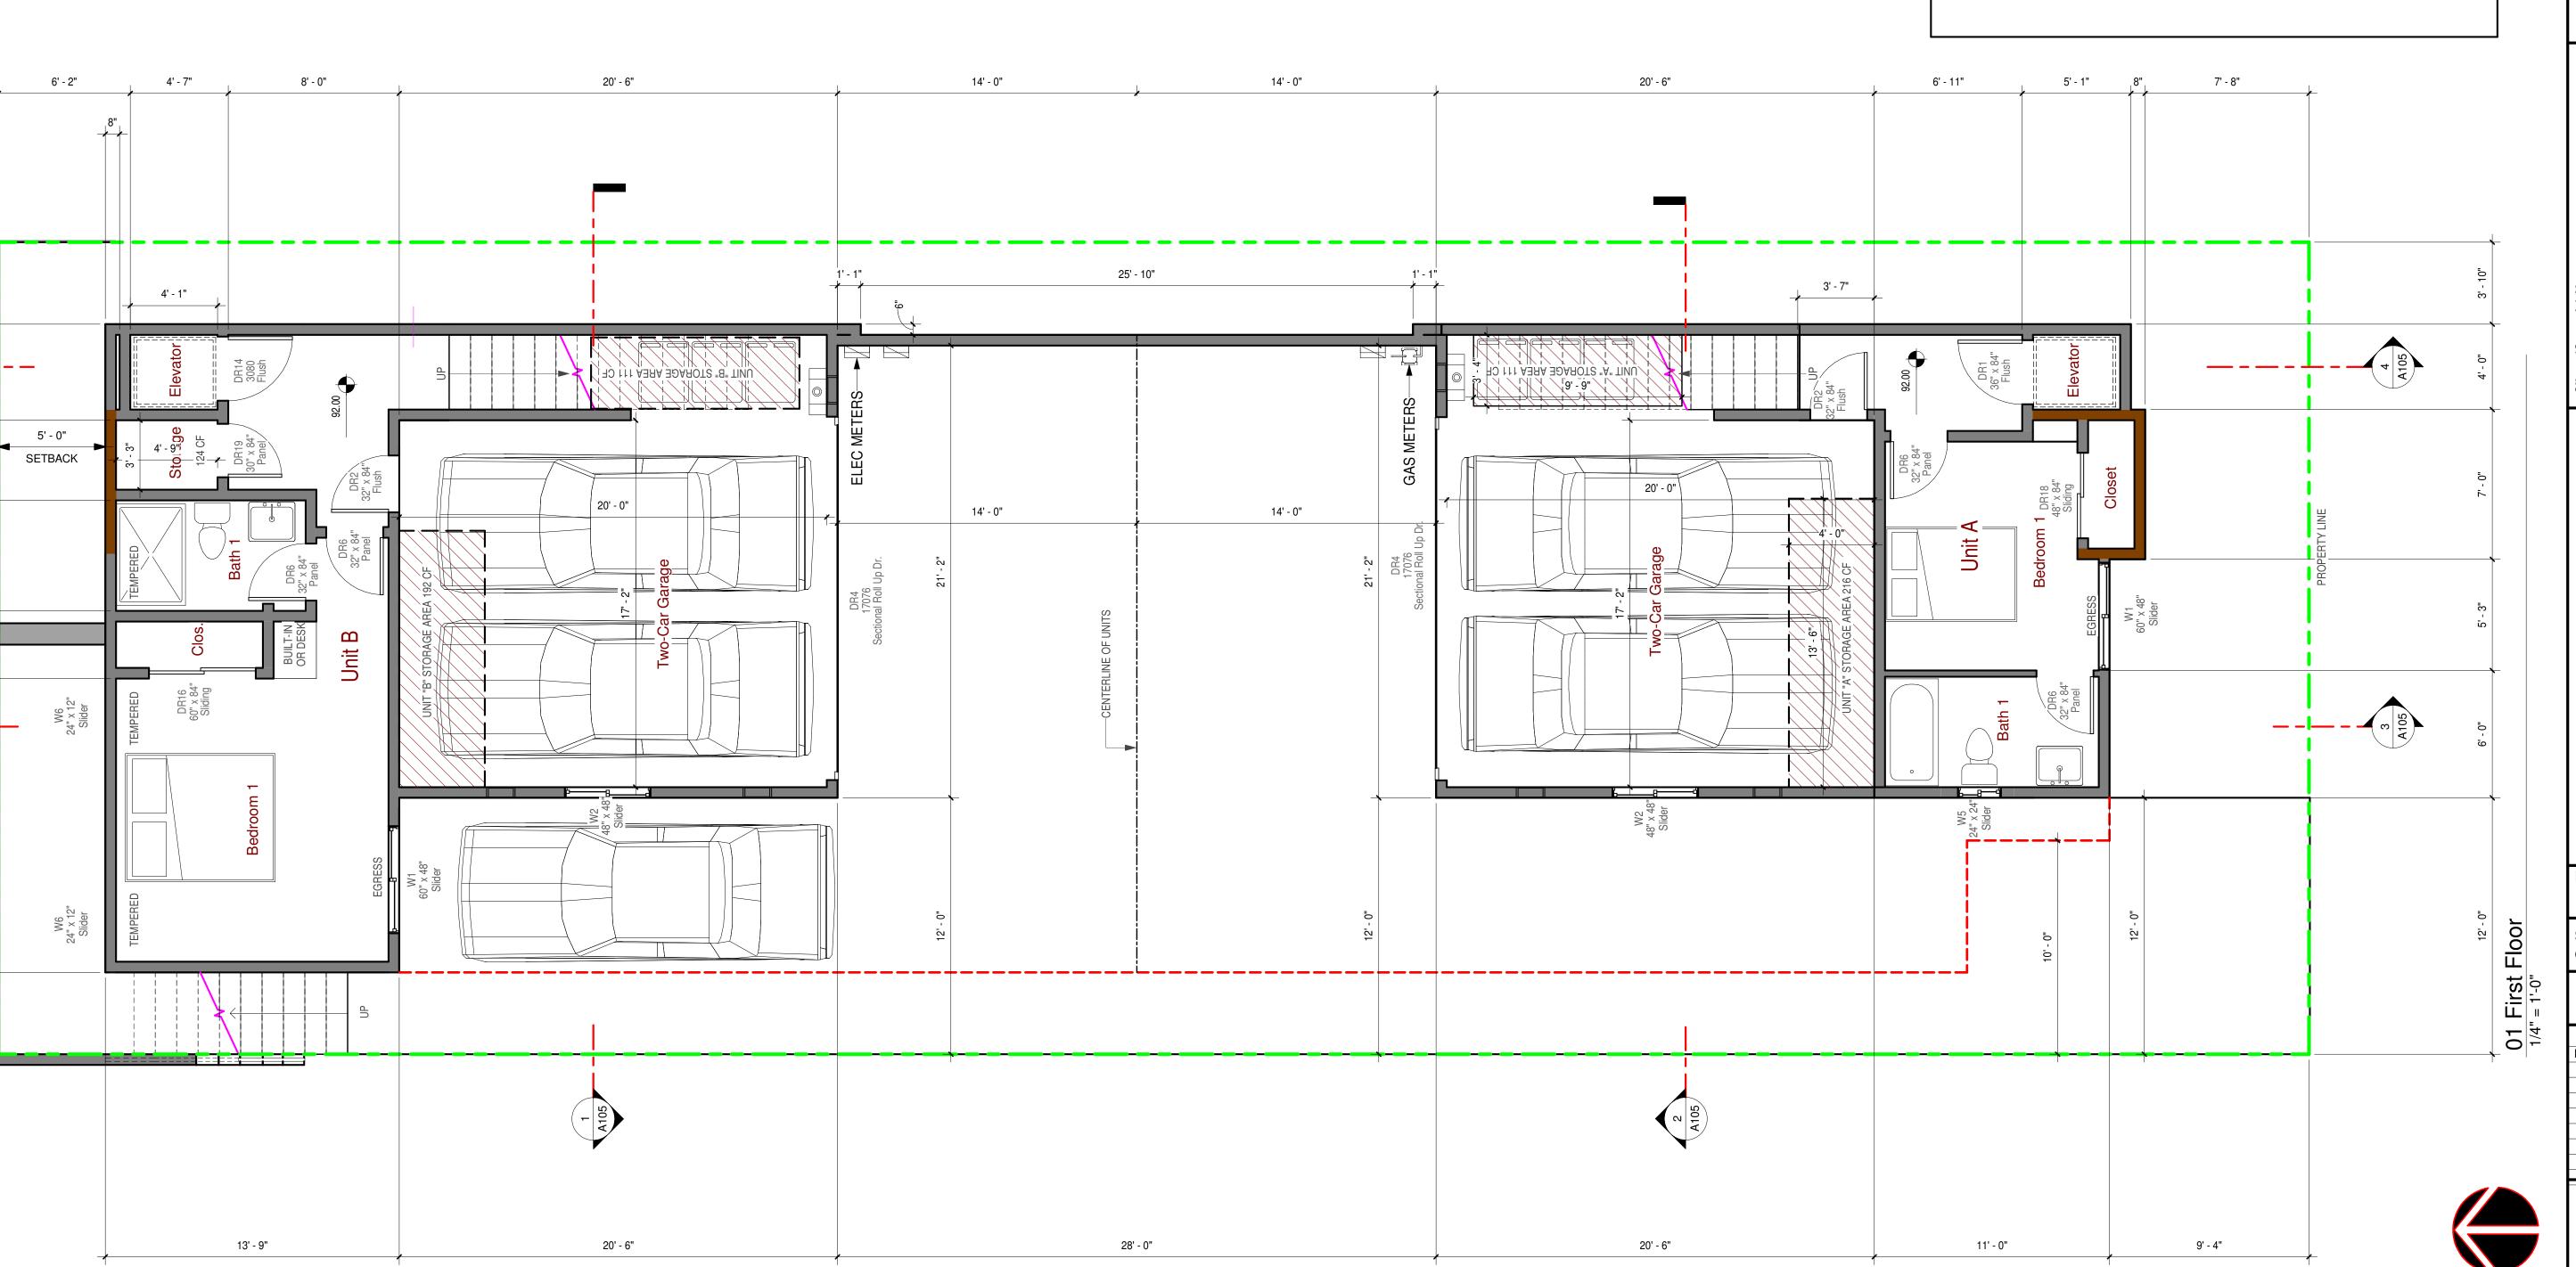

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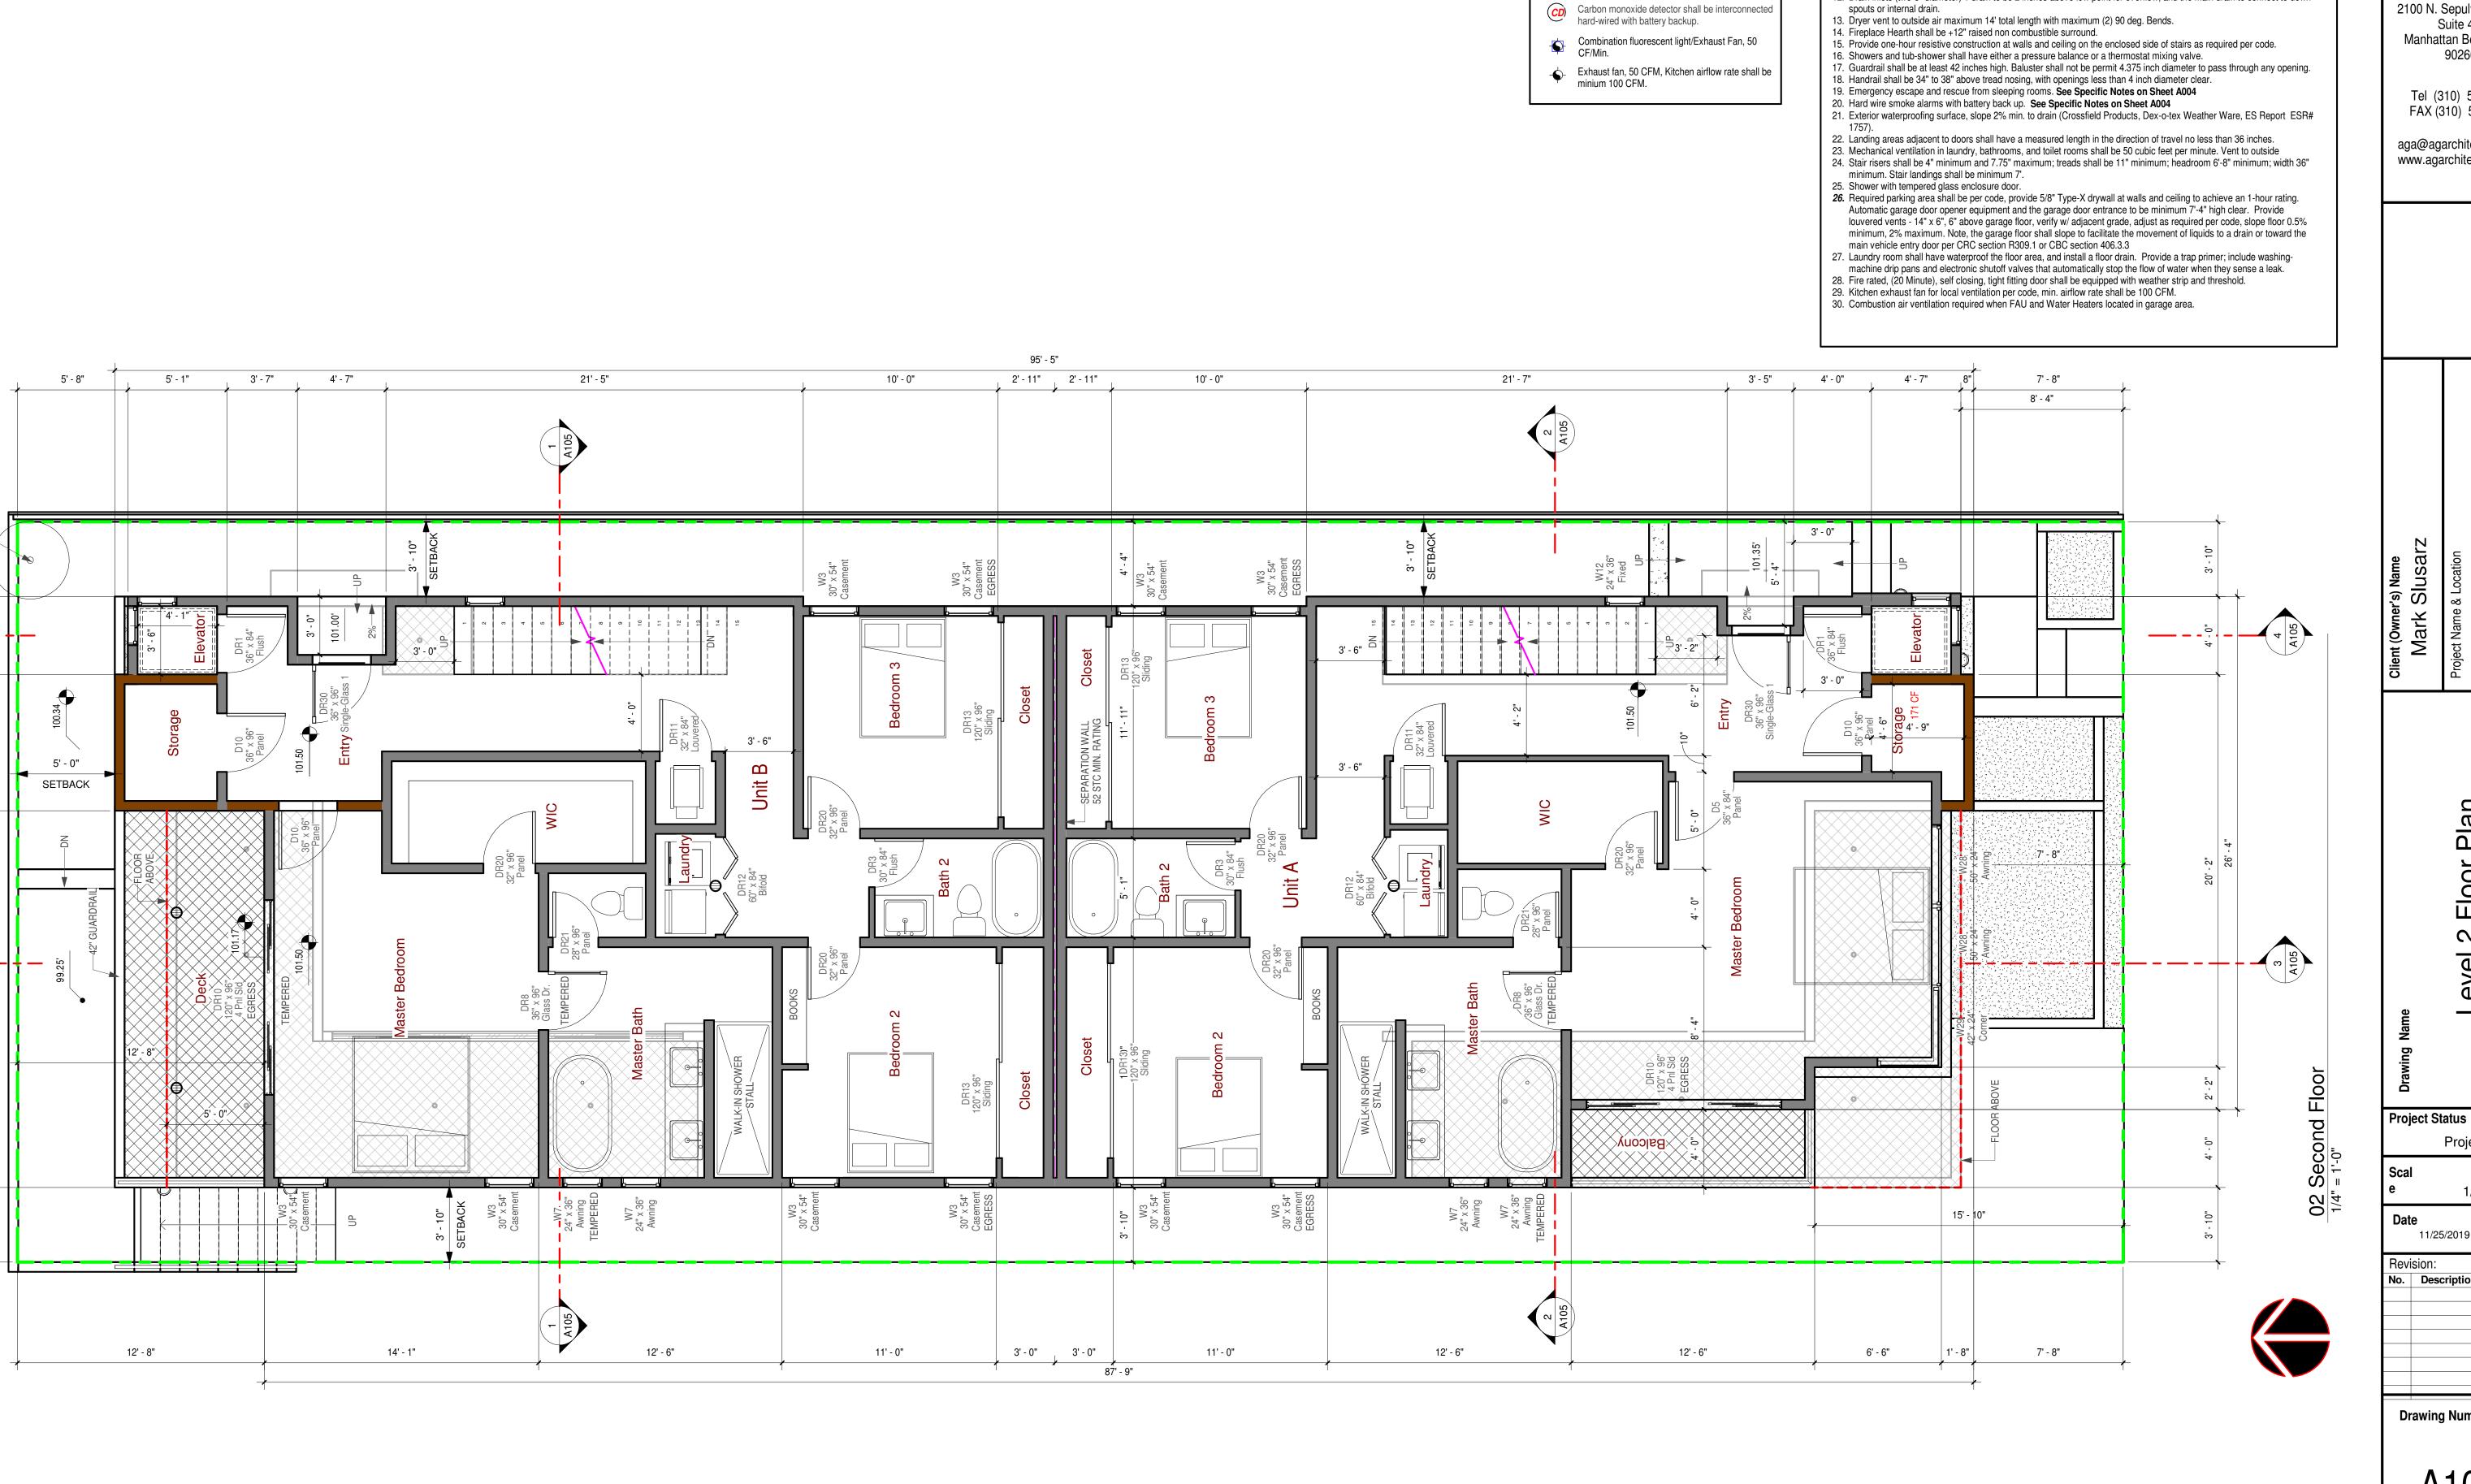
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Project Status **Project Status** 1/4" = 1'-0' 11/25/2019 12:08:45 PM **Drawing Number**



Floor Plan Key Notes

4. Net area of shower receptor shall be not less than 1,024 square inch of floor area, and encompass 30 inch diameter

5. Lighting 12 inch minimum away from shelves and provide cover for protection of combustible materials.
5. Forced-Air-Unit (FAU), See energy calculations. Set unit on minimum 18" high wood framed platform or per plan.

11. Water closets shall be located in a 30" wide space and have a clear space in front of toilet shall be minimum of 24 inch in

12. Drain inlets (two-3" diameter) 1 drain to be 2 inches above low point for overflow, and the main drain to connect to down

9. Tankless hot water heater shall be gas or electric, continuous burning gas pilot light are prohibited, see energy

Front entrance / exit door minimum 32 inches clear opening width 1-3/4 inches minimum thick.
 Vent through wall and or door at laundry room for combustion air, minimum 100 square inch.

8. Exit doors shall be operable from the inside without use of key or any special knowledge or effort.

3. Provide mechanical ventilation capable of providing 5 air changers per hour.

7. Granite slab and counter +36 inches high top (owner to select).

10. Provide shelf and pole assembly at all closets and walk in closets.

calculations.

front of the water closet.

Floor Plan Legend

New 2X Studs Wall or In-Fill @ 16" OC, UNO

3040, Window or door size, top example indicates 3'-0" width X 4'-0" height, bottom example indicates 2'-6" X 6'-8" height.

Hard wire smoke alarms with battery back up in sleeping rooms and centrally located in corridors.

(E) Existing to Remain
(N) New
(R) Replaced

(F) Future Not This Permit

(D) Demolish

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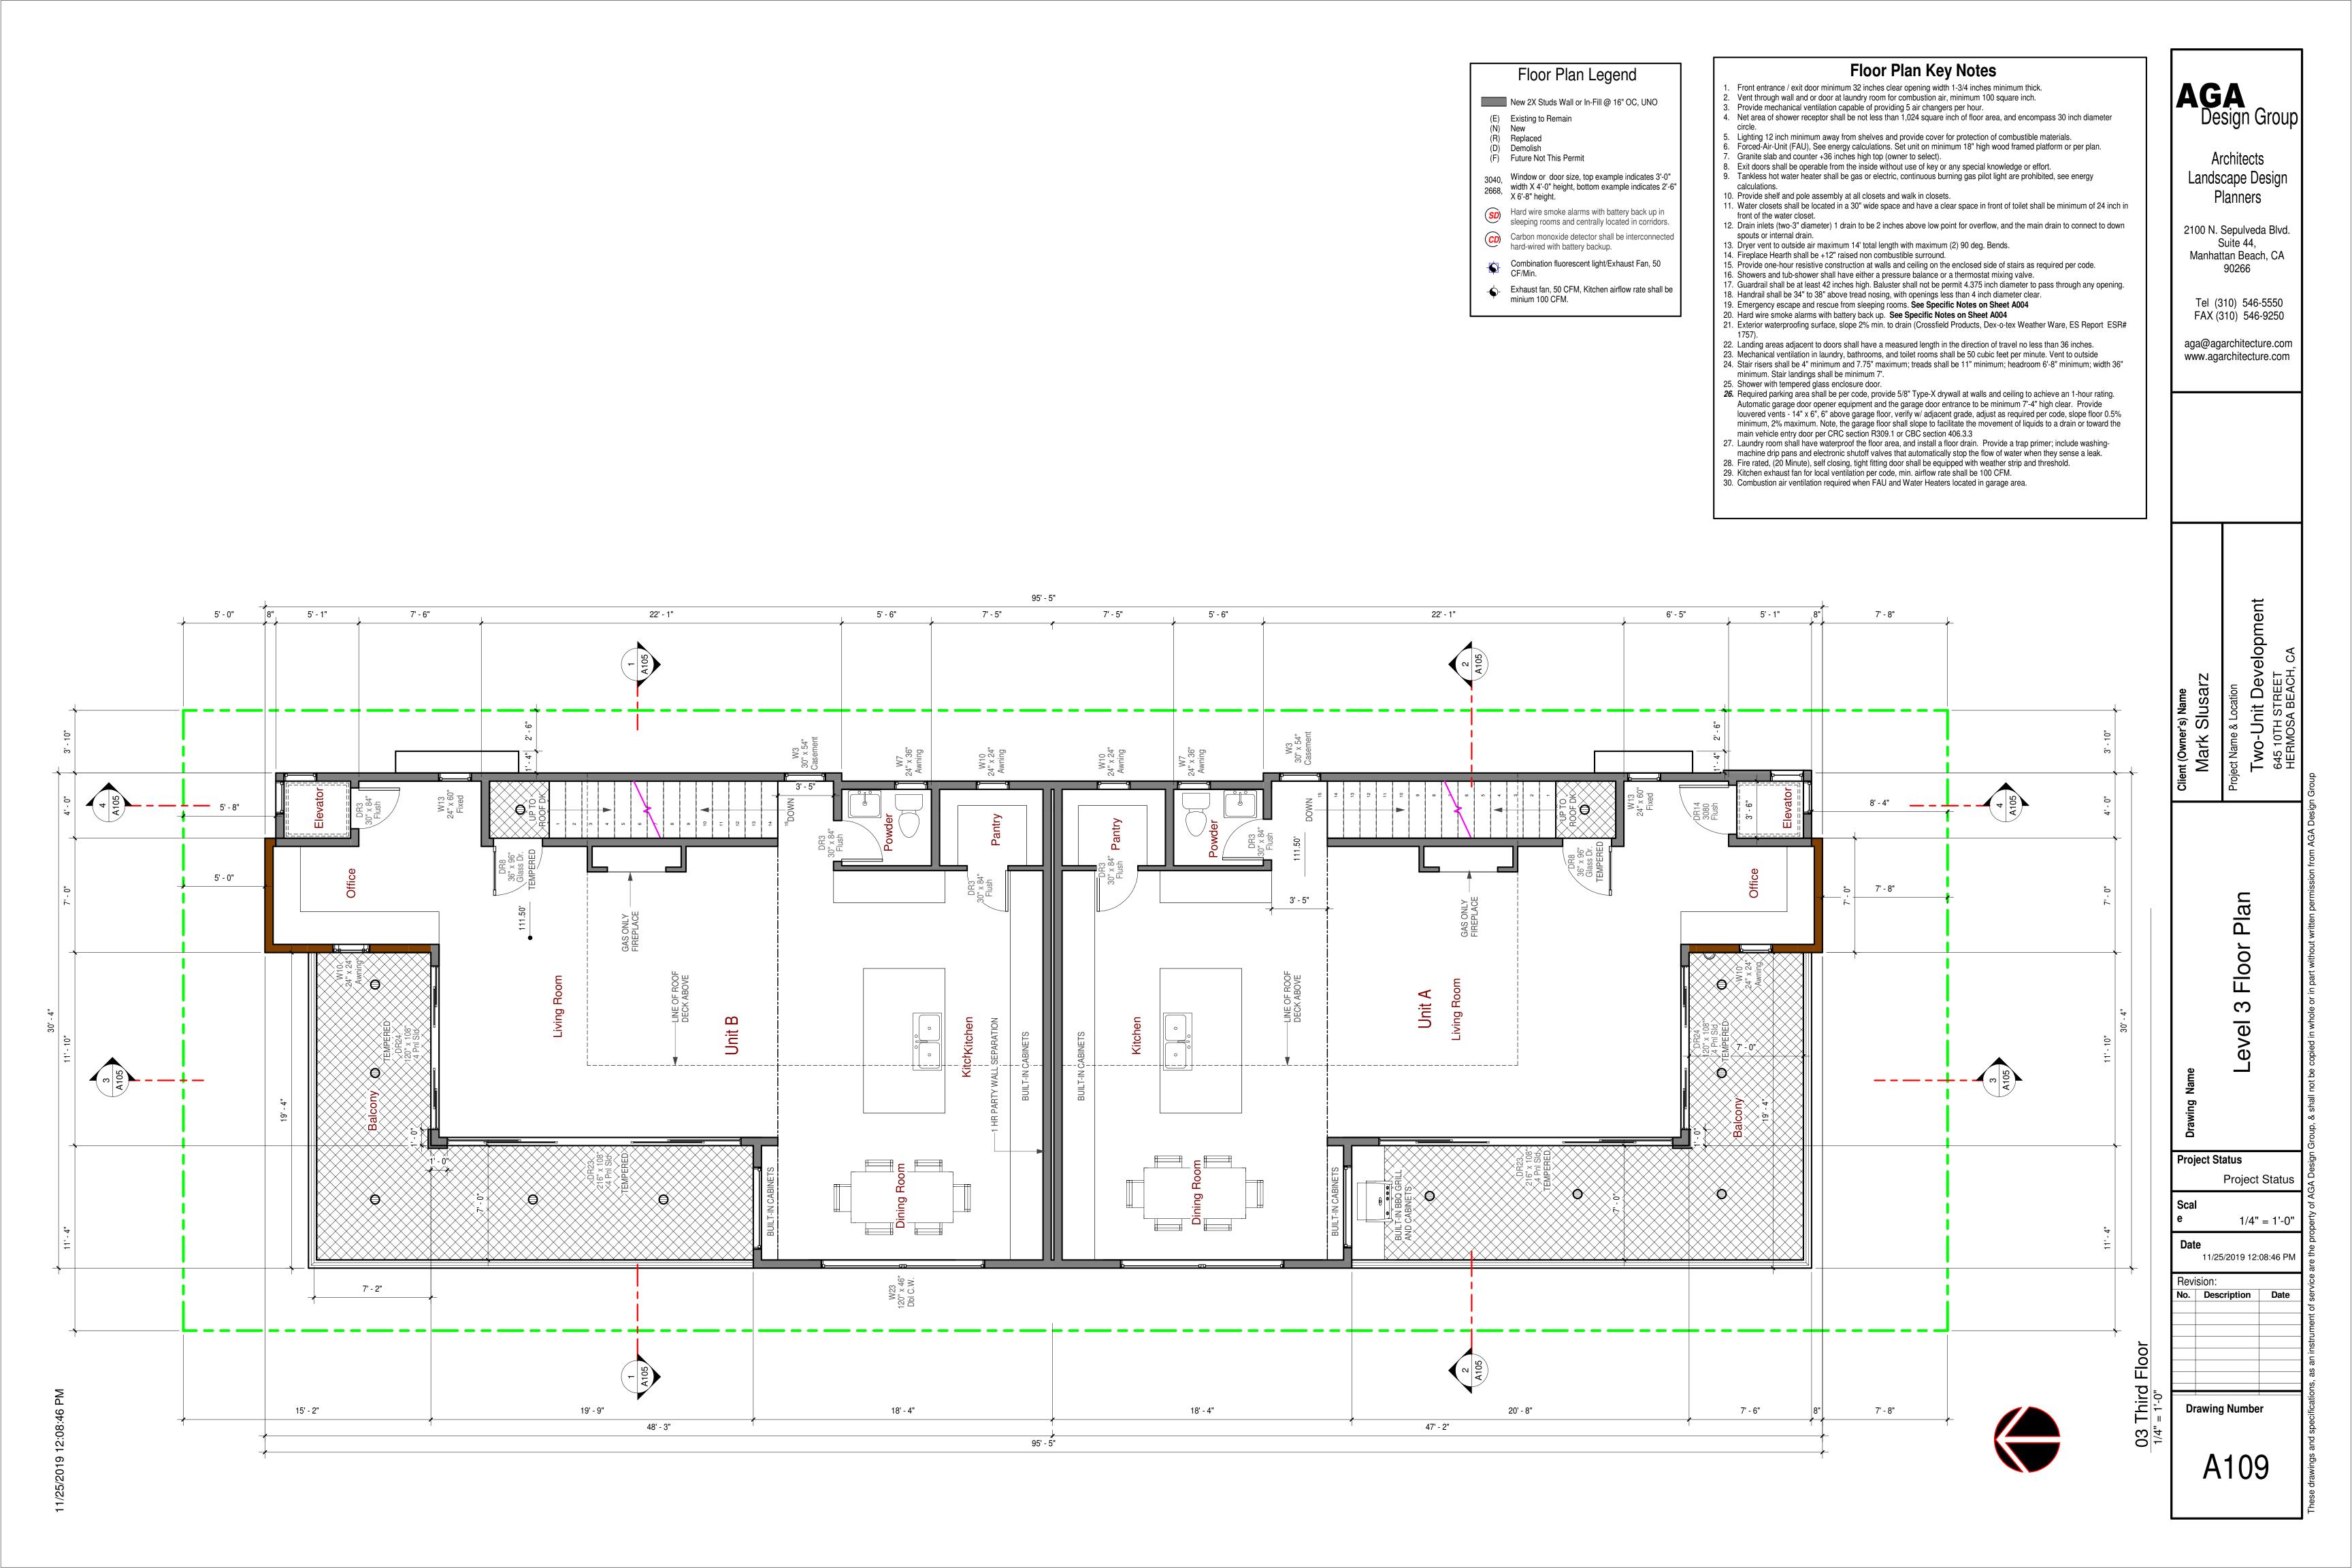
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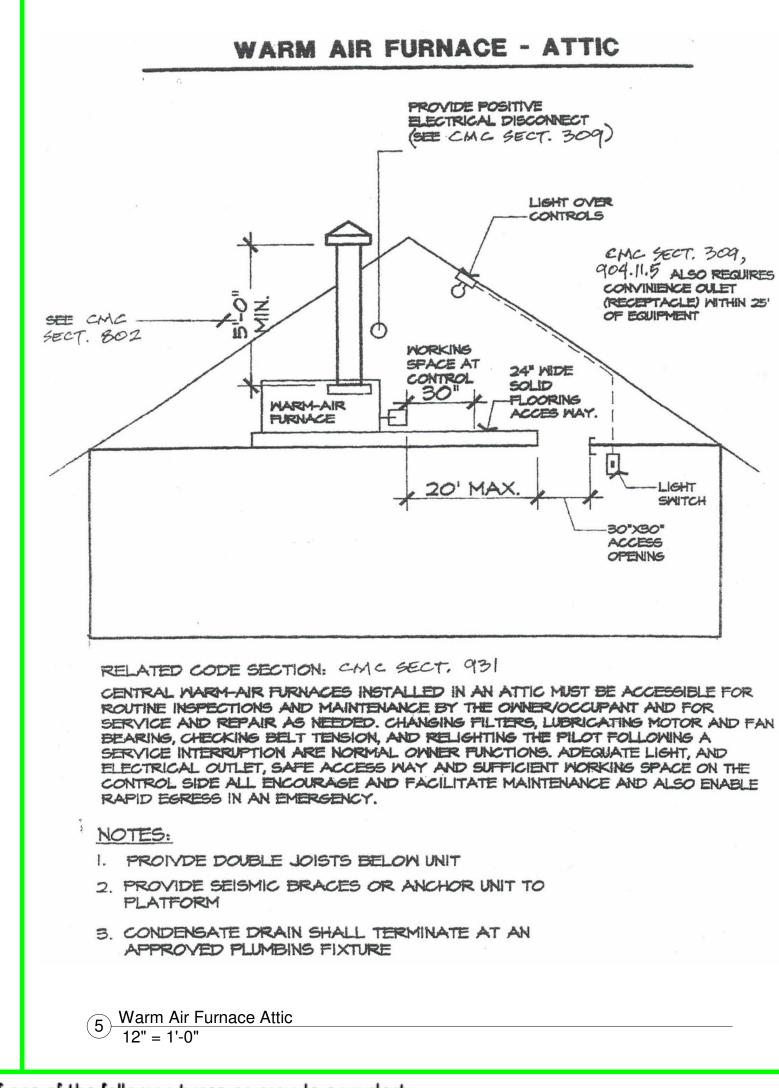
Project Status 1/4" = 1'-0' 11/25/2019 12:08:45 PM Revision:

No. Description Date

Drawing Number


A108








R3 I 1.5.6.3 Handrail grip size. All required handrails shall be of one of the following types or provide equivalent

- 1. Type I. Handrails with a circular cross section shall have an outside diameter of at least 1-1/4 inches (32 mm) and not greater than 2 inches (51 mm). If the handrail is not circular it shall have a perimeter dimension of at least 4 inches (102 mm) and not greater than 6-1/4 inches (160 mm) with a maximum cross section of dimension of 21/4 inches (57 mm).
- 2. Type II. Handrails with a perimeter greater than 6-1/4 inches (160mm)shall provide a graspable finger recess area on both sides of the profile. The finger recess shall begin within a distance of 3/4 inch (19 mm) measured vertically from the tallest portion of the profile and achieve a depth of at least 5/16 inch (8mm) within 7/8 inch (22mm) below The widest portion of the profile. This required depth shall continue for at least 3/8 inch (10mm) to a level that is not less than 1-3/4 inches (45 mm) below the tallest portion of the profile. The minimum width of the handrail above the recess shall be 1-1/4 inches (32 mm) to a maximum of 2-3/4 inches (70 mm). Edges shall have a minimum radius of 0.01 inches (0.25 mm).

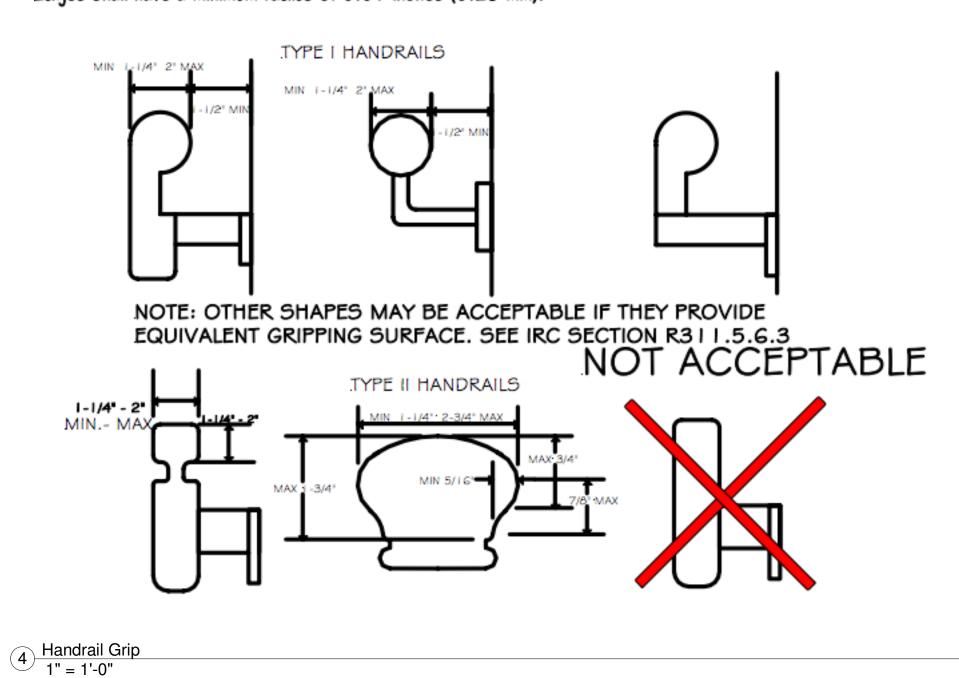

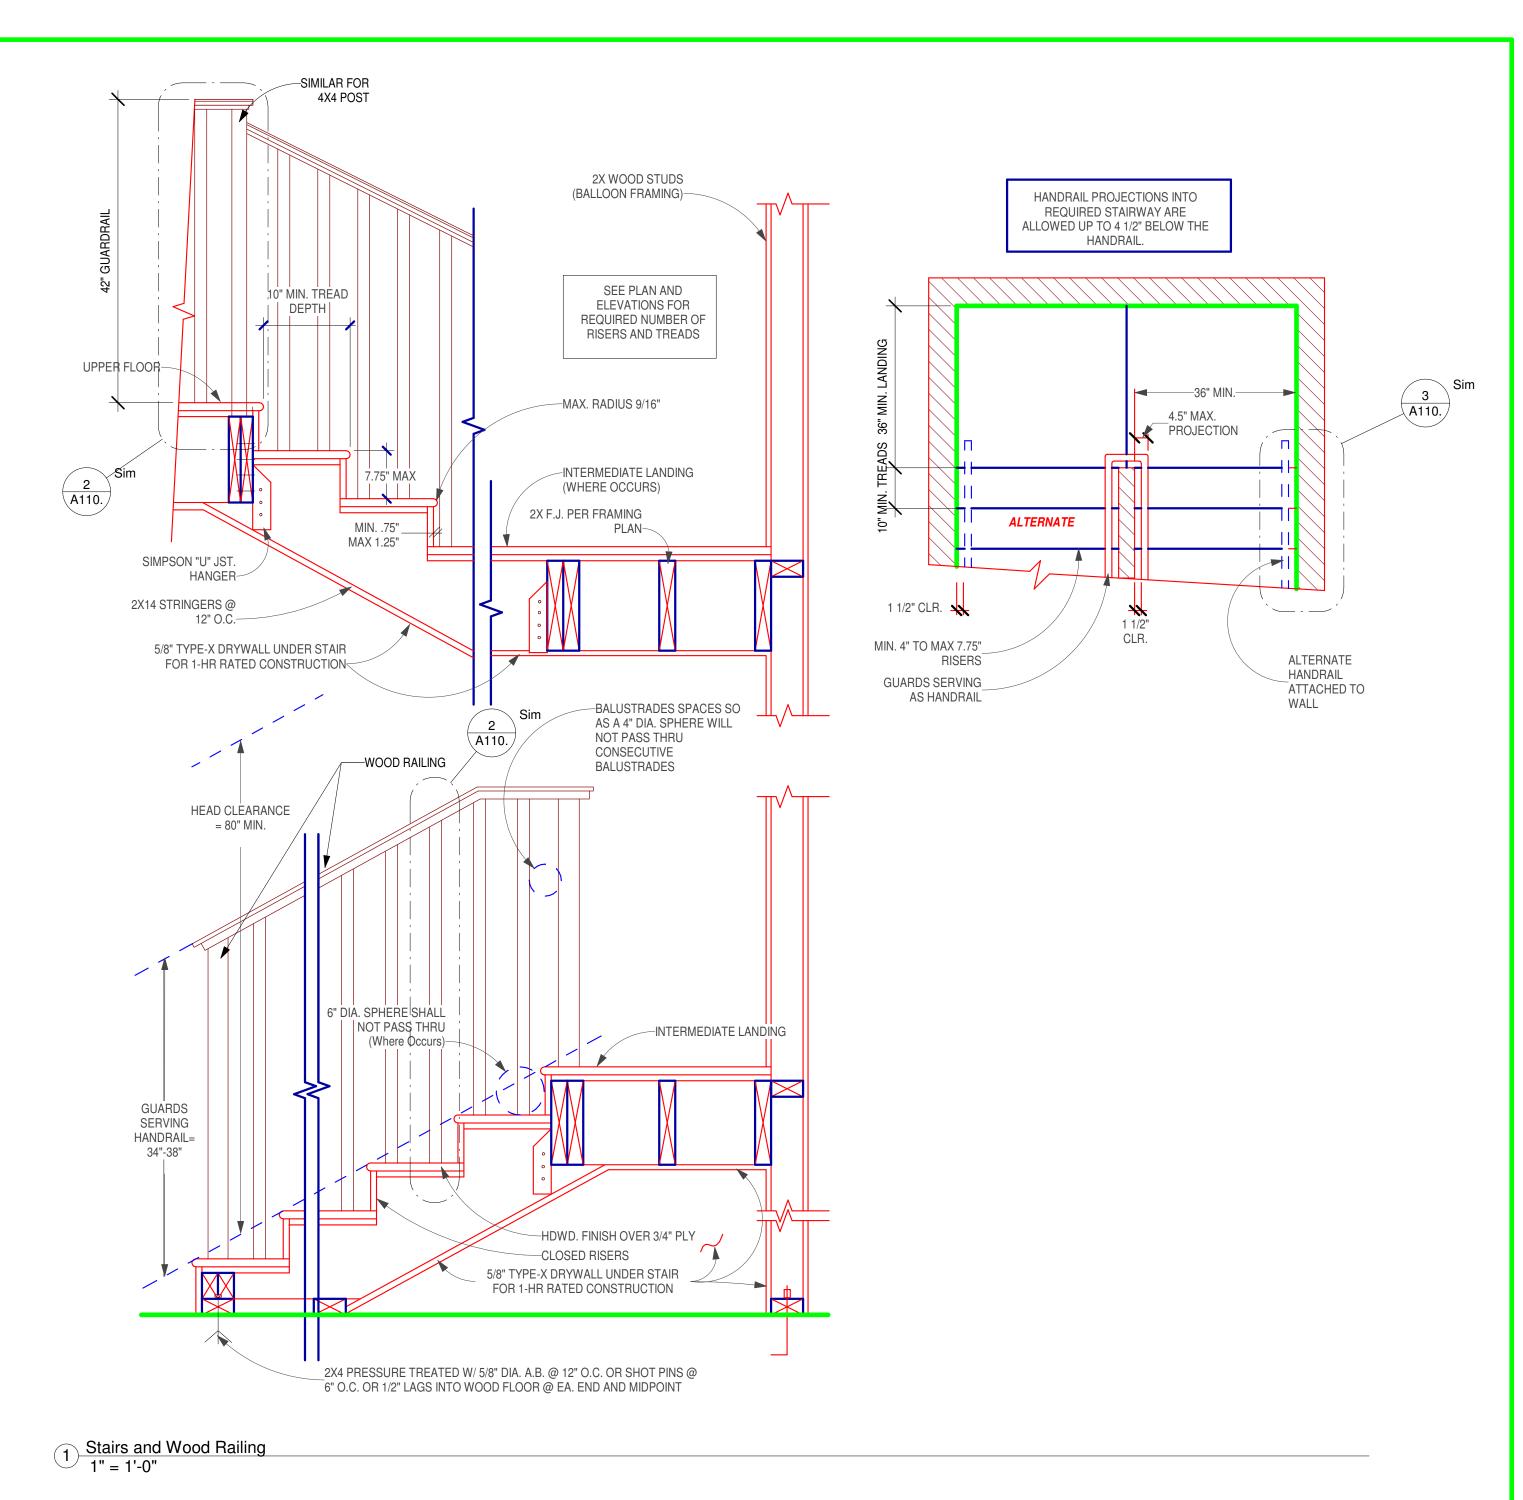

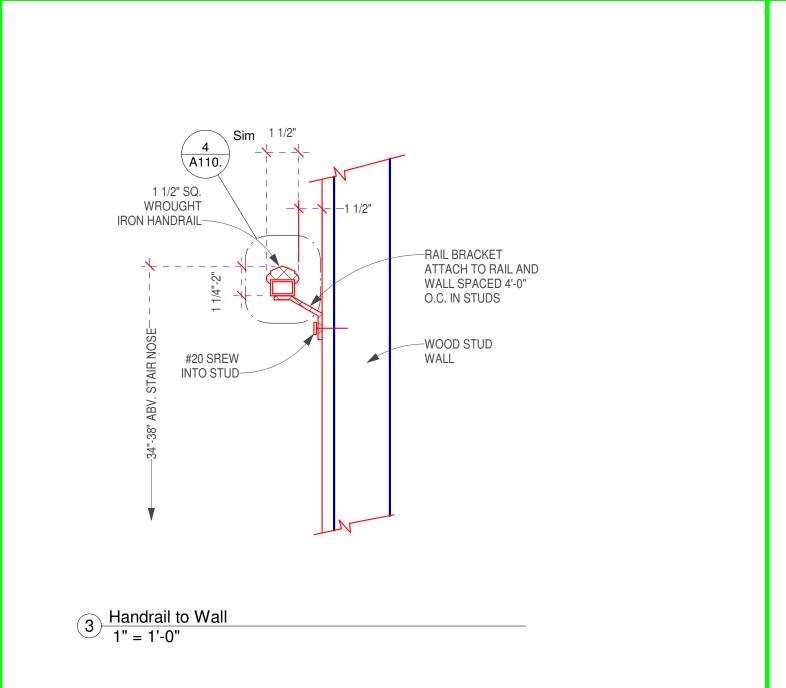

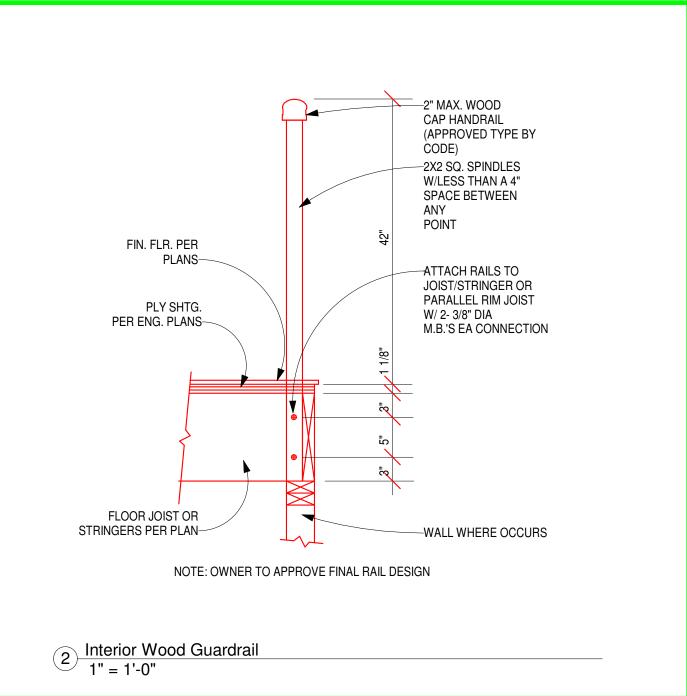



Design Group

Landscape Architects

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Project Status **Project Status**


As indicated

11/25/2019 12:08:46 PM

Revision: No. Description Date

A110.

Drawing Number

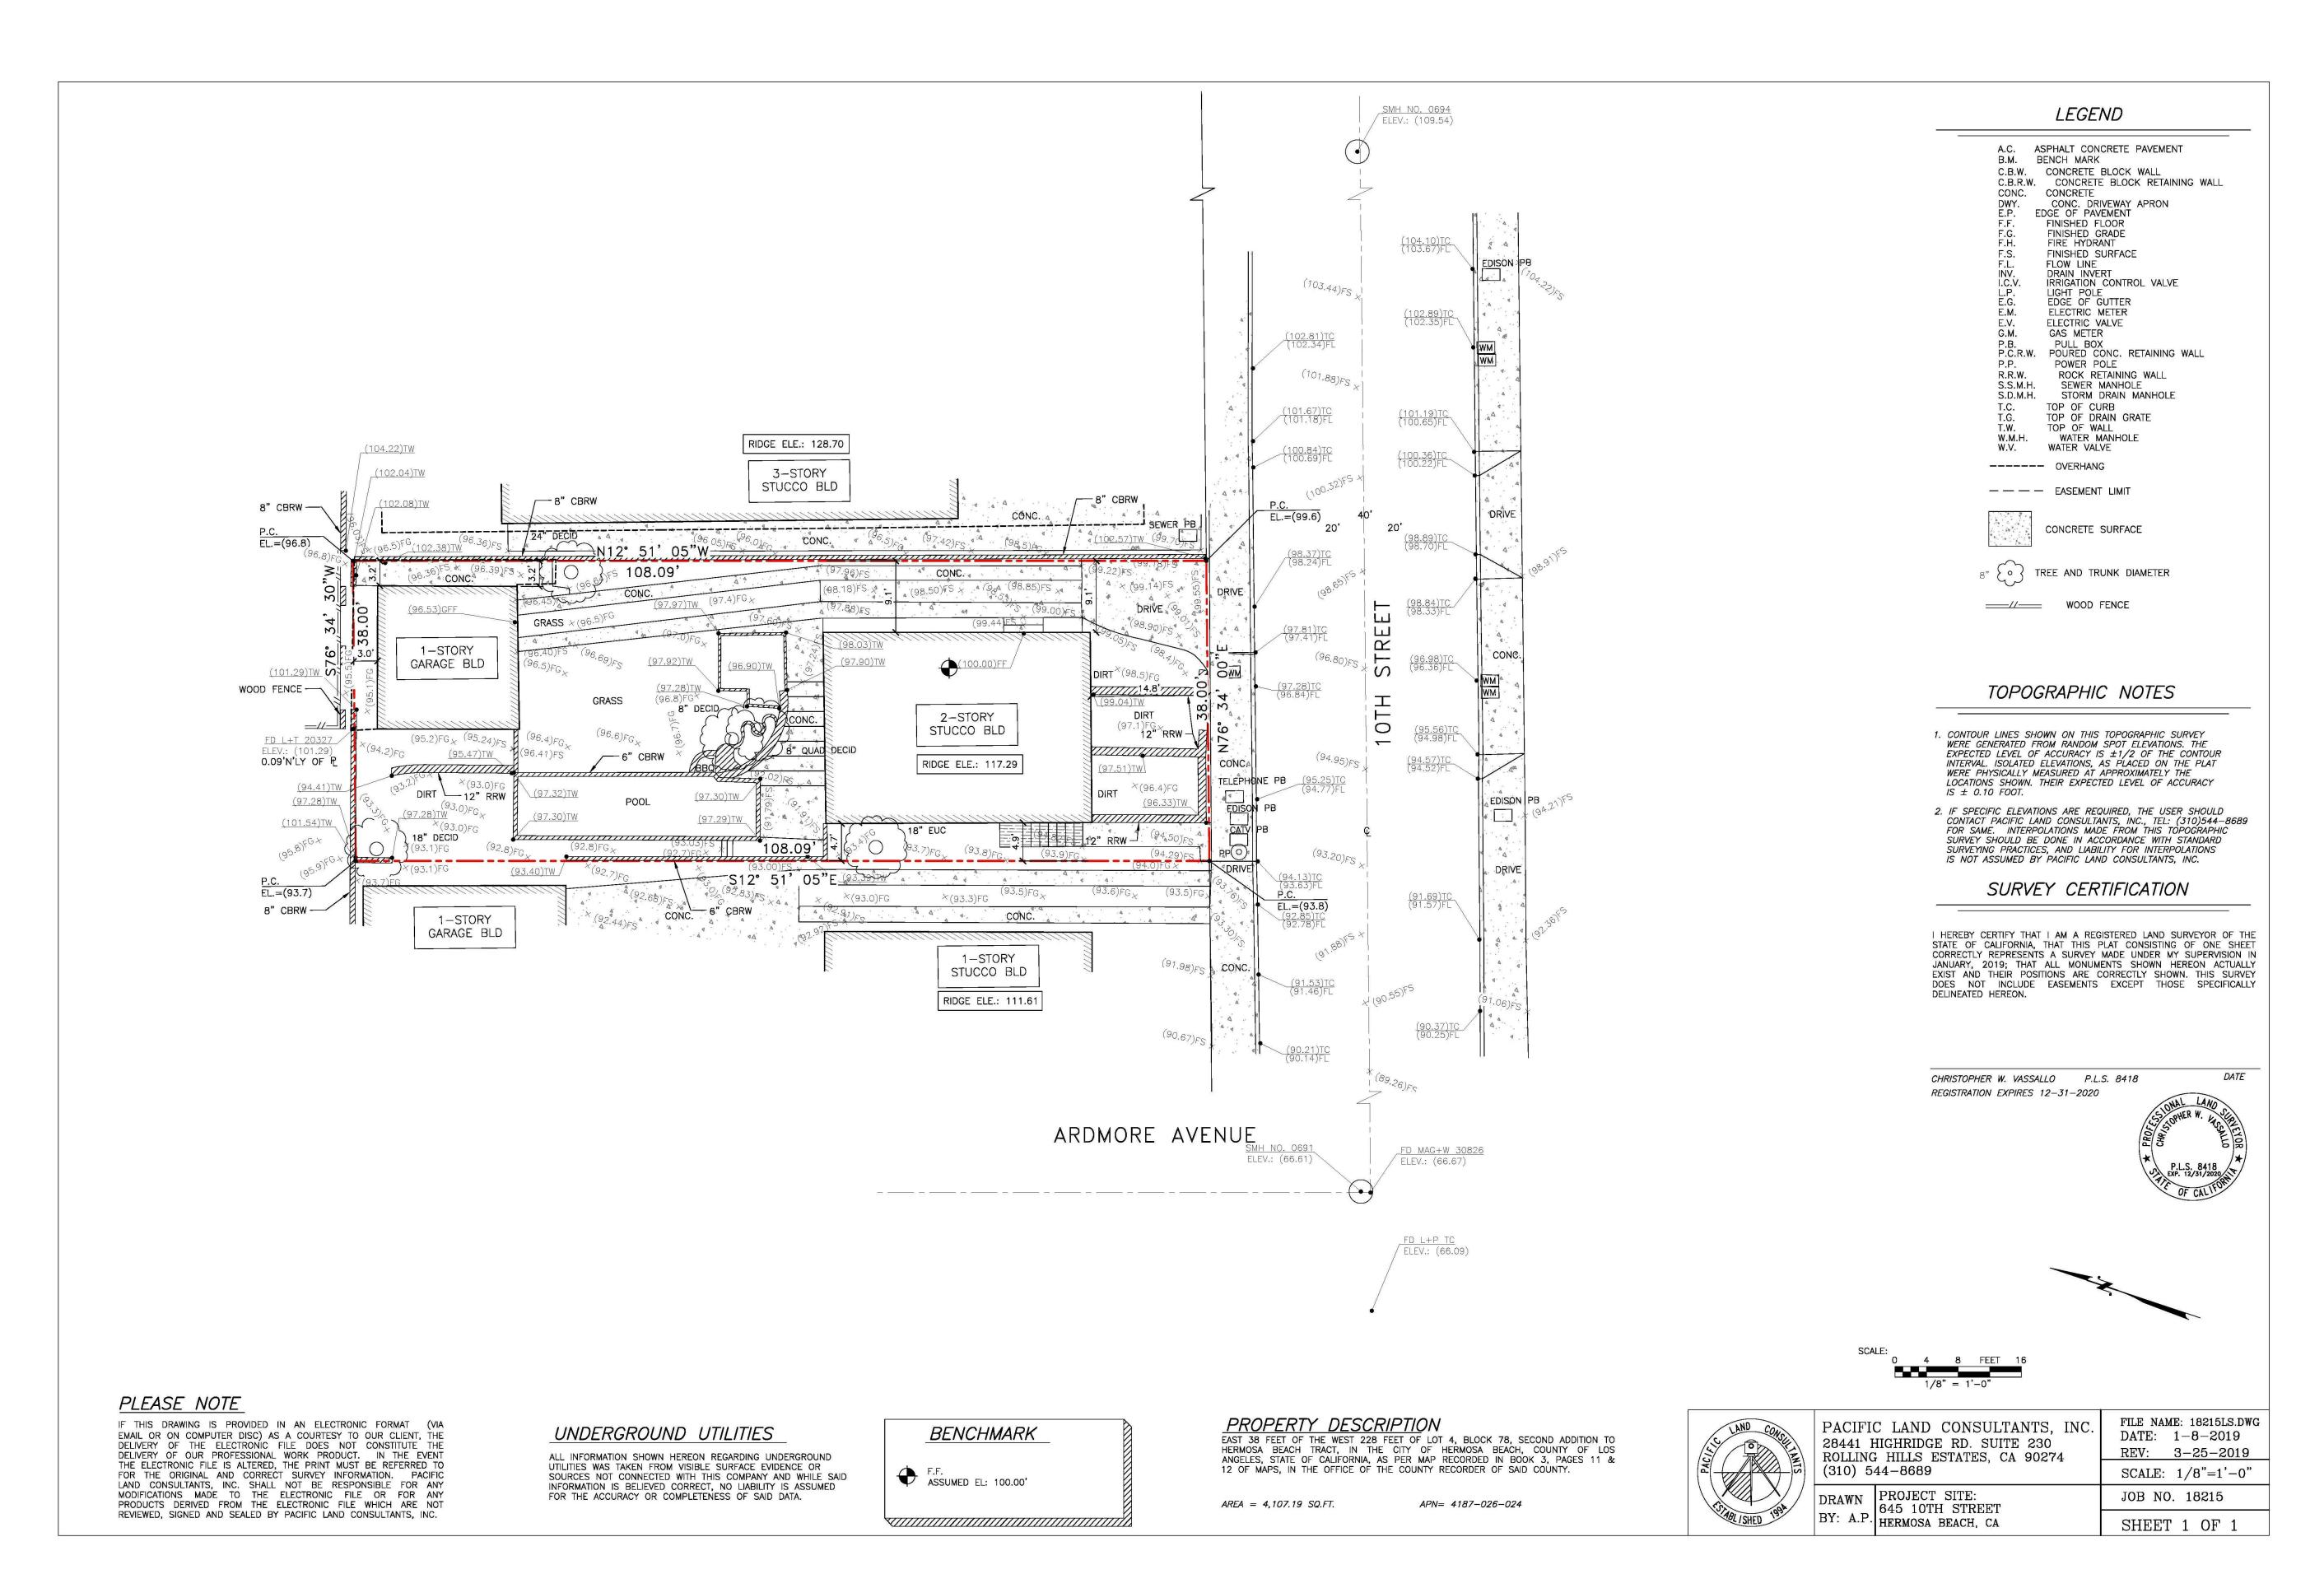

Landscape Design **Planners** 2100 N. Sepulveda Blvd. Suite 44, Manhattan Beach, CA 90266 Tel (310) 546-5550 FAX (310) 546-9250 aga@agarchitecture.com www.agarchitecture.com Project Status Project Status 1" = 10'-0" 11/25/2019 12:08:47 PM Revision: No. Description Date

Drawing Number

SURVEY 1" = 10'-0"





NORTH ELEVATION

WEST ELEVATON





EAST ELEVATION

Landscape Design Planners

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R-01